

Addendum No. 02 <u>Boeckman Creek Sanitary Sewer Interceptor</u> <u>and Trail Design and Construction Support</u> <u>City of Wilsonville Project #2107, 9150</u>

Issue Date:	April 29, 2022
То:	Plan Holders (Quest CDN# 8183576)
From:	Matt Palmer, P.E. – Civil Engineer
RE:	Clarifications and revisions to the request for proposal

The following Addenda to the Request for Proposal (RFP) shall be considered merged with the original RFP as if they were whole. Proposer shall acknowledge receipt of this Addendum as stated in the RPF.

Request for Proposal due date and time: May 11, 2022, 2:00 PM. NO CHANGE

CLARIFICATIONS

ITEM #1: A design element of the Boeckman Creek Sanitary Sewer Interceptor project that was not explicitly stated within the RFP was creek crossings of the interceptor line. Attachment B-4 (Boeckman Creek Trunk Sewer, As-Built # 1979 07 001) of the RFP shows the following three existing creek crossing locations:

As-Built Sheet	RFP Page No.	Stationing
Sheet 2A	Page 69	STA 13+78
Sheet 3A	Page 68	STA 19+64
Sheet 3A	Page 68	STA 22+65

CHANGES, ADDITIONS, AND DELETIONS


ITEM #2: The following addition has been made to the RFP:

Attachment B-5 (attached). Boeckman Creek Fish Passage and Stream Restoration Project (As-Built # 2007 04 002).

Attachment B5

Boeckman Creek Fish Passage and Stream Restoration Project (As-Built # 2007 04 002)

BOECKMAN CREEK JLVERT REPLACEMEN SIT С С

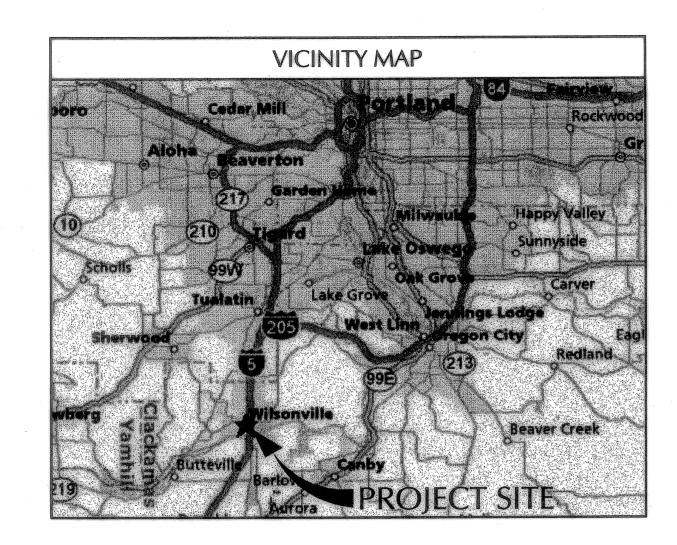

PROJECT CONTACTS			
CONTACT	ADDRESS		
 CITY CONTACT: JOHN MICHAEL (503) 570–1540 michael@ci.wilsonville.or.us	CITY OF WILSONVILLE 29799 SW TOWN CENTER LOOP E WILSONVILLE, OR 97070		
PROJECT MANAGER: CURT VANDERZANDEN (503) 227-3251 curt.vanderzanden@kpffcivilpdx.com	KPFF CONSULTING ENGINEERS 111 SW 5TH AVENUE, SUITE 2500 PORTLAND, OR 97204-3628		
CIVIL ENGINEER CONTACT: LAURA VANDERVORT (503) 227-3251 laura.vandervort@kpffcivilpdx.com	KPFF CONSULTING ENGINEERS 111 SW 5TH AVENUE, SUITE 2500 PORTLAND, OR 97204-3628		
STRUCTURAL ENGINEER CONTACT: STEPHEN WHITTINGTON (503) 227–3251 stephen.whittington@kpff.com	KPFF CONSULTING ENGINEERS 111 SW 5TH AVENUE, SUITE 2500 PORTLAND, OR 97204-3628		
HABITAT RESTORATION: JOHN VAN STAVEREN (503) 570–0800 jvs@pacifichabitat.com	PACIFIC HABITAT SERVICES, INC. 9450 SW COMMERCE CIRCLE, SUITE 180 WILSONVILLE, OR 97070		
PLANTING: DENNIS O'CONNOR (503) 617–6553 habitatconcepts@verizon.net	HABITAT CONCEPTS PO BOX 91231 PORTLAND, OR 97291		
GEOTECHNICAL ENGINEER: TIMOTHY PFEIFFER (503) 643–1541 tjp@foundationengr.com	FOUNDATION ENGINEERING, INC. 8380 SW NIMBUS AVE. BEAVERTON, OR 97008		

UTILITY COMP	PANY CONTACTS
CONTACT	ADDRESS
PHONE: LAURA FLAHERTY (503) 644-9848 laura.a.flaherty@verizon.com	VERIZON P.O. BOX 1100 BEAVERTON, OR 97005
POWER: RAY LAMBERT (503) 570-4413 raymond.lambert@pgn.com	PORTLAND GENERAL ELECTRIC 9480 SW BOECKMAN ROAD WILSONVILLE, OR 97070
NATURAL GAS: RYAN TRUAIR (503) 226-4211 x3047 ryan.truair@nwnatural.com	NORTHWEST NATURAL GAS 19200 SW TETON AVENUE TUALATIN, OR 97062

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\triangle	04/11/2008	AS-CONSTRUCTED DRAWINGS		
REVISION	DATE	DESCRIPTION	BY	

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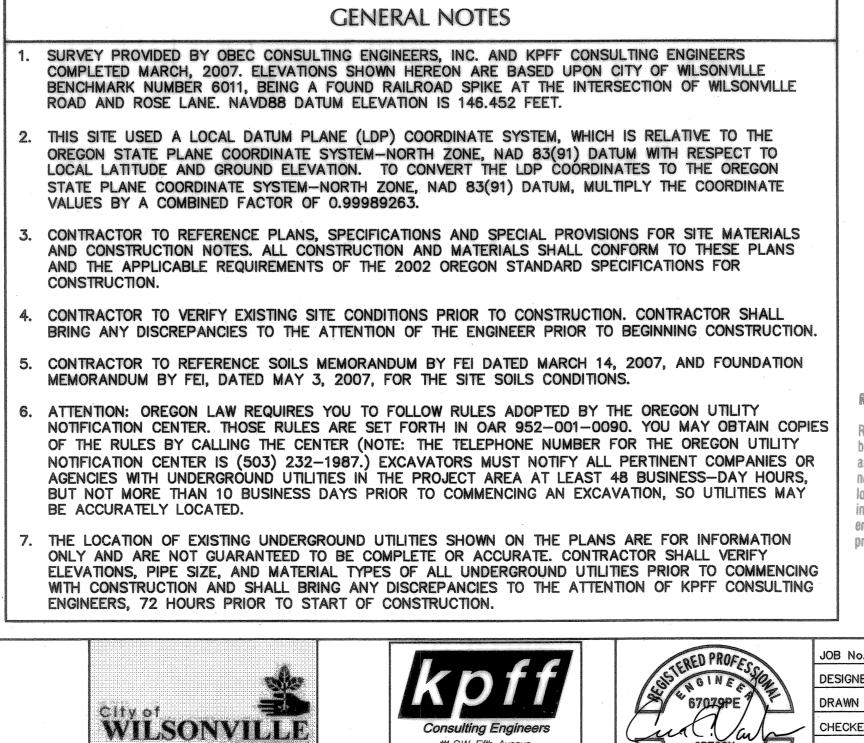


BOECKMAN CREEK FISH PASSAGE STREAM RESTORATION PROJECT UPPER SITE (KOLBE LANE)

DRA	WING INDEX
SHEET NUMBER	SHEET NAME
C1	COVER SHEET
C2	CONSTRUCTION STAGING PLAN & SECTIONS
C3	STREET & STORM DRAINAGE PLAN
C4	STREET & STORM DRAINAGE PROFILES
C5	SANITARY SEWER & WATER PLAN
C5.1	SANITARY SEWER EXTENSION PLAN &
C6	SANITARY SEWER & WATER PROFILES
C7	WORK ISOLATION PLAN
C8	DETAILS
C9	STANDARD DETAILS
C10	STANDARD DETAILS
C11	STANDARD DETAILS
C12	STANDARD DETAILS
S1	BRIDGE PLAN & ELEVATION
S2	FOUNDATION DATA
S3	FOUNDATION PLAN
S4	BENT 1 & 2 PLAN & ELEVATION
S5	BENT 1 & 2 DETAILS
S6	WINGWALL DETAILS
LS1	SITE PLAN AND EXISITNG FINAL SITES
LS2	PLANTING PLAN, DETAILS AND PLANT LIST
LS3	EROSION CONTROL PLAN AND DETAILS
LS4	BIO-ENGINEERING
LS5	BIO-ENGINEERING DETAILS

RECORD DRAWING

THIS DRAWING HAS BEEN UPDATED TO REFLECT CHANGES MADE DURING CONSTRUCTION BASED UPON CONSTRUCTION INSPECTOR'S NOTES AND AS-BUILT SURVEY MEASUREMENTS PERFORMED DURING CONSTRUCTION.




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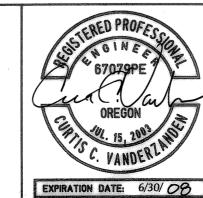
JOB No.:	307020.00
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PLOT DATE:	4/22/08 4:56pm
PLOTTED BY:	jcadua
DWG NAME:	7020CV.DWG
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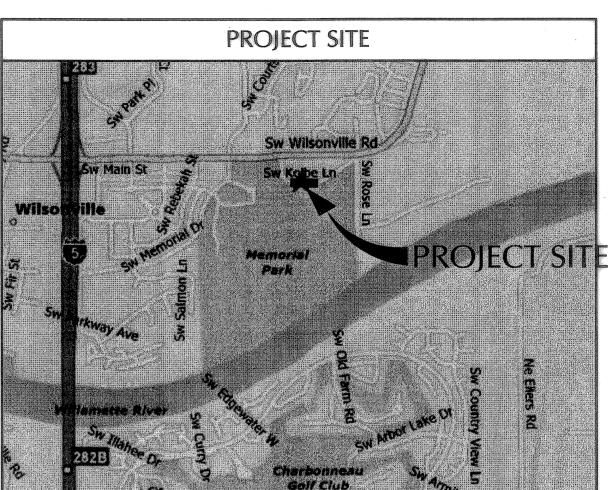
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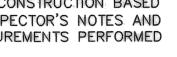
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tti S.W. Fifth Avenue Suite 2400 Portland, Oregon 97204 (503) 227-3251 STRUCT. FAX (503) 227-7980 CIVIL FAX (503) 274-4681





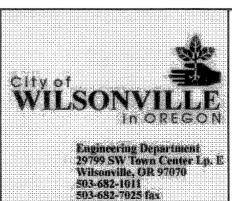

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ELECT.	ELECTRICAL
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FG	FINISH GRADE
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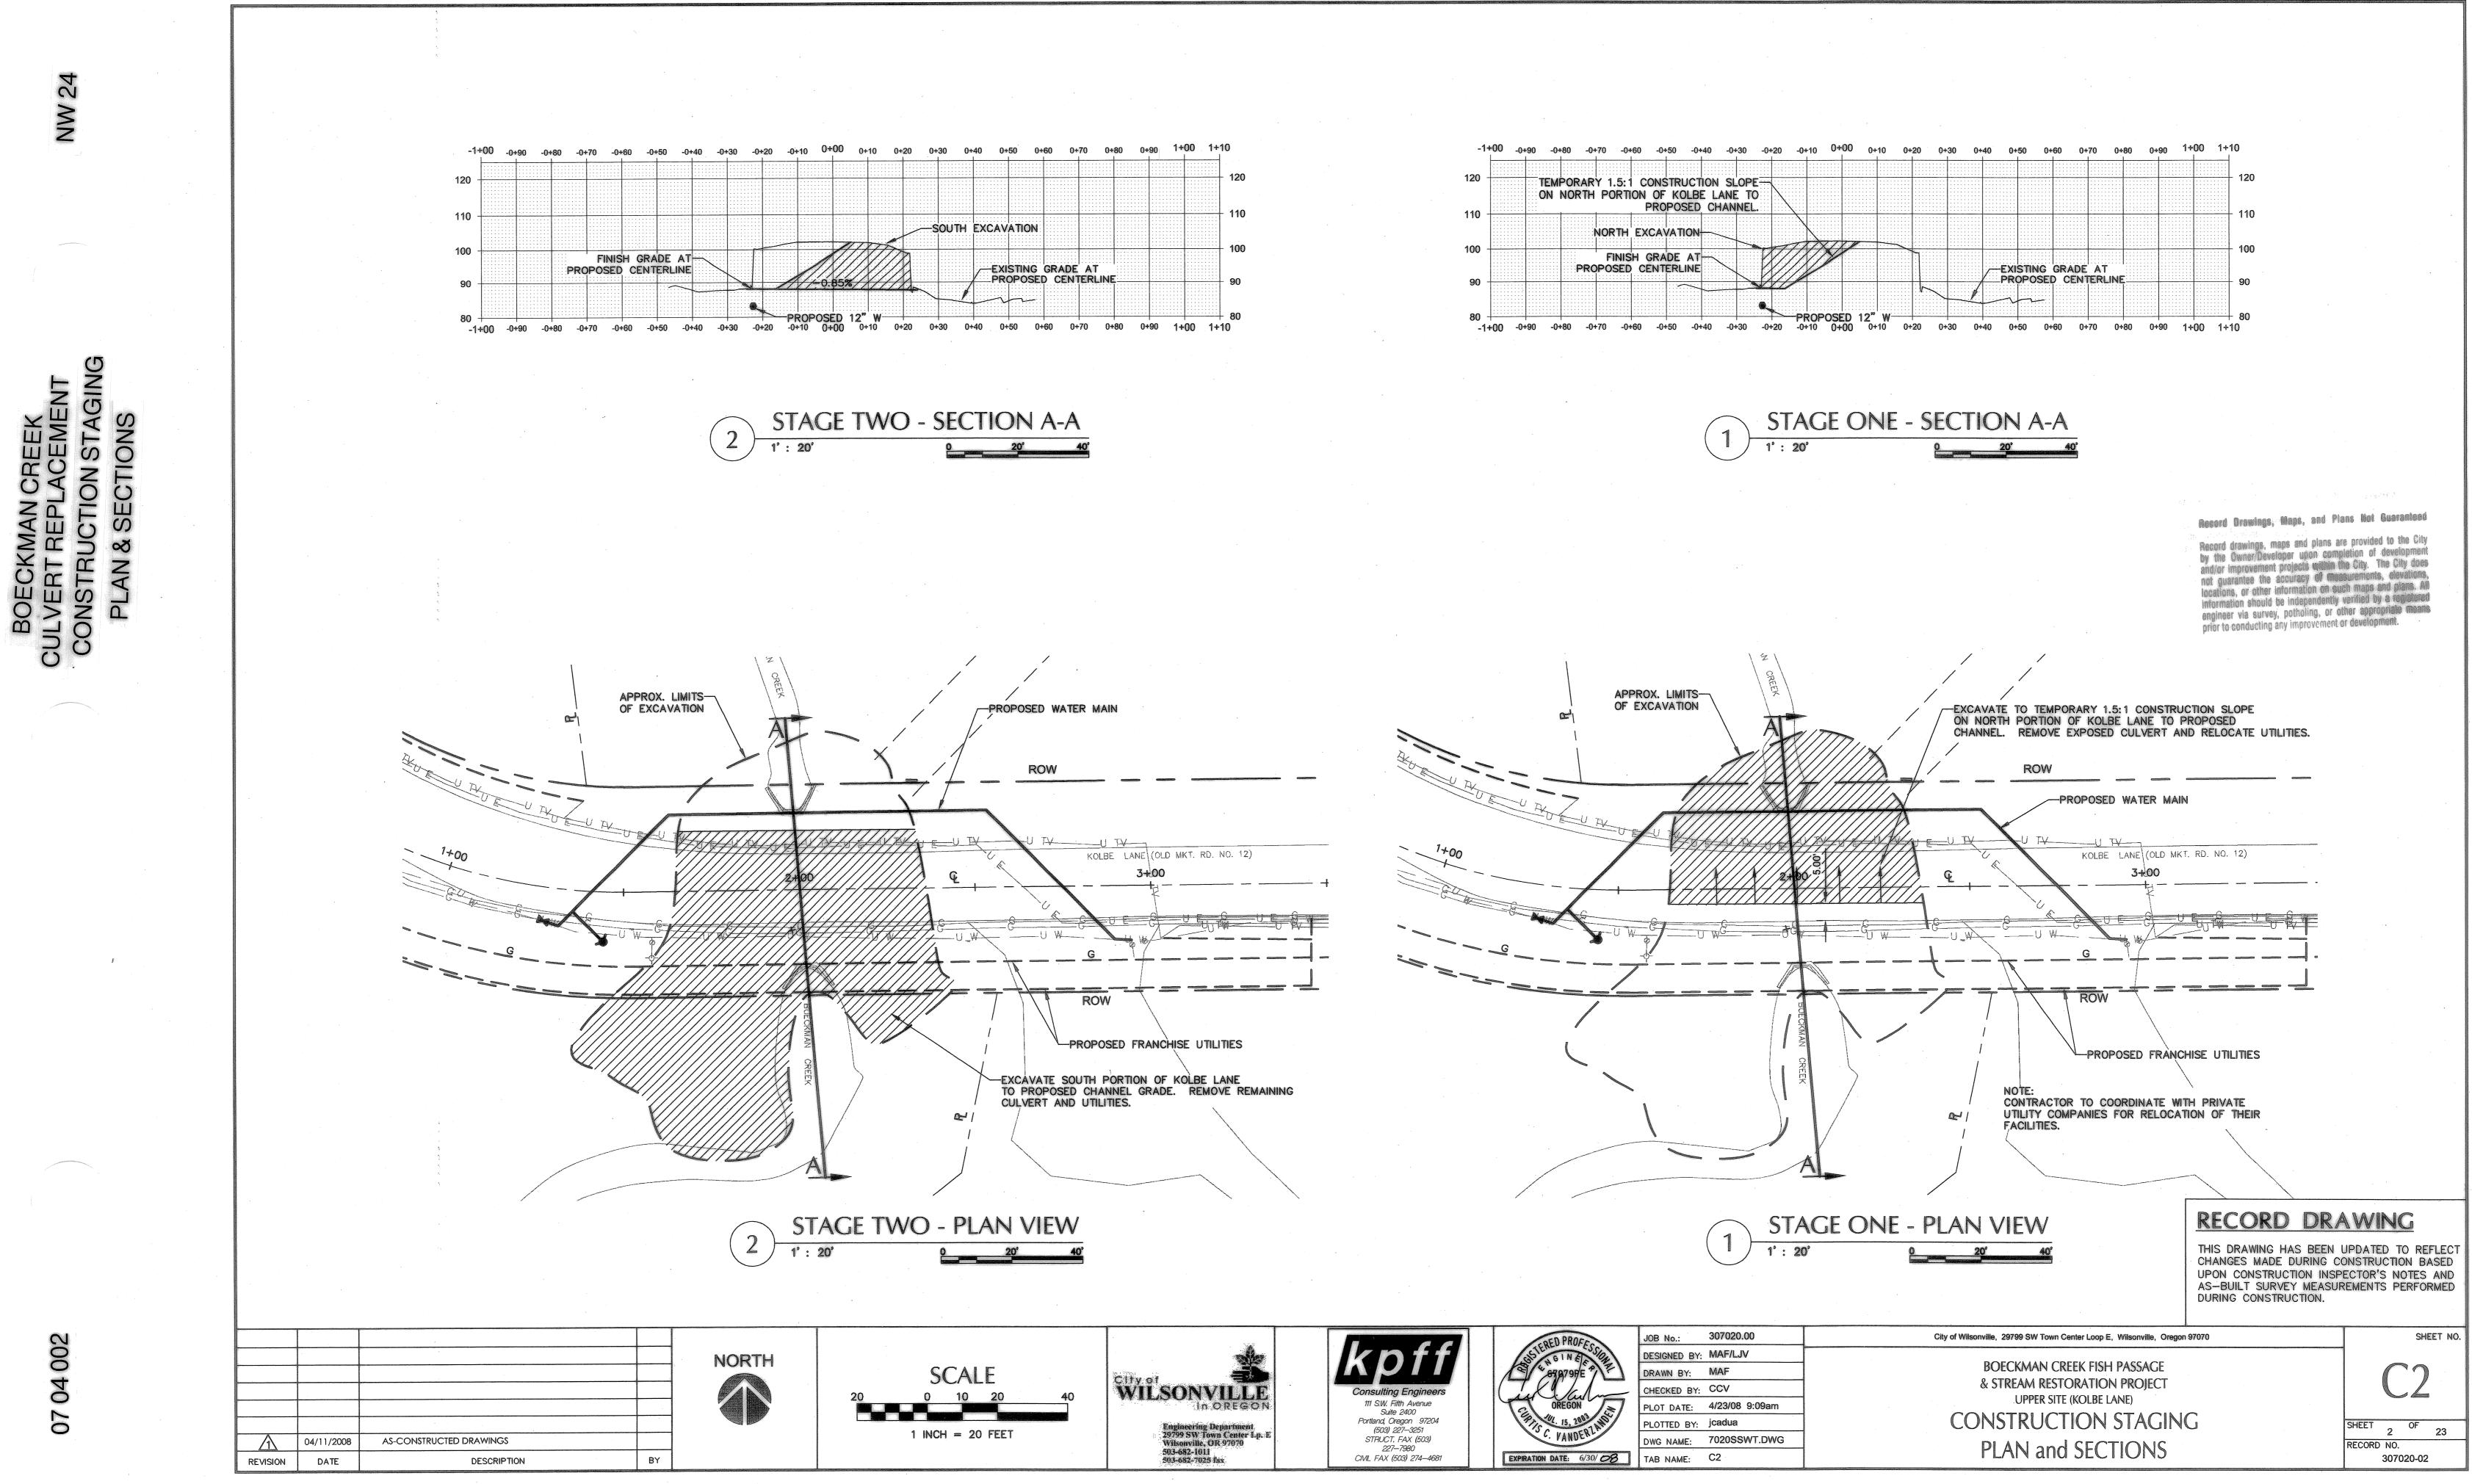
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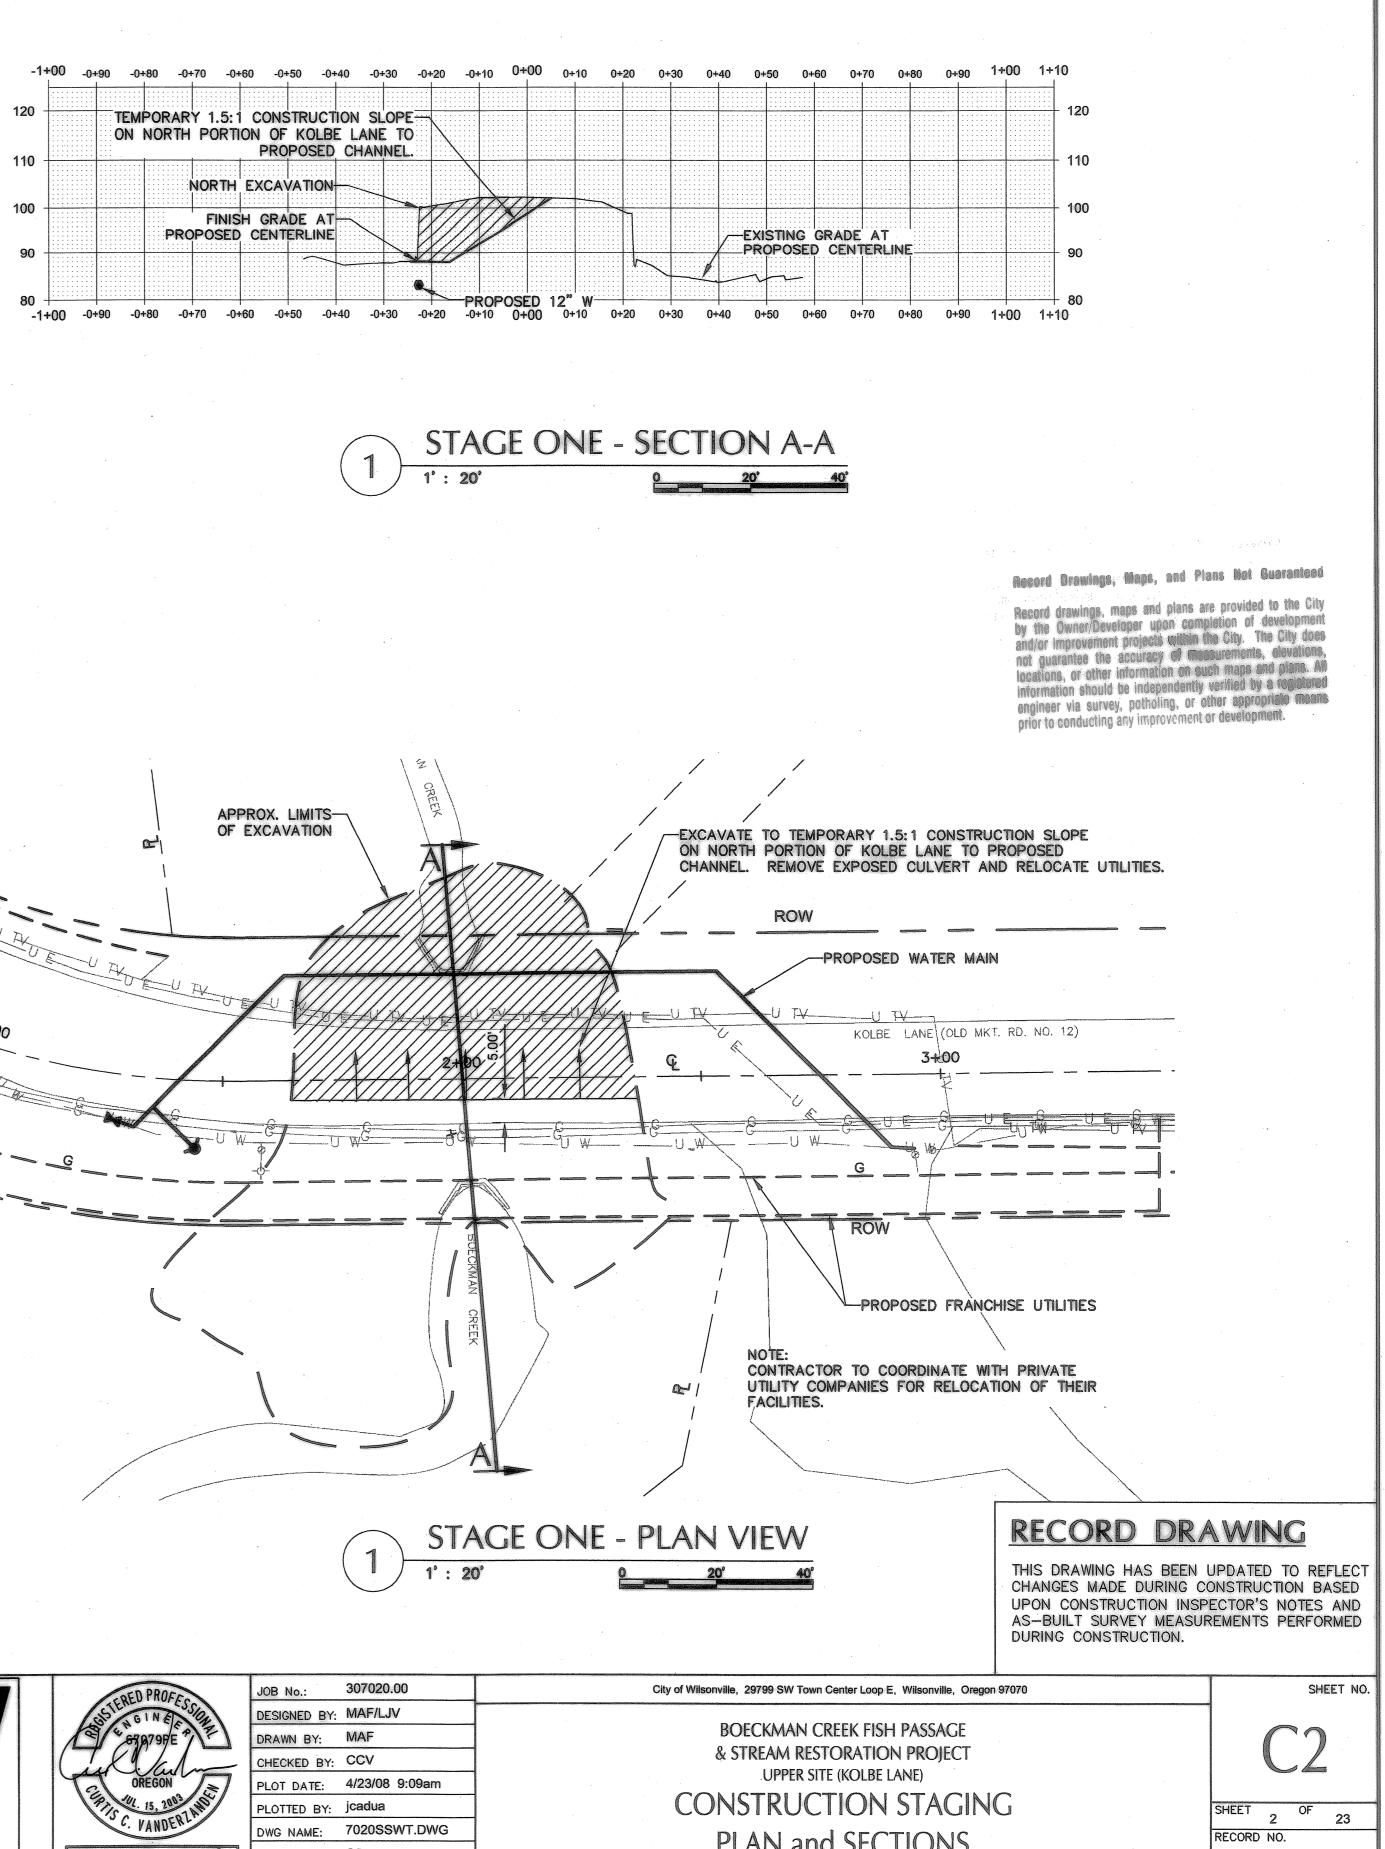
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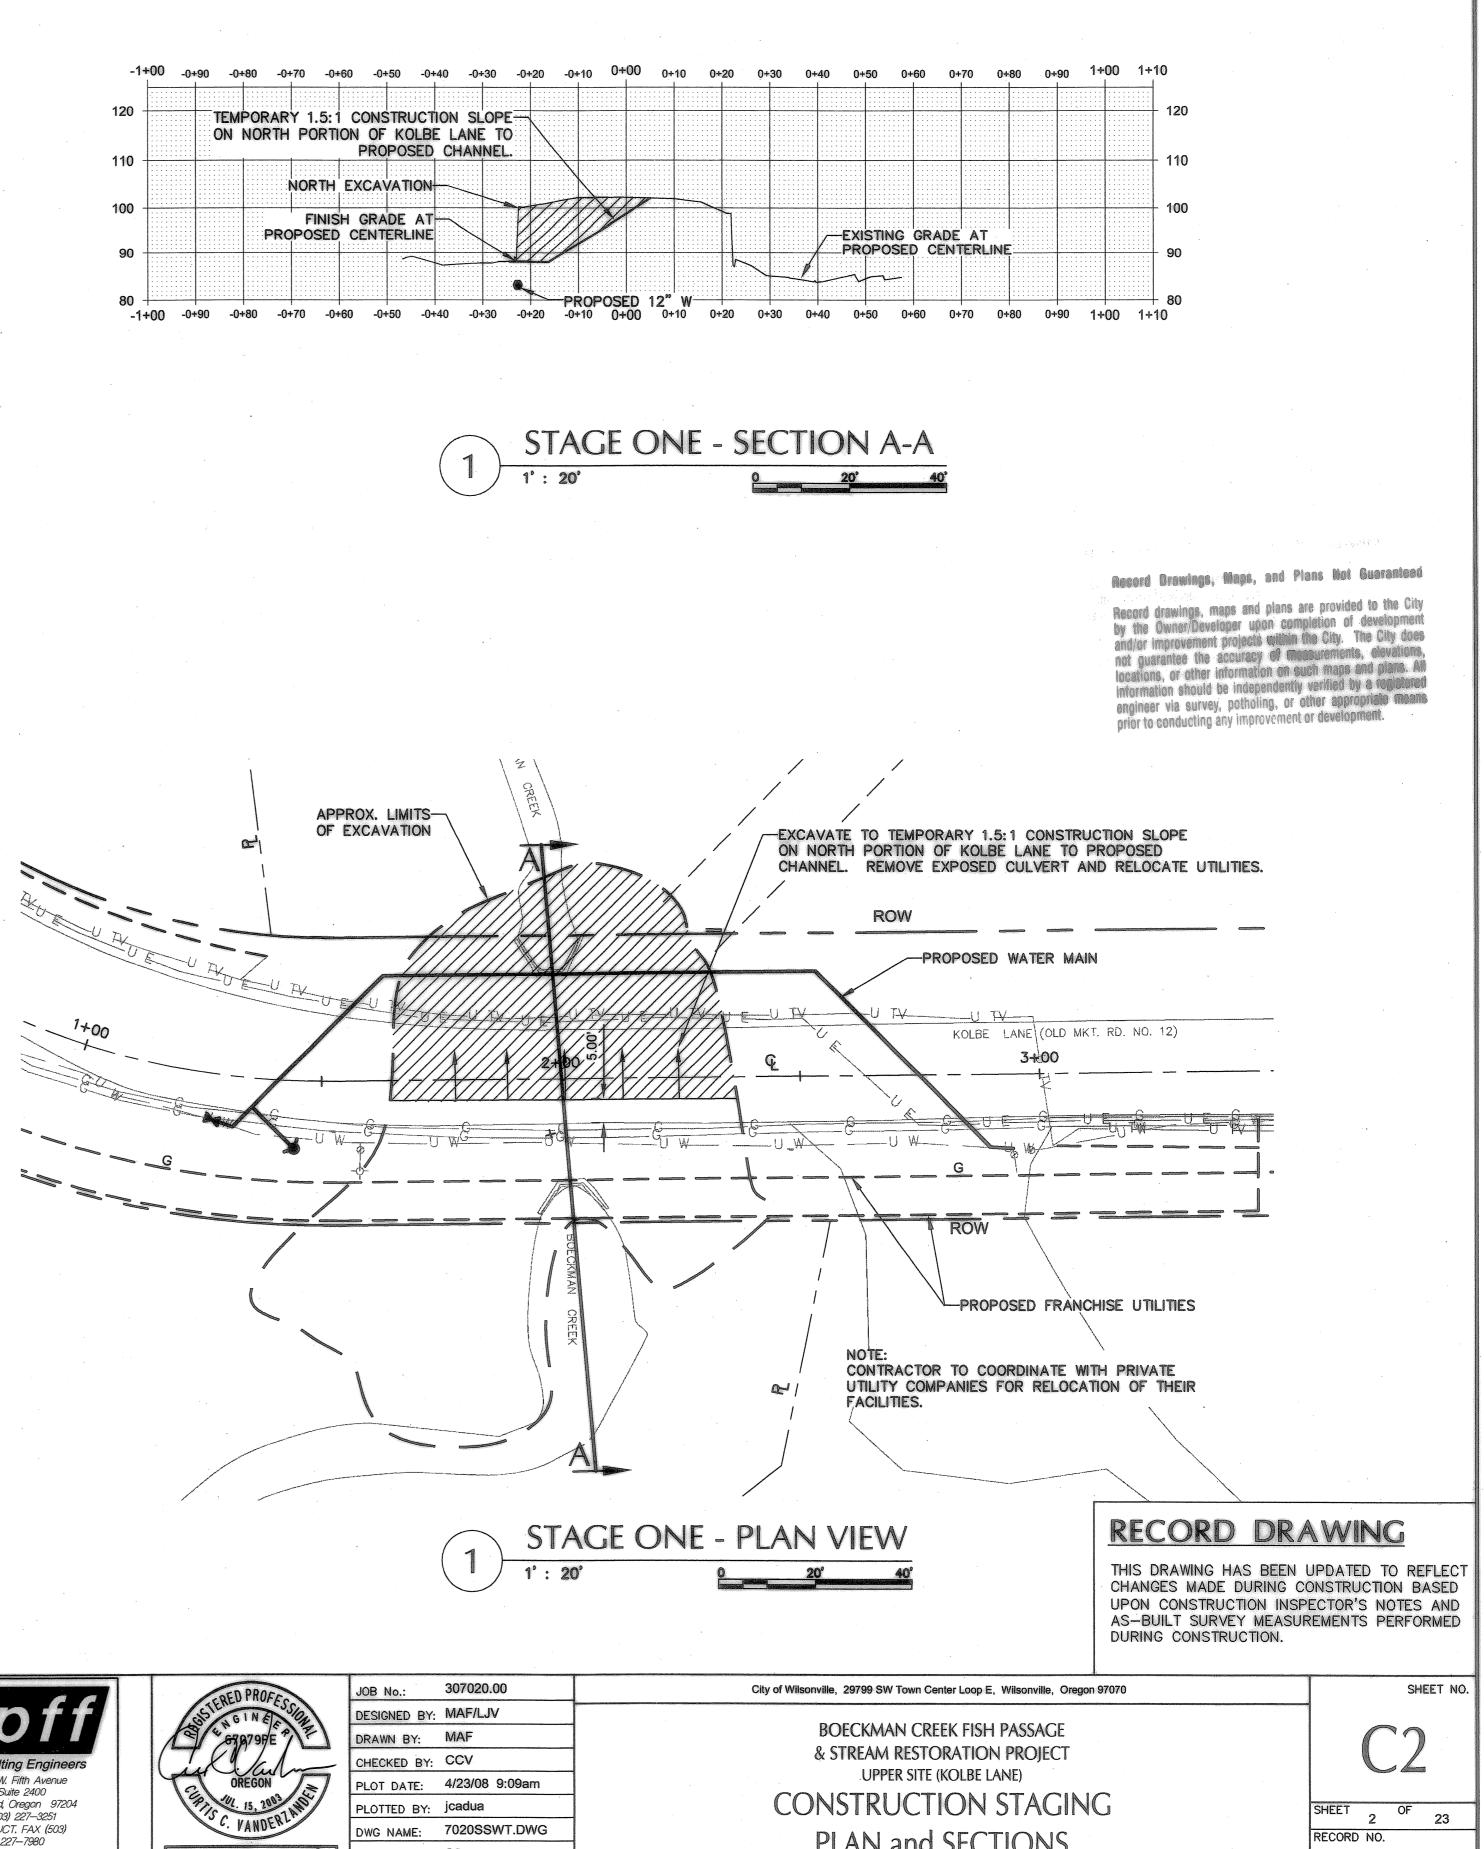
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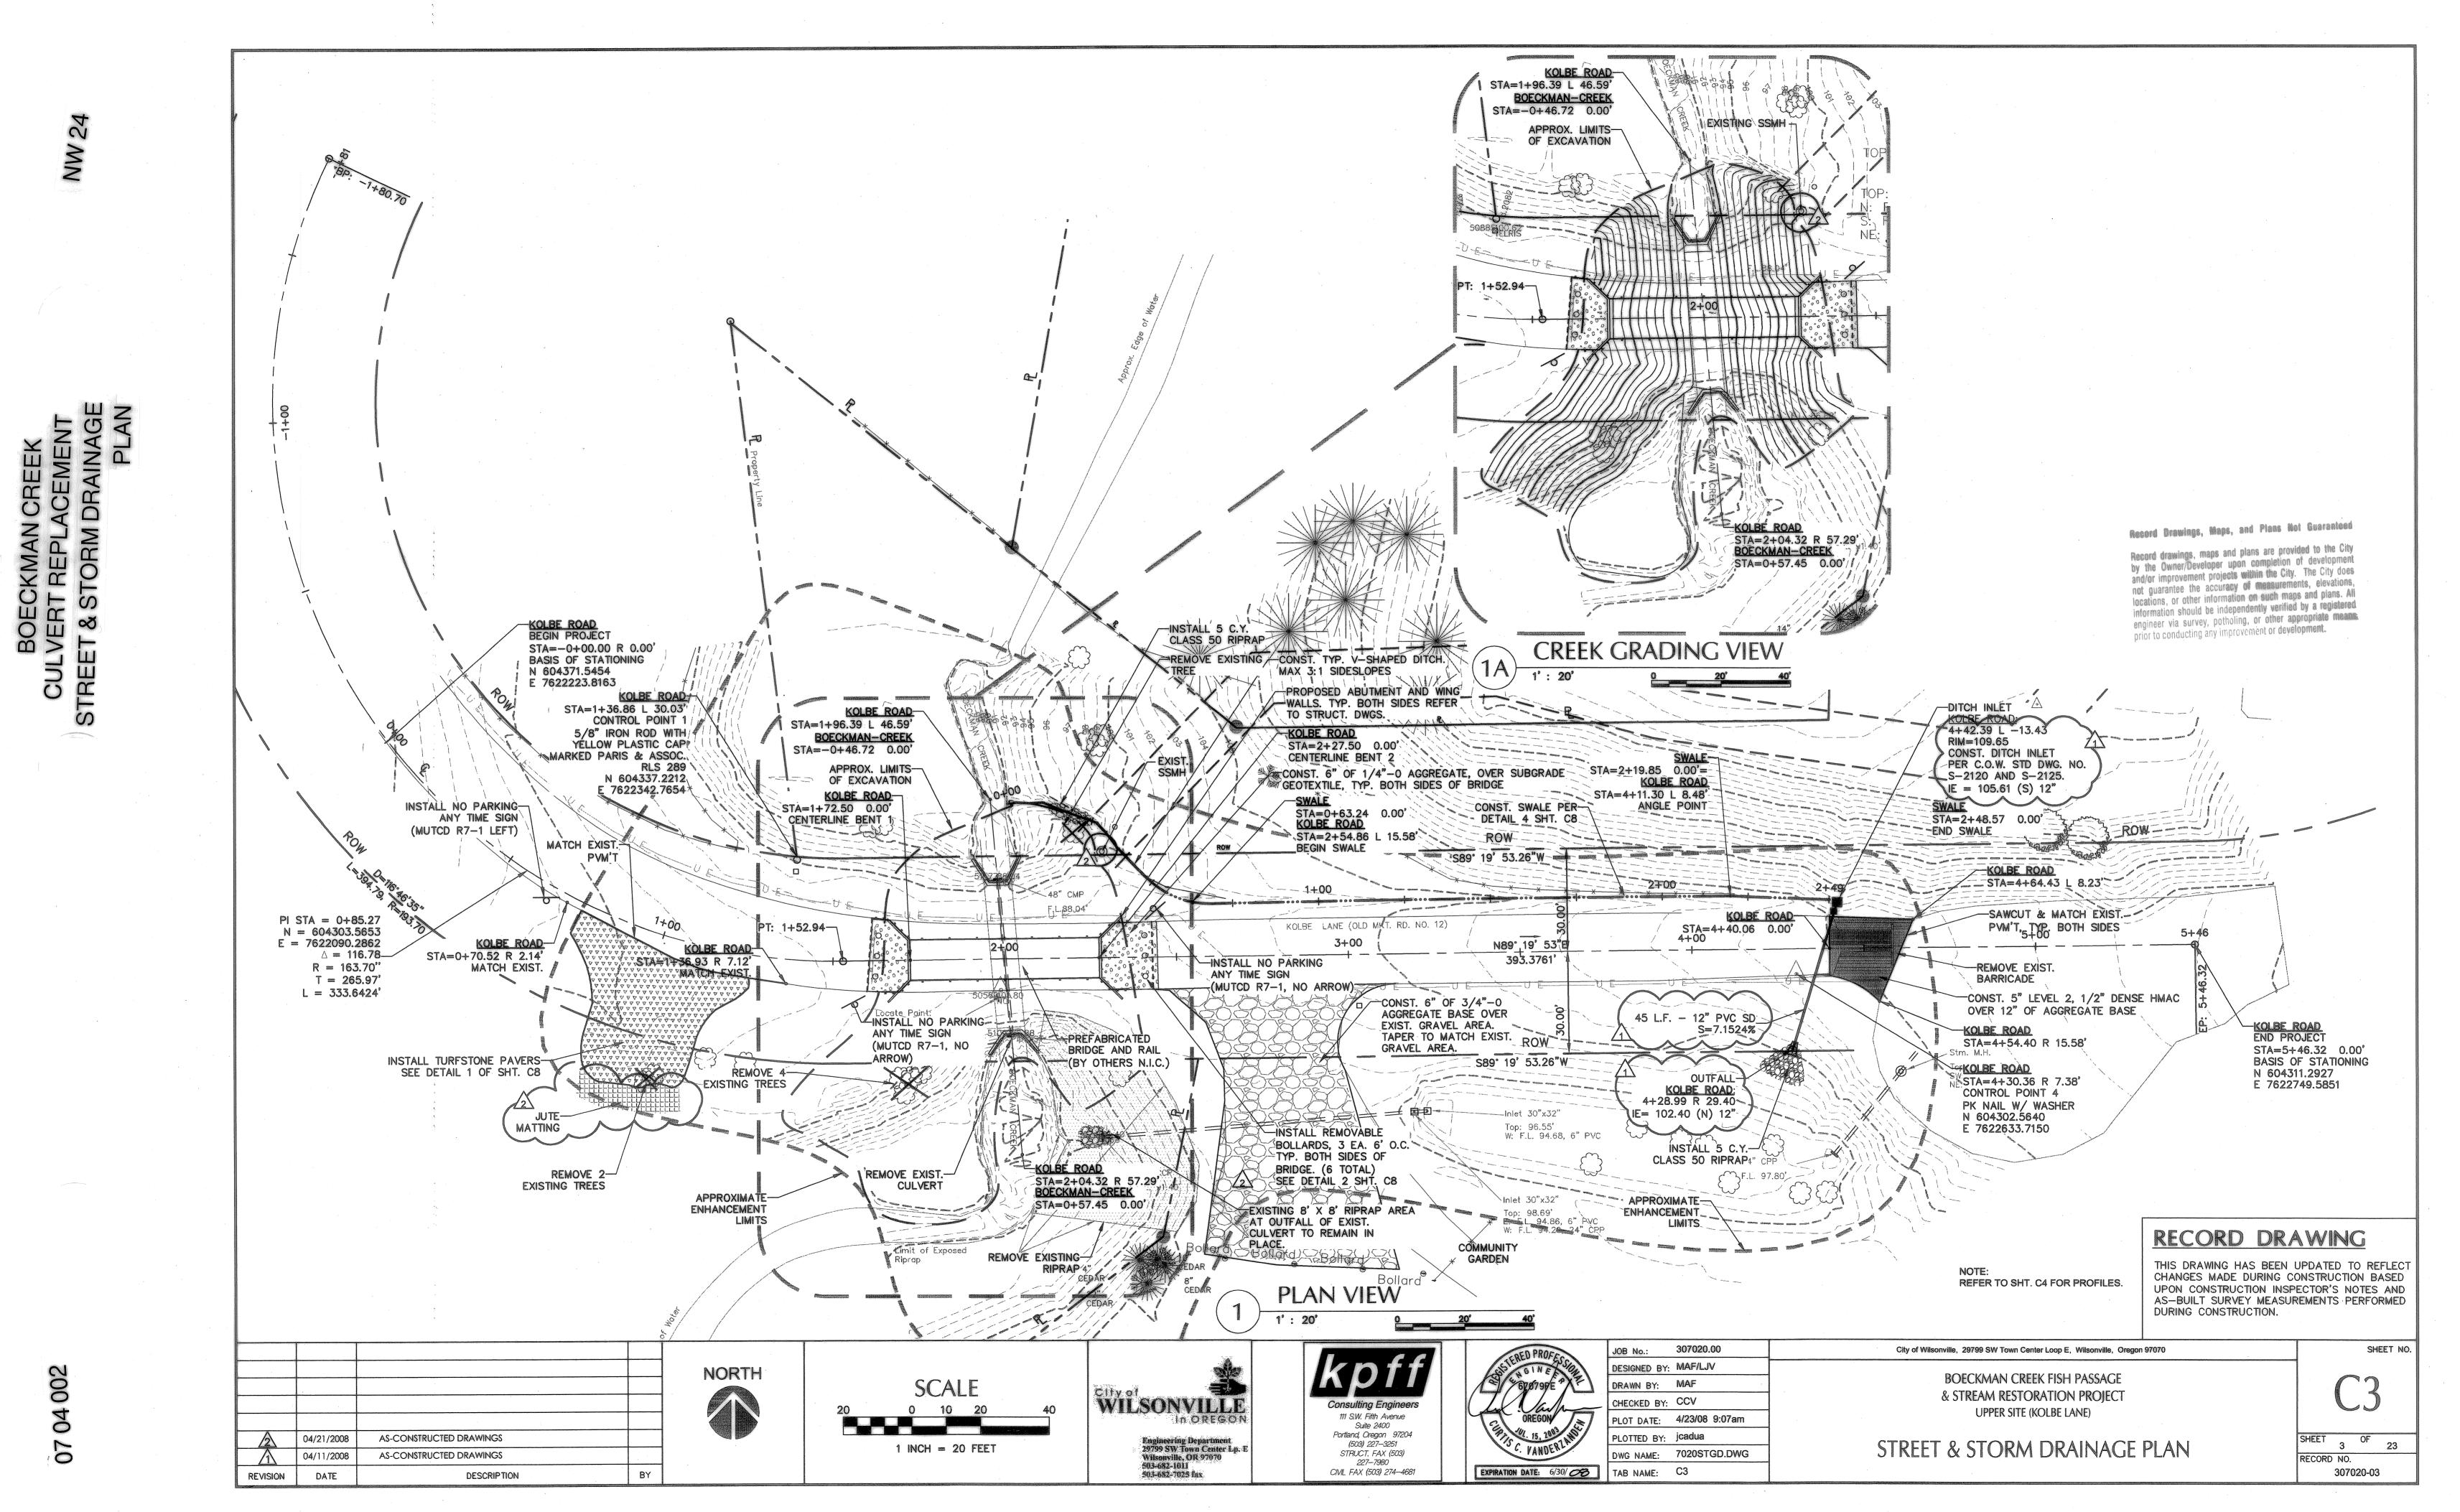
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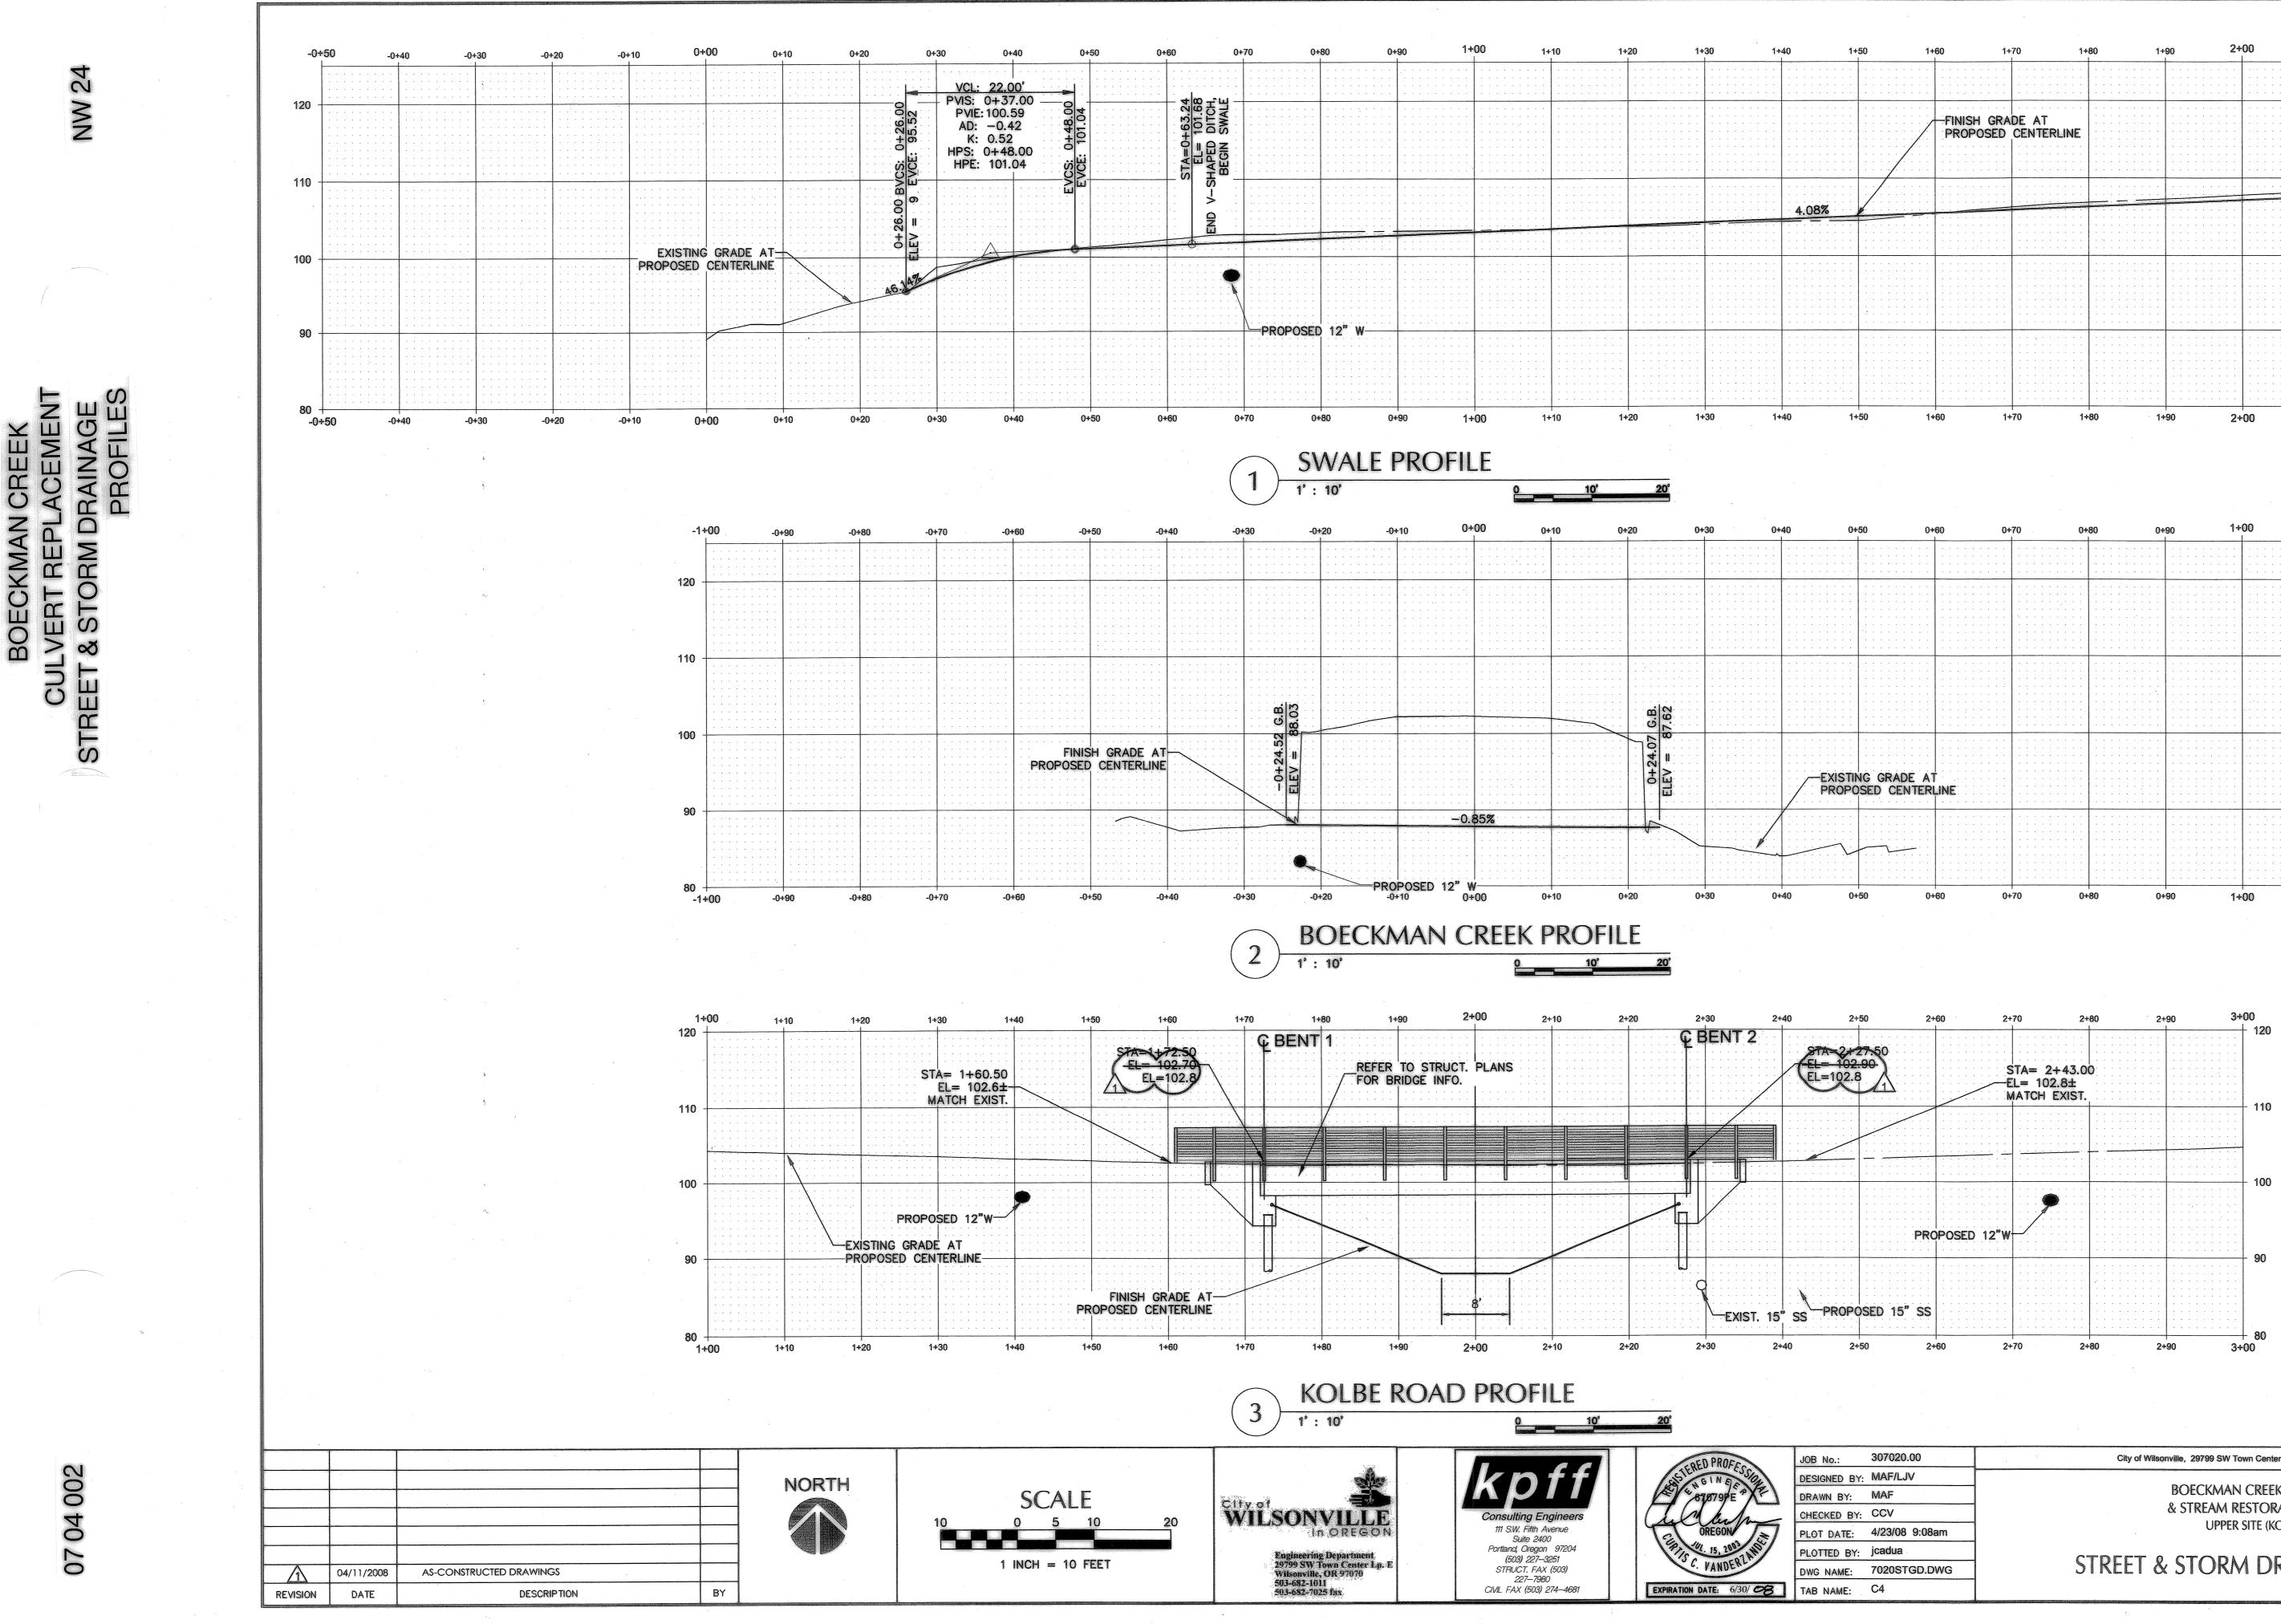








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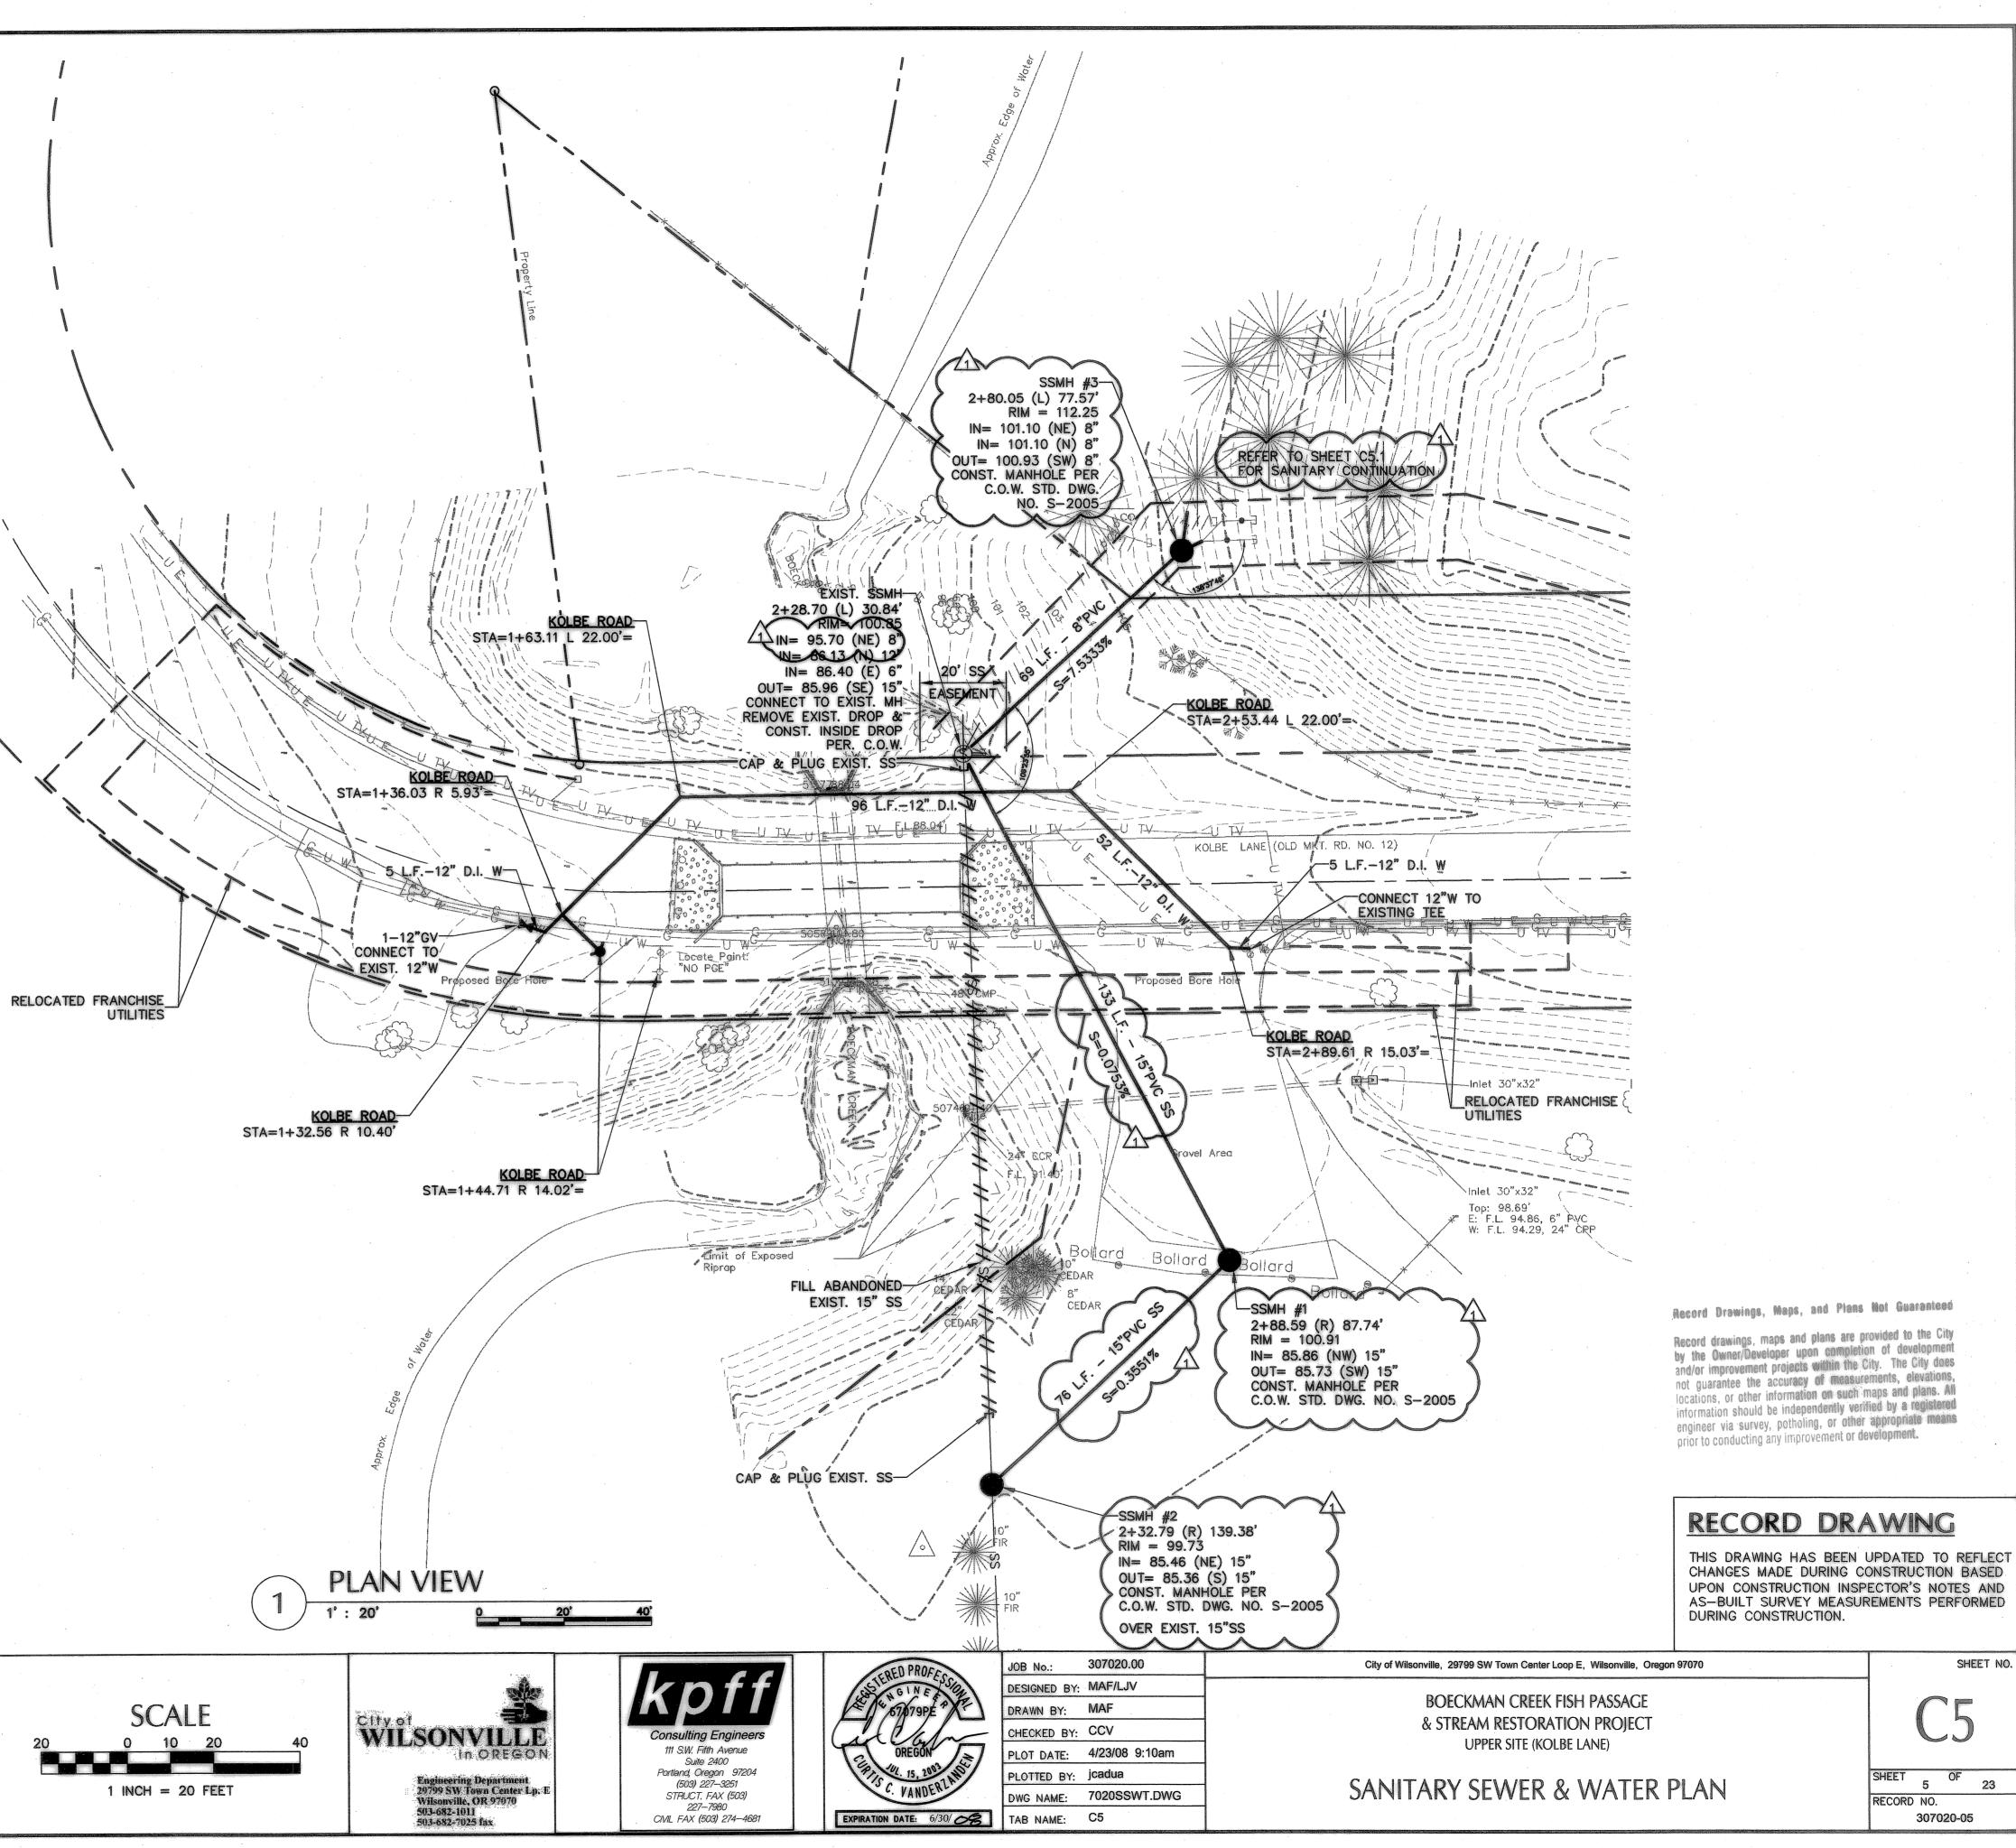
Record Drawings, Maps, and Plans Not Guaranteed

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RECORD DRAWING

City of Wilsonville, 29799 SW Town Center Loop E, Wilsonville, Oregon 97	7070 SHEET NO.
BOECKMAN CREEK FISH PASSAGE & STREAM RESTORATION PROJECT UPPER SITE (KOLBE LANE)	C4
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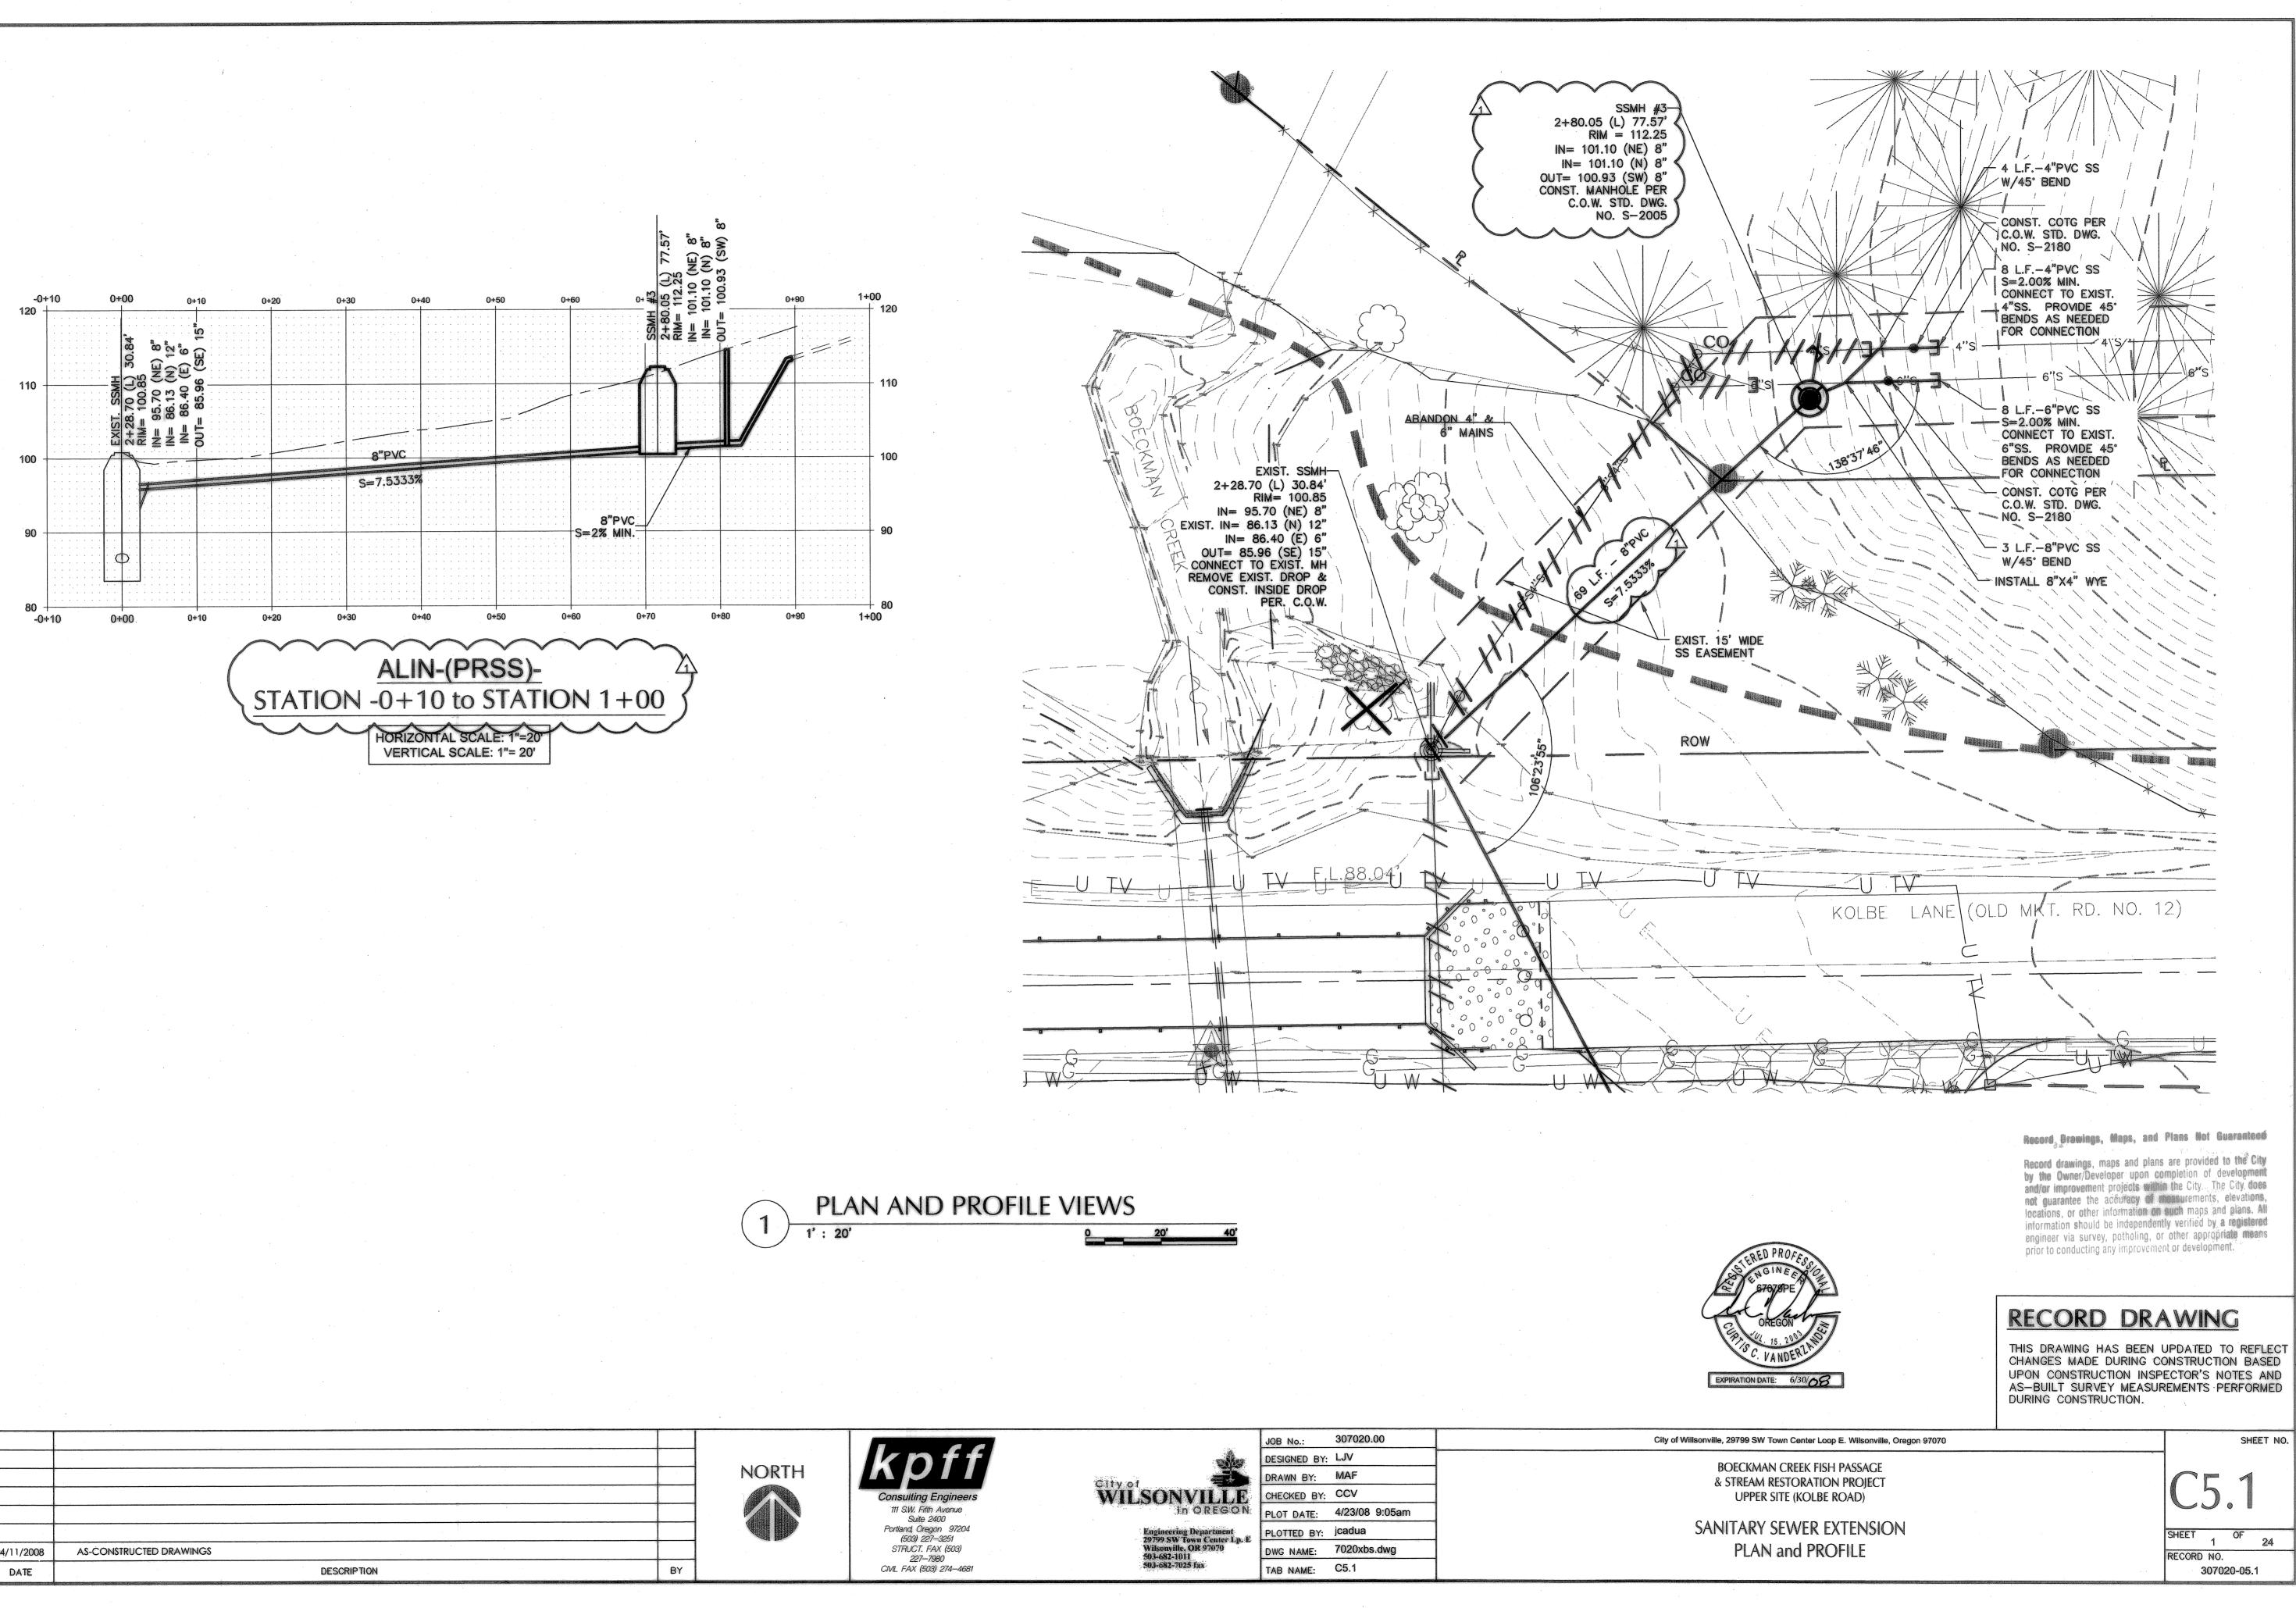
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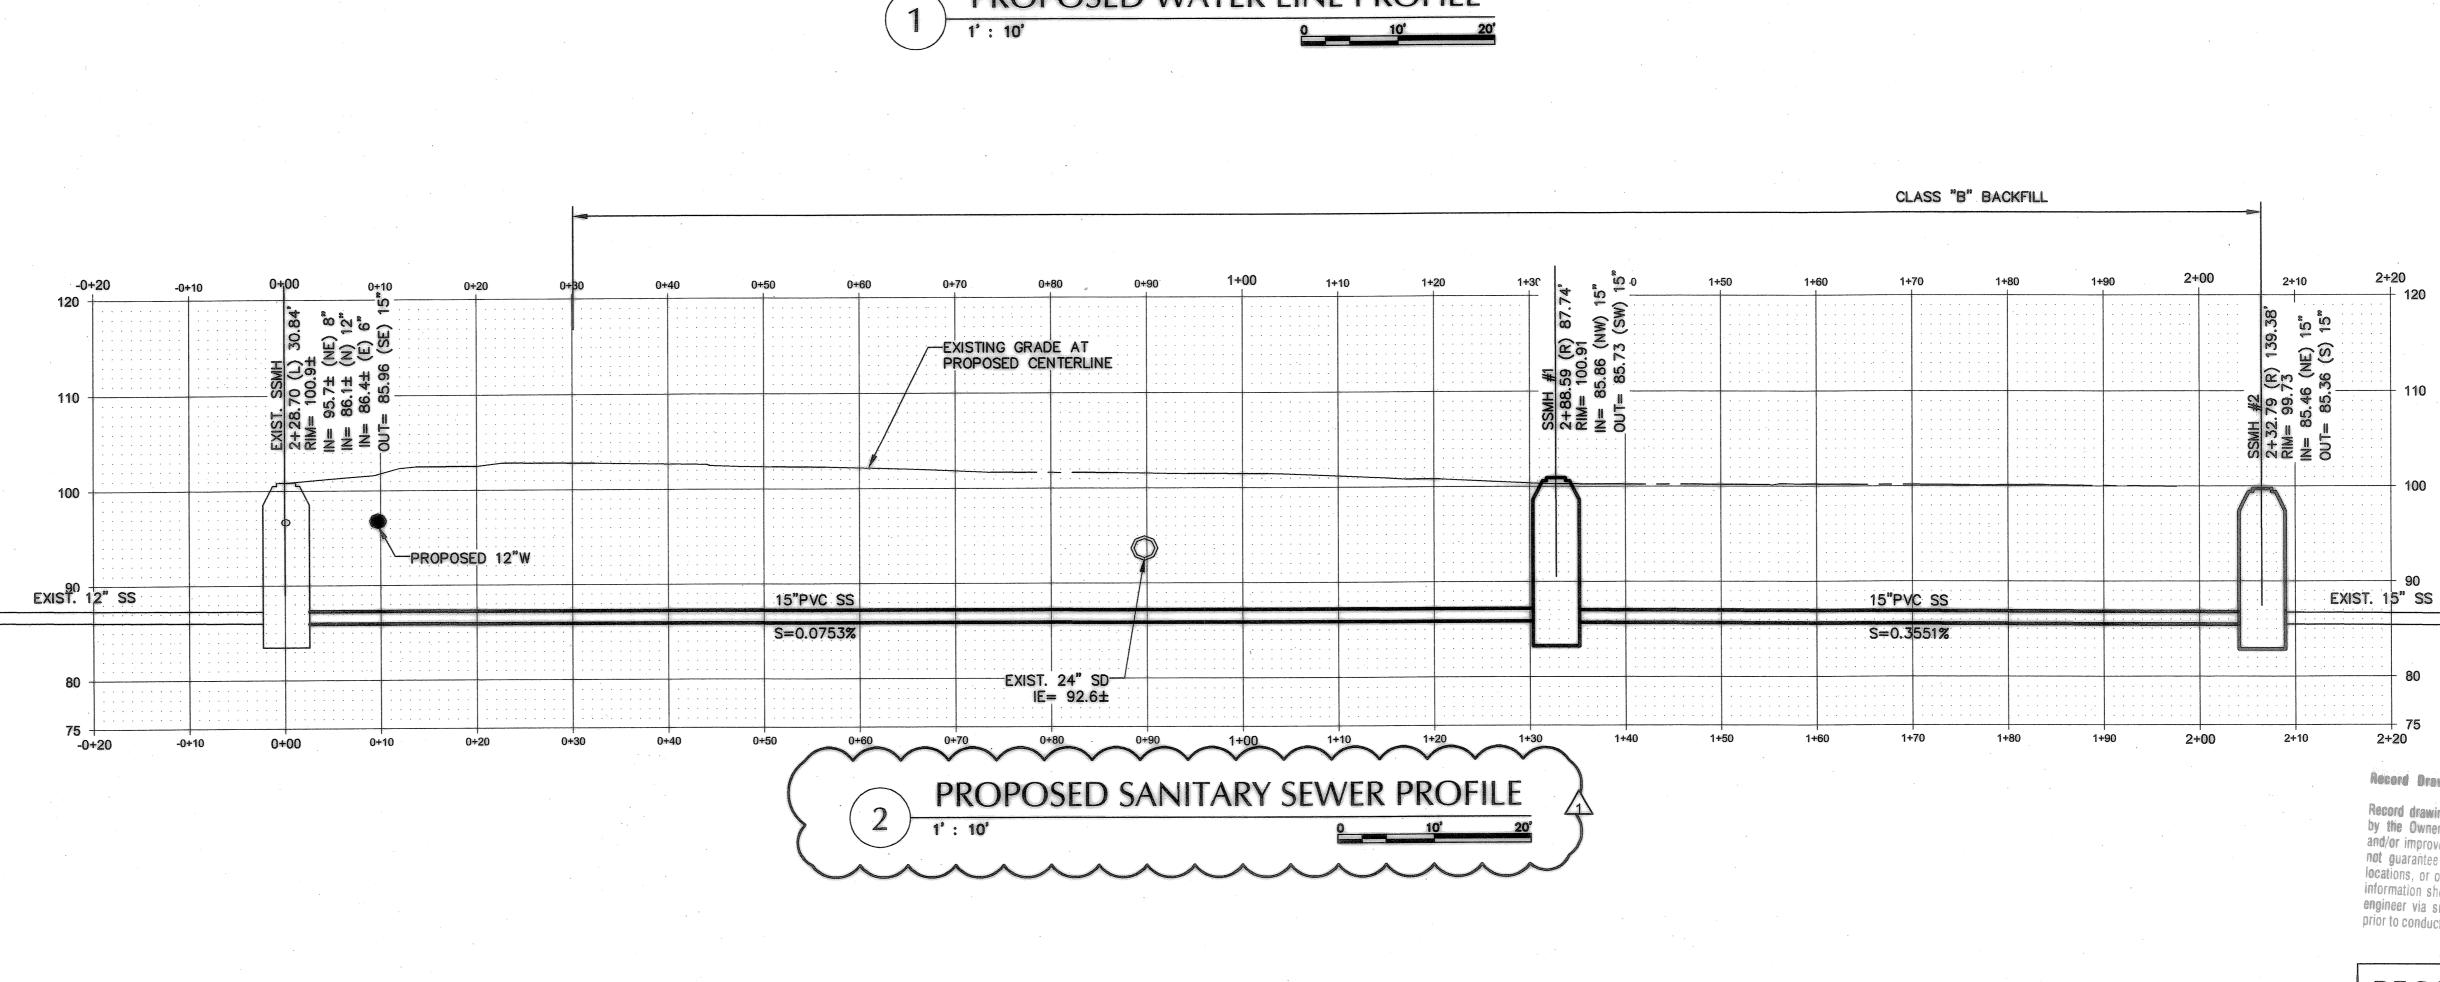
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Consulting Engineers

111 S.W. Fifth Avenue

Suite 2400 Portland, Oregon 97204

(503) 227-3251

STRUCT, FAX (503)

227-7980

CIVIL FAX (503) 274–4681

NORTH AS-CONSTRUCTED DRAWINGS 04/11/2008 BY DATE DESCRIPTION REVISION

SCALE

1 INCH = 10 FEET

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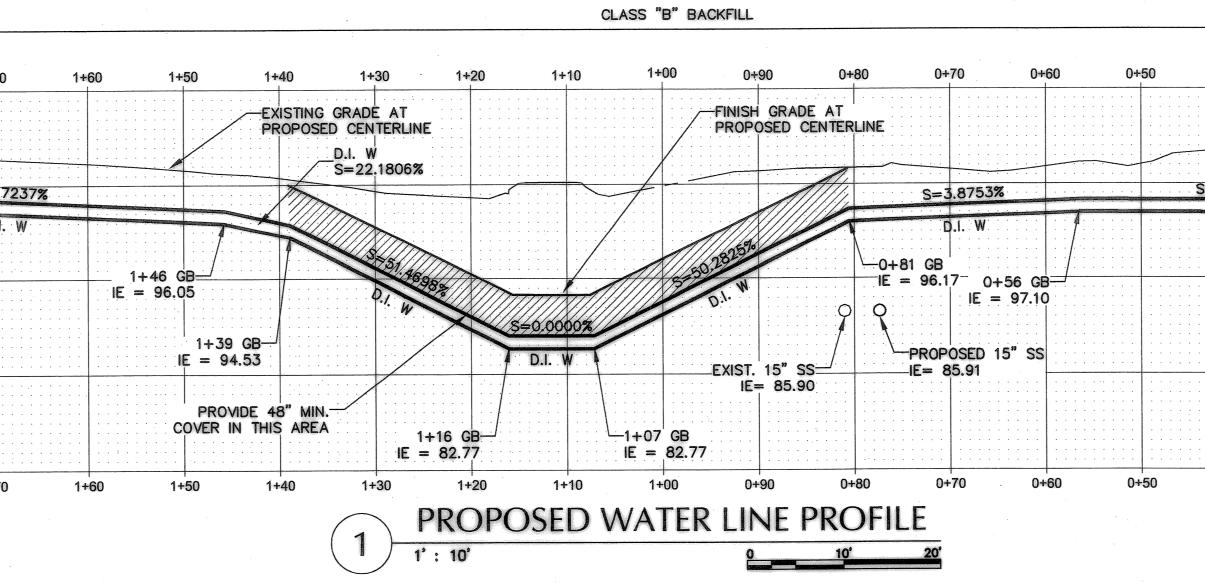
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Engineering Department 29799 SW Town Center Lp. E Wilsouville, OR 97070 503-682-1011 503-682-7025 fax

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City of Wilsonville, 29799 SW Town Center Loop E, Wilsonville, Oregon 97070

BOECKMAN CREEK FISH PASSAGE & STREAM RESTORATION PROJECT UPPER SITE (KOLBE LANE)

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SANITARY SEWER & WATER PROFILES

DWG NAME: 7020SSWT.DWG

307020.00

DESIGNED BY: MAF/LJV

PLOT DATE: 4/23/08 3:30pm

DRAWN BY: MAF

CHECKED BY: CCV

PLOTTED BY: jcadua

TAB NAME: C6


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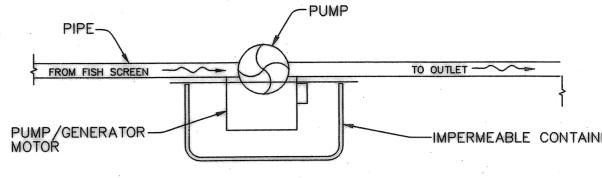
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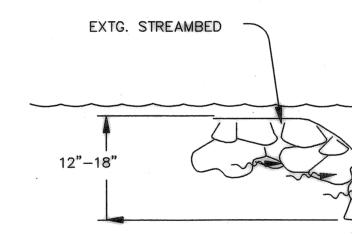
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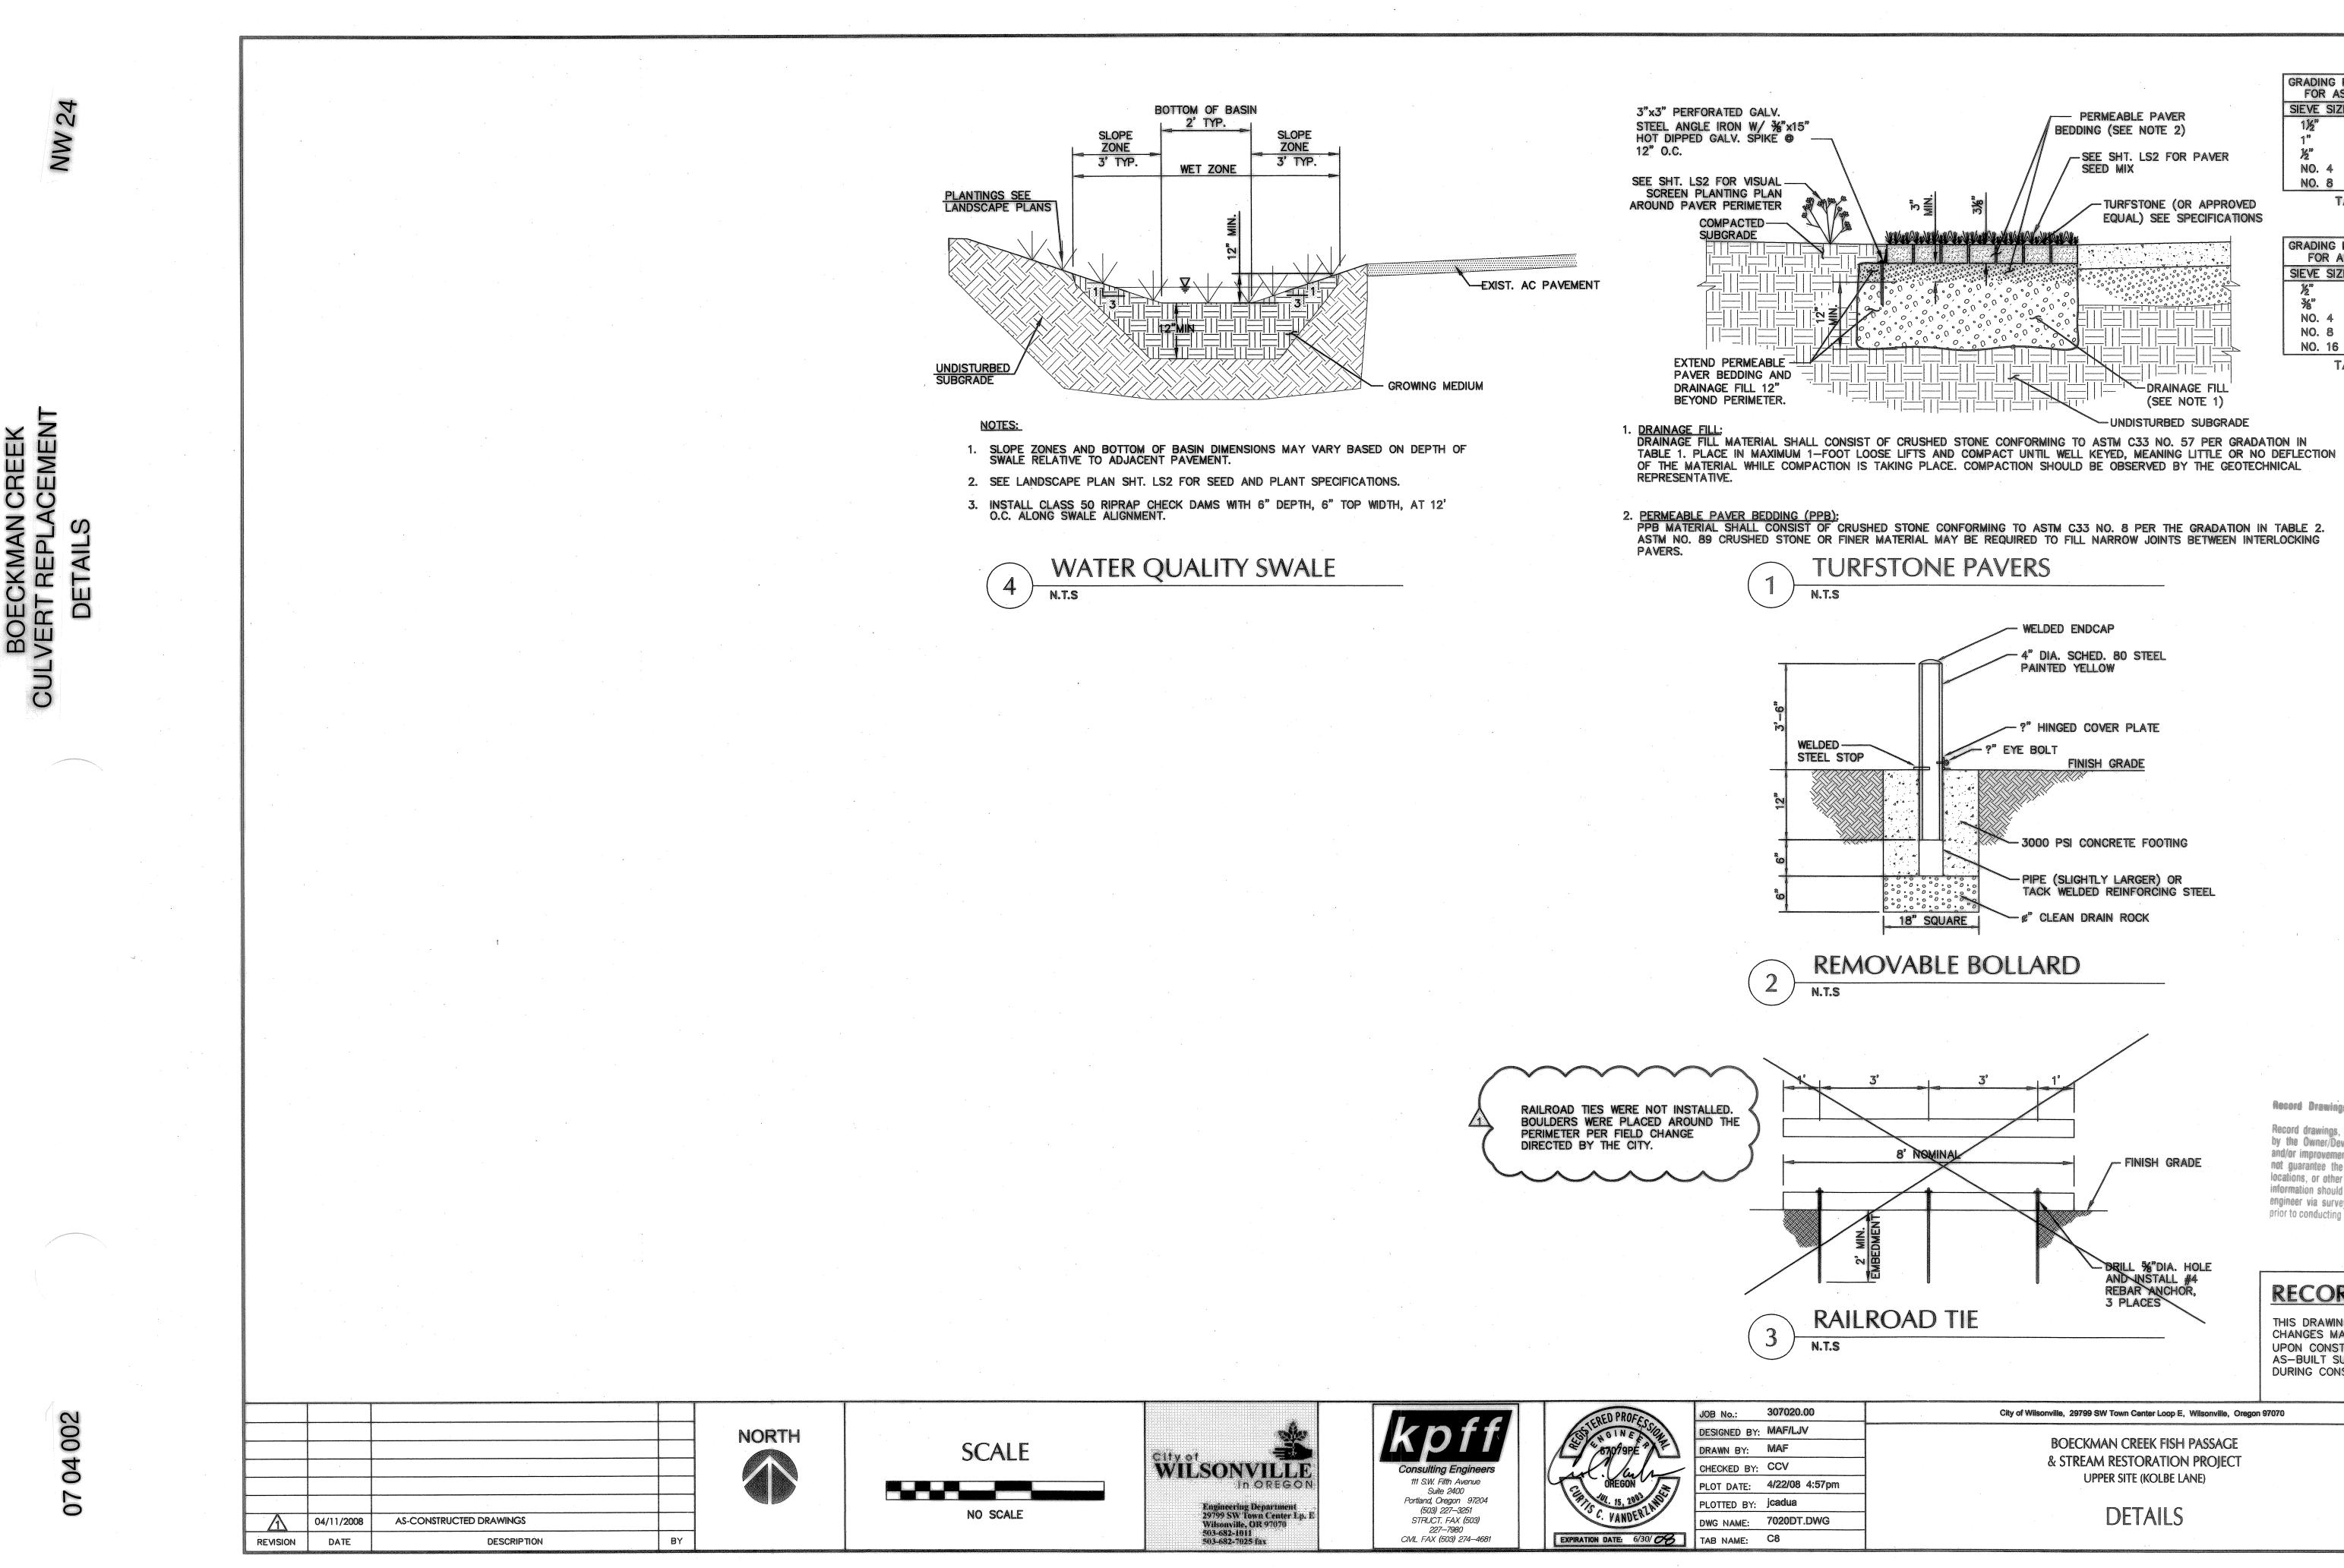
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150	0.334	1.67
200	0.446	2.23
250	0.557	2.79
300	0.668	3.34
400	0.891	4.46
500	1.114	5.57
600	1.337	6.68
700	1.560	7.79
800	1.782	8.91
900	2.005	10.02
1000	2.228	11.14
1200	2.674	13.37
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BE CONSIDERED WHEN HEAVY DEBRIS IS EXPECTED.		
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City of Wilsonville, 29799 SW Town Center Loop E, Wilsonville, Oregon	97070	SHEET NO.
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RECORD NO.

307020-07



2. <u>PERMEABLE PAVER BEDDING (PPB)</u>: PPB MATERIAL SHALL CONSIST OF CRUSHED STONE CONFORMING TO ASTM C33 NO. 8 PER THE GRADATION IN TABLE 2. ASTM NO. 89 CRUSHED STONE OR FINER MATERIAL MAY BE REQUIRED TO FILL NARROW JOINTS BETWEEN INTERLOCKING


	GRADING RE FOR ASTI	QUIREMENTS M NO. 57
PERMEABLE PAVER BEDDING (SEE NOTE 2) -SEE SHT. LS2 FOR PAVER SEED MIX	SIEVE SIZE 1½" 1" ½" NO. 4 NO. 8	% PASSING 100 95 TO. 100 25 TO 60 0 TO 10 0 TO 5
TURFSTONE (OR APPROVED EQUAL) SEE SPECIFICATIONS	TAE	BLE 1
		QUIREMENTS M NO. 8
	SIEVE SIZE	% PASSING
	12"°	100
	36"	85 TO 100
	NO. 4	10 TO 30
	NO. 8 NO. 16	0 TO 10 0 TO 5
		DLE 2
DRAINAGE FILL (SEE NOTE 1)		

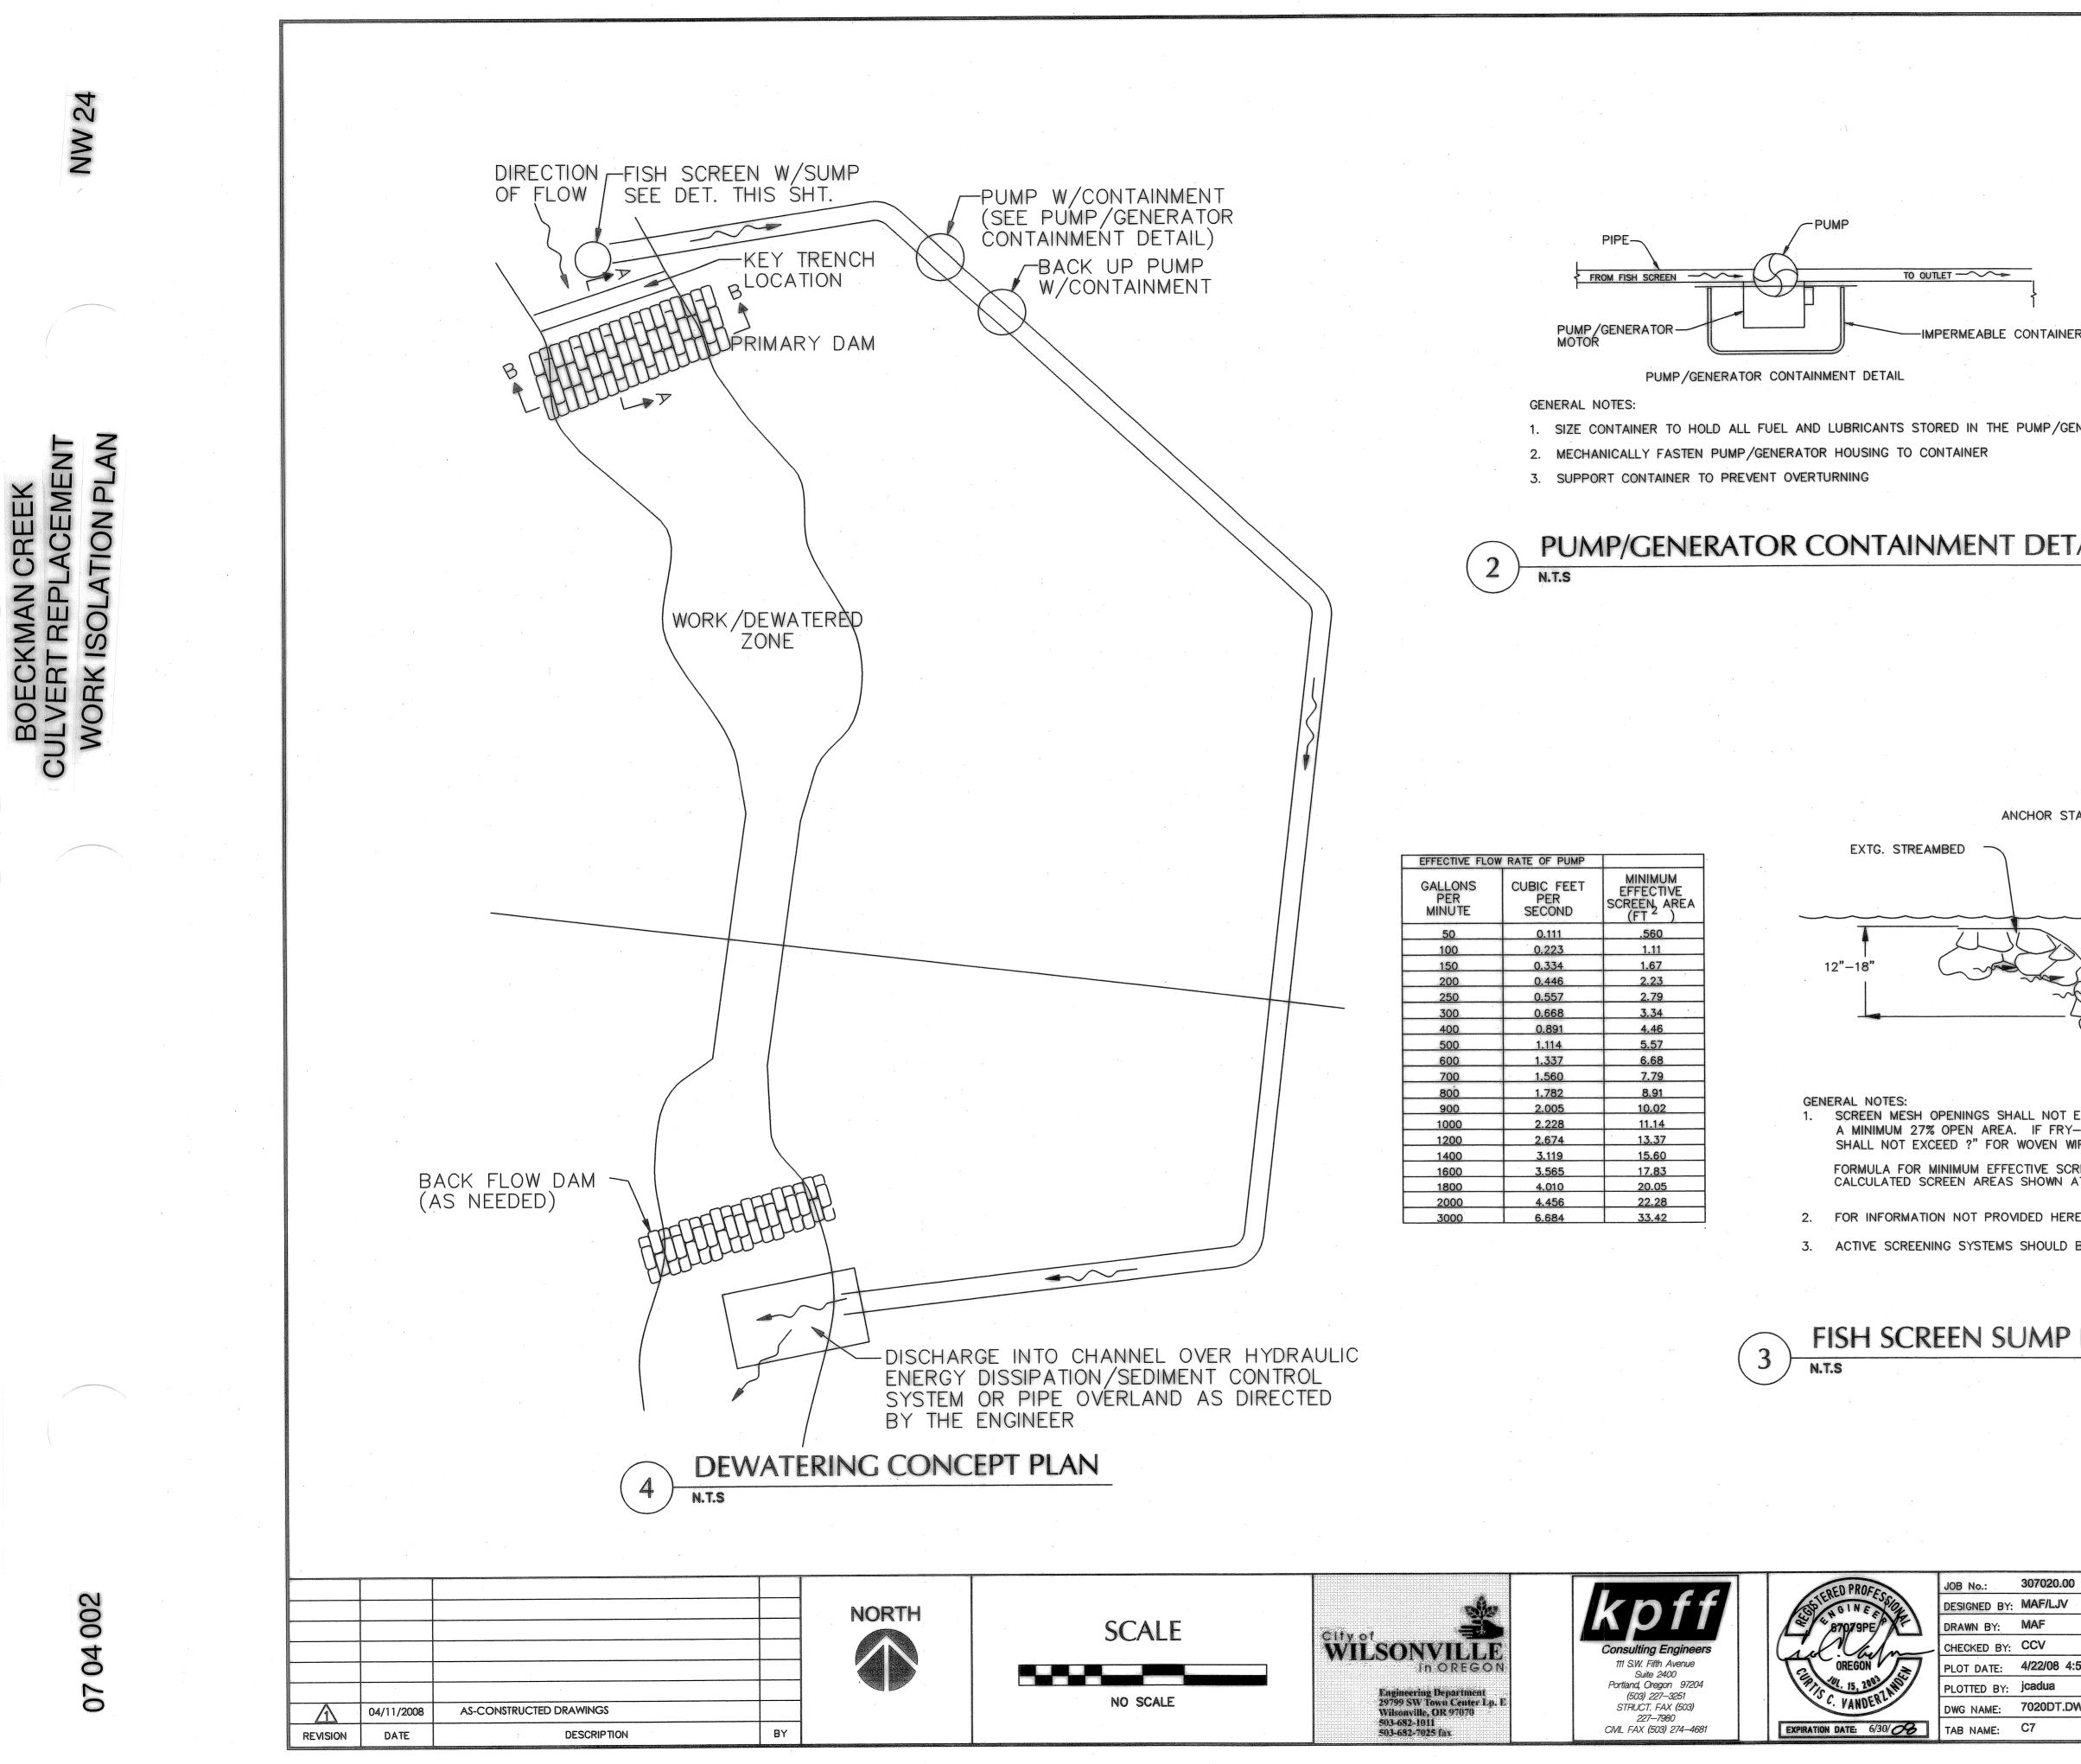Record Drawings, Maps, and Plans Not Guaranteed

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RECORD DRAWING

	City of Wilsonville, 29799 SW Town Center Loop E, Wilsonville, Oregon 97070	SHEET NO.
57pm	BOECKMAN CREEK FISH PASSAGE & STREAM RESTORATION PROJECT UPPER SITE (KOLBE LANE)	C8
VG	DETAILS	SHEET 7 OF 23 RECORD NO. 307020-07

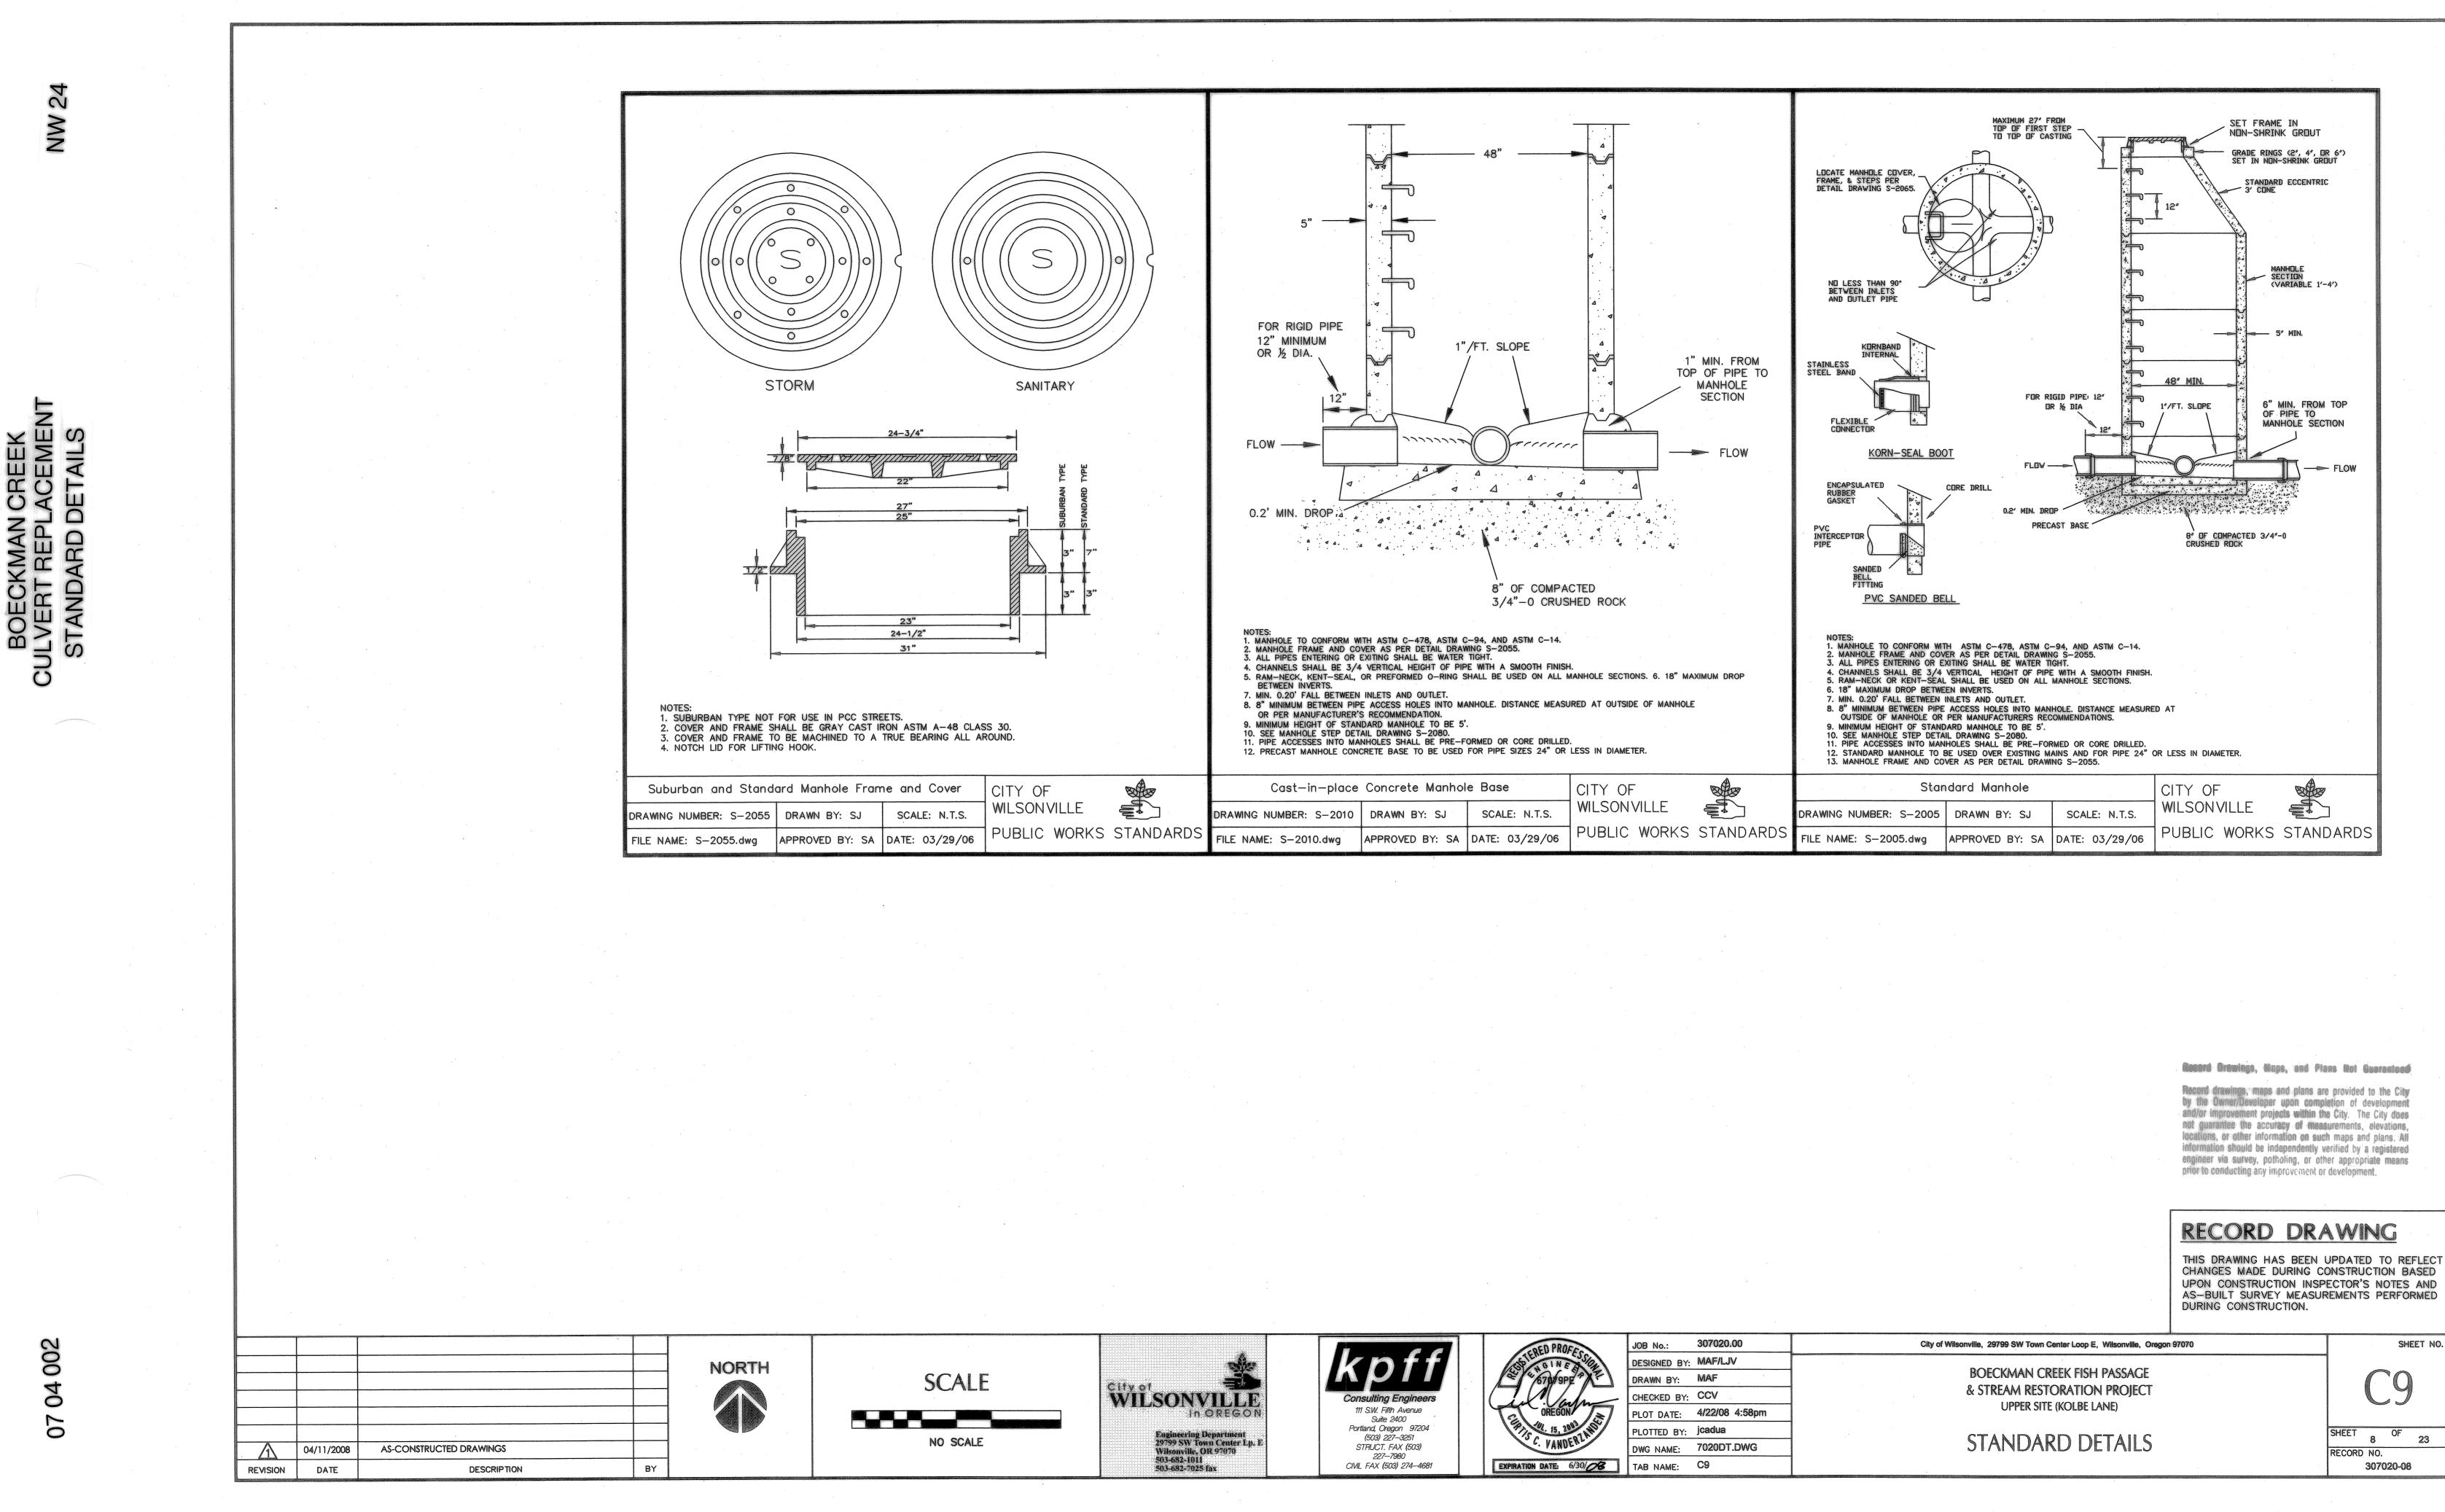


Record Drowings, Maps, and Plans Not Guaranteed

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CHANGES MADE DURING CONSTRUCTION BASED UPON CONSTRUCTION INSPECTOR'S NOTES AND AS-BUILT SURVEY MEASUREMENTS PERFORMED

	City of Wilsonville, 29799 SW Town Center Loop E, Wilsonville, Oregon 97070	SHEET NO.
58pm	BOECKMAN CREEK FISH PASSAGE & STREAM RESTORATION PROJECT UPPER SITE (KOLBE LANE)	C 9
WG	STANDARD DETAILS	SHEET OF 23 RECORD NO. 307020-08

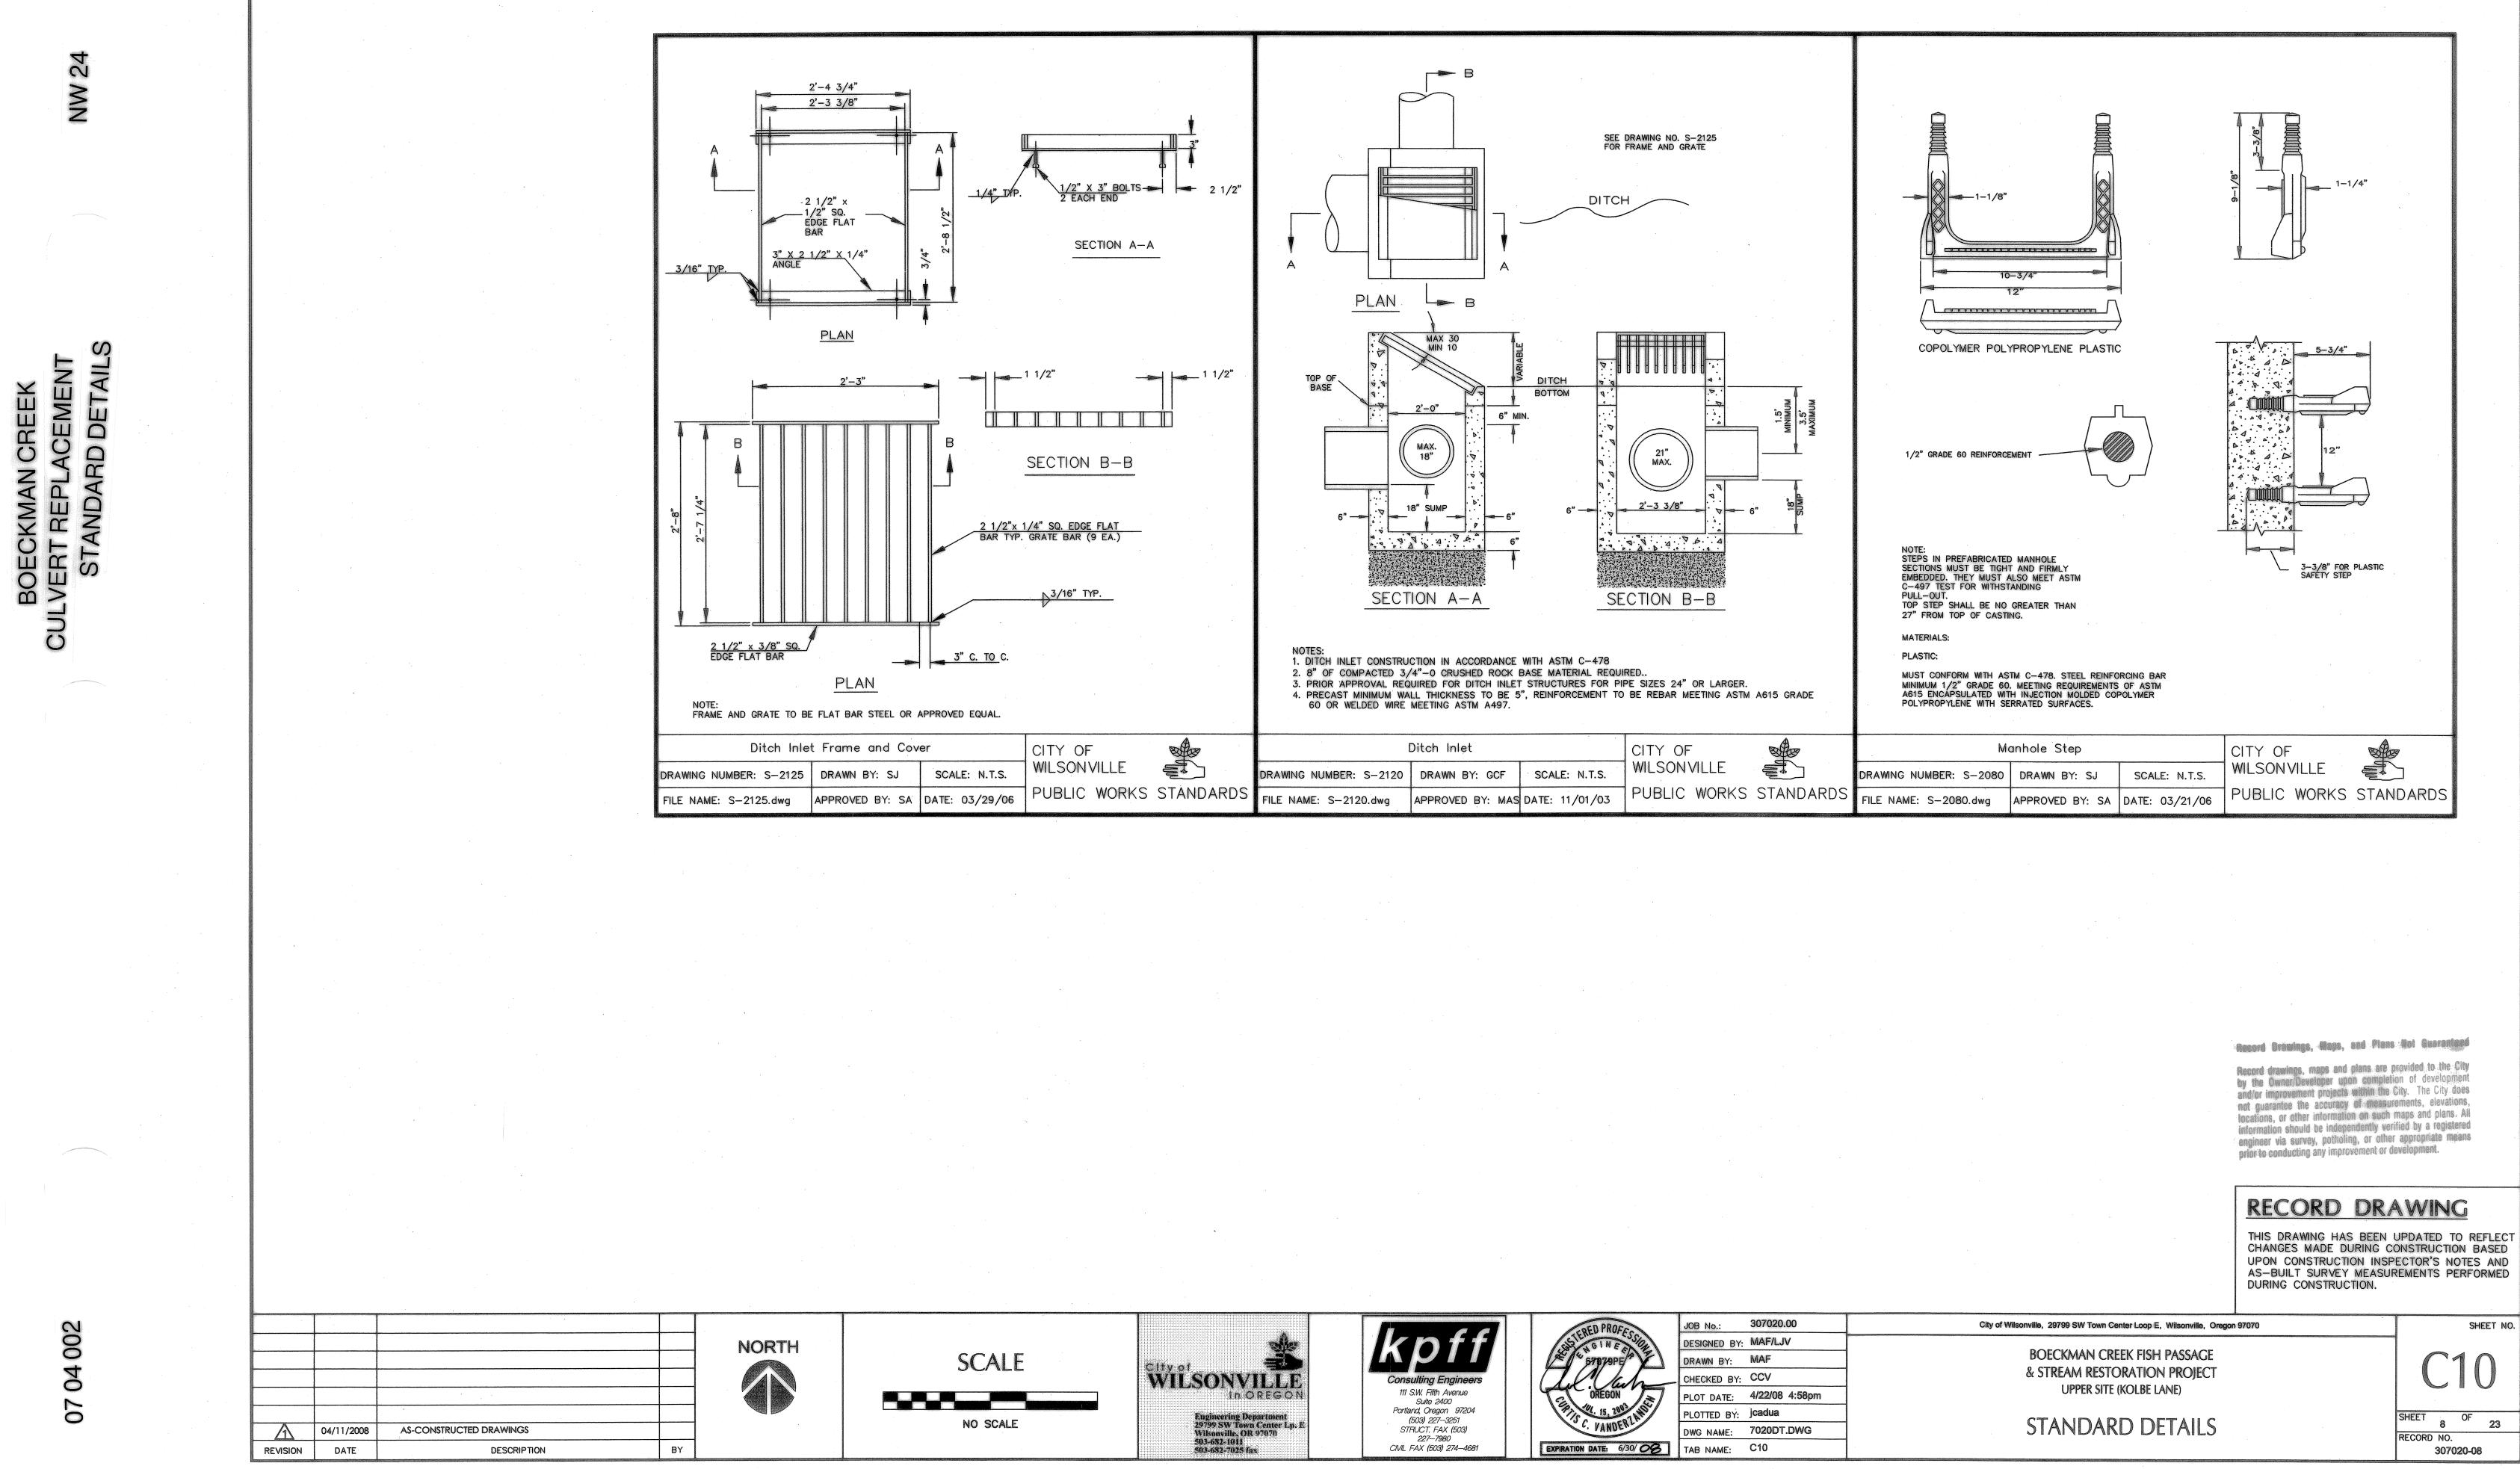

UPON CONSTRUCTION INSPECTOR'S NOTES AND AS-BUILT SURVEY MEASUREMENTS PERFORMED

 City of Wilsonville, 29799 SW Town Center Loop E, Wilsonville, Oregon 97070	SHEET NO.
 BOECKMAN CREEK FISH PASSAGE & STREAM RESTORATION PROJECT UPPER SITE (KOLBE LANE)	C10
 SIANDARD DETAILS	SHEET 8 OF 23 RECORD NO. 307020-08

NW 24

BOECKMANC	CULVERT REPLA	STANDARD

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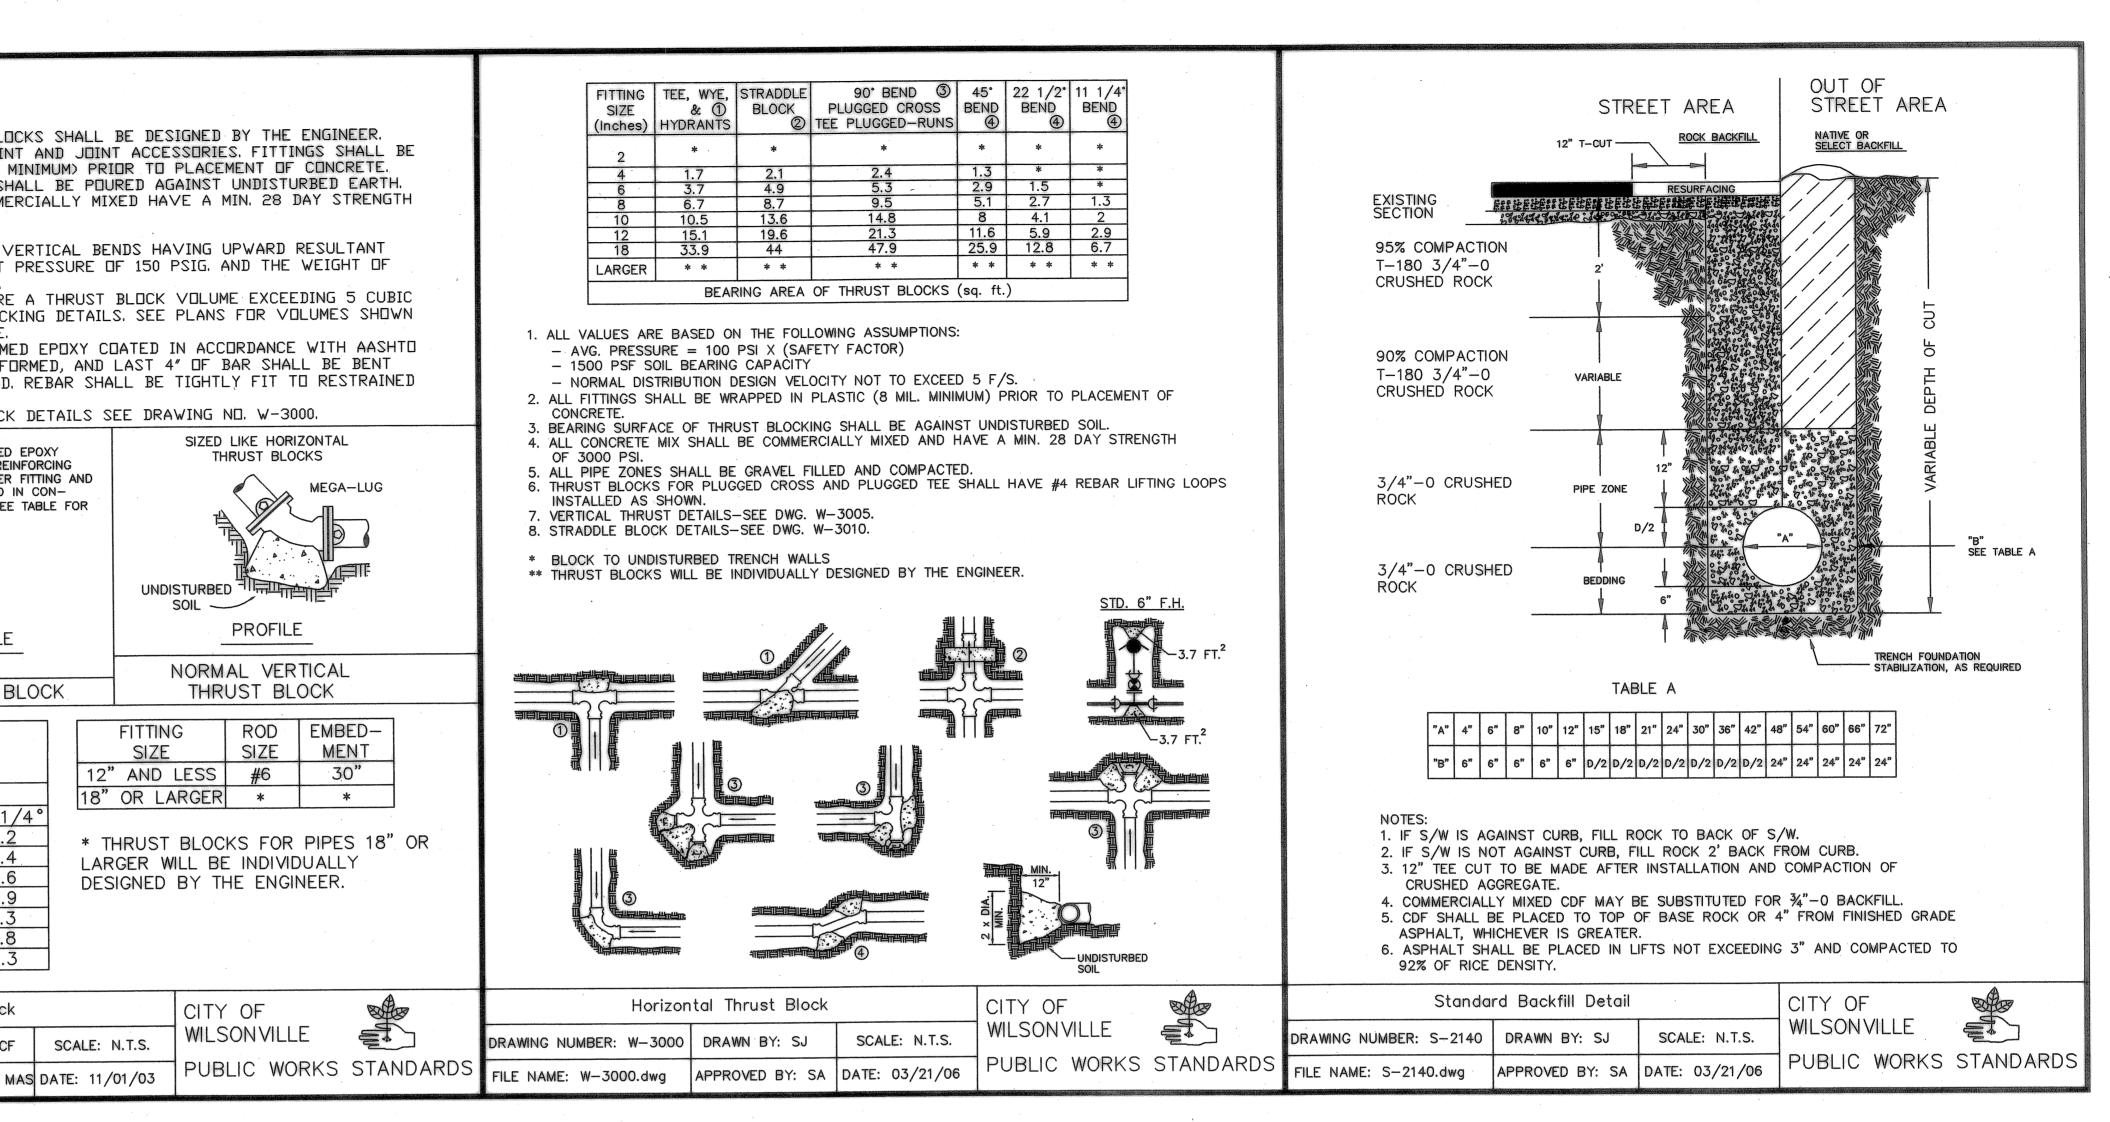
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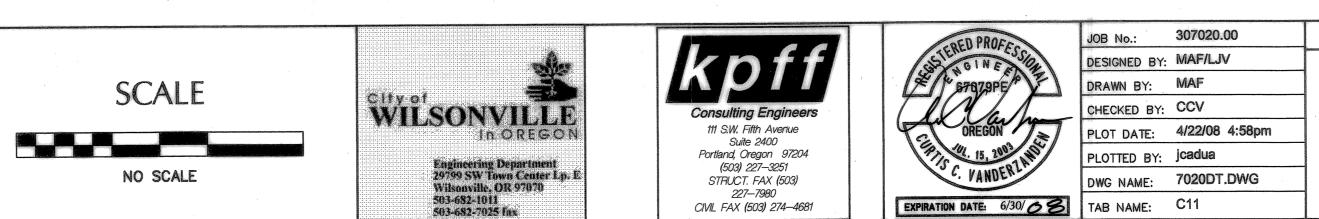
Verti	ical Thrust Block
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RECORD DRAWING

THIS DRAWING HAS BEEN UPDATED TO REFLECT CHANGES MADE DURING CONSTRUCTION BASED UPON CONSTRUCTION INSPECTOR'S NOTES AND AS-BUILT SURVEY MEASUREMENTS PERFORMED DURING CONSTRUCTION.

City of Wilsonville,	29799 SW Town Center Lo	op E, Wilsonville,	Oregon 97070

BOECKMAN CREEK FISH PASSAGE & STREAM RESTORATION PROJECT

UPPER SITE (KOLBE LANE)

C11 SHEET 9 OF 23 RECORD NO. 307020-09

SHEET NO.


STANDARD DETAILS

NW 24

BOECKMAN CREEK CULVERT REPLACEMENT STANDARD DETAILS


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	04/11/2008	AS-CONSTRUCTED DRAWINGS		
REVISION	DATE	DESCRIPTION	BY	

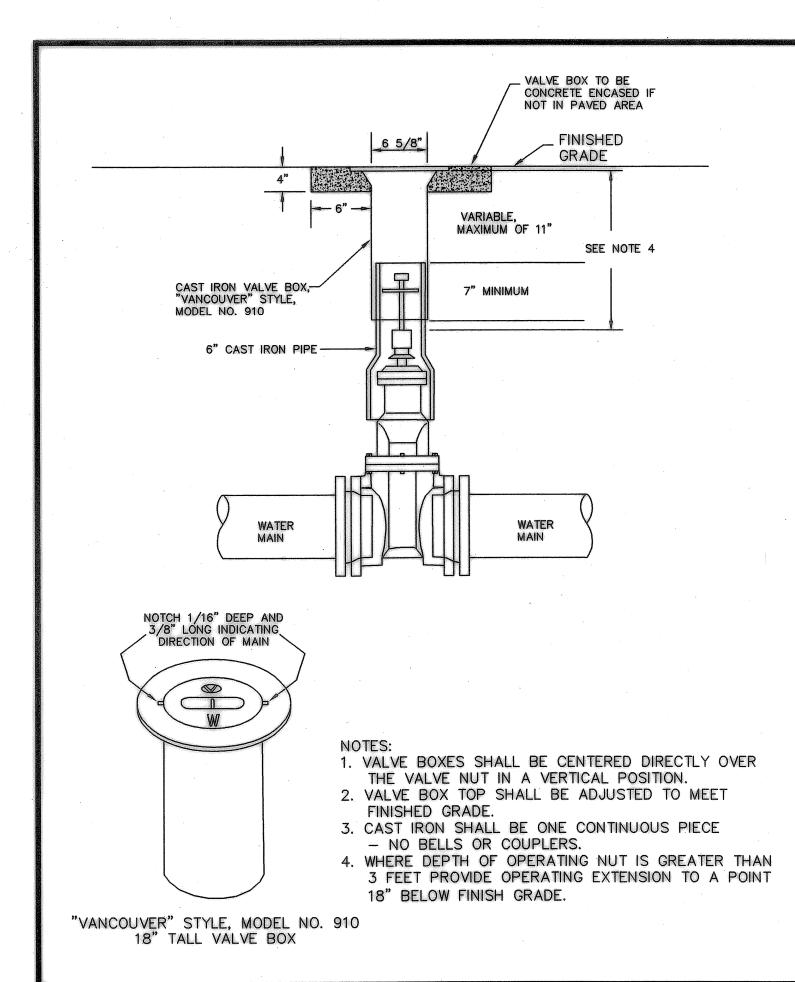

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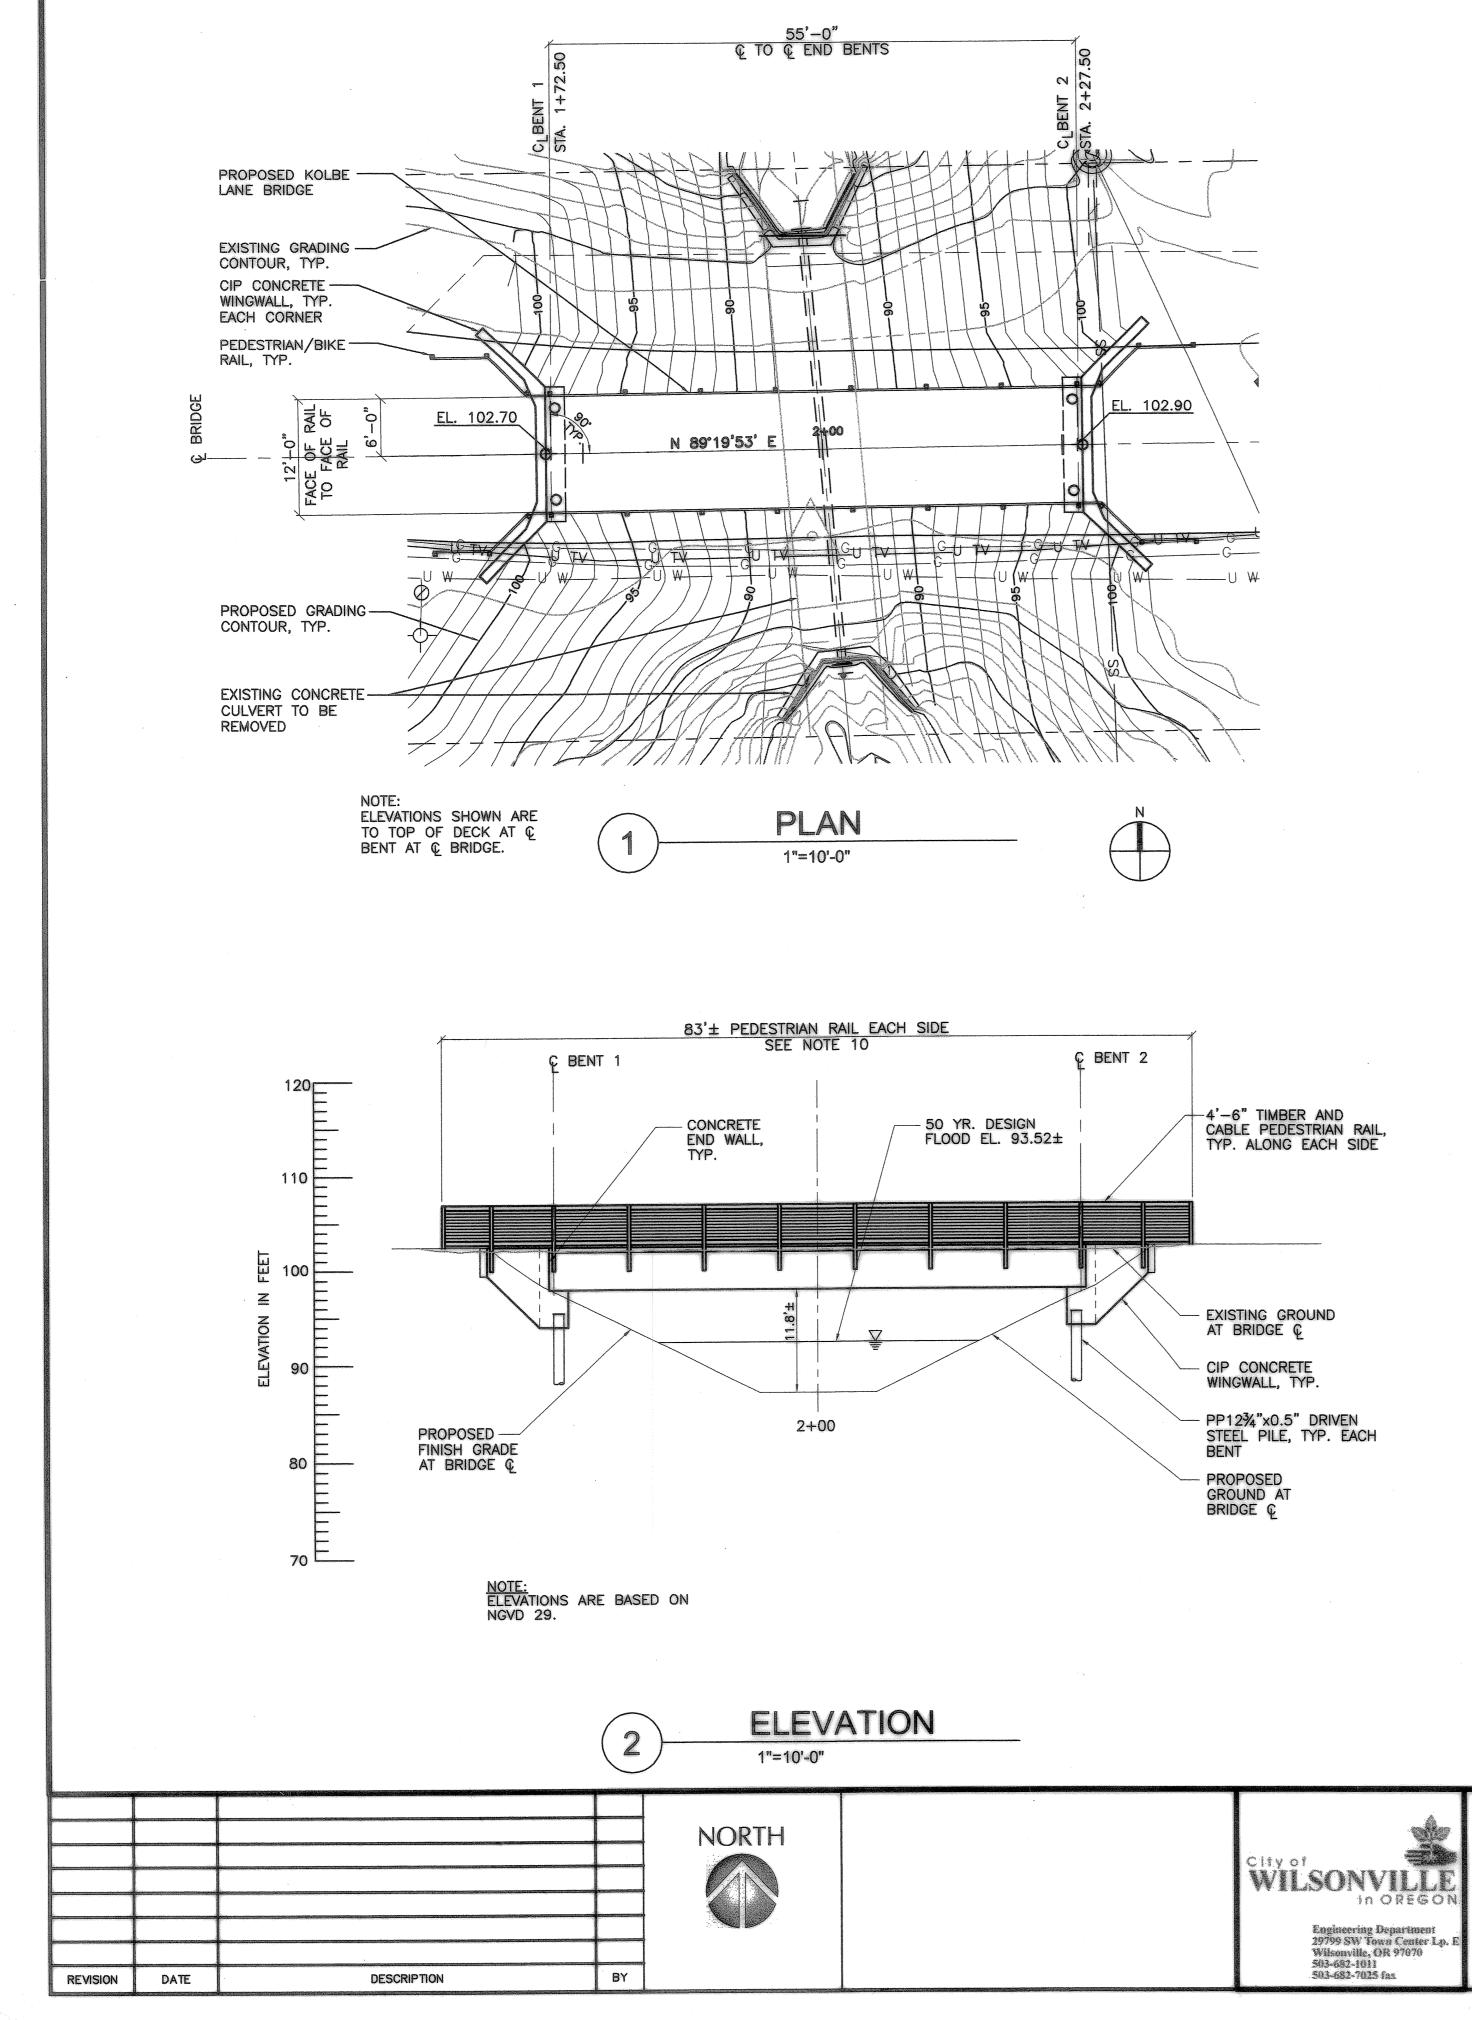
RECORD DRAWING

	City of Wilsonville, 29799 SW Town Center Loop E, Wilsonville, Oregon 97070	SHEET NO.
	BOECKMAN CREEK FISH PASSAGE & STREAM RESTORATION PROJECT UPPER SITE (KOLBE LANE)	C12
8pm /G	STANDARD DETAILS	SHEET 9 OF 23 RECORD NO. 307020-09

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I CREEK ACEMENT & ELEVATION õ E PLAN & AN ULVERT **BOE**
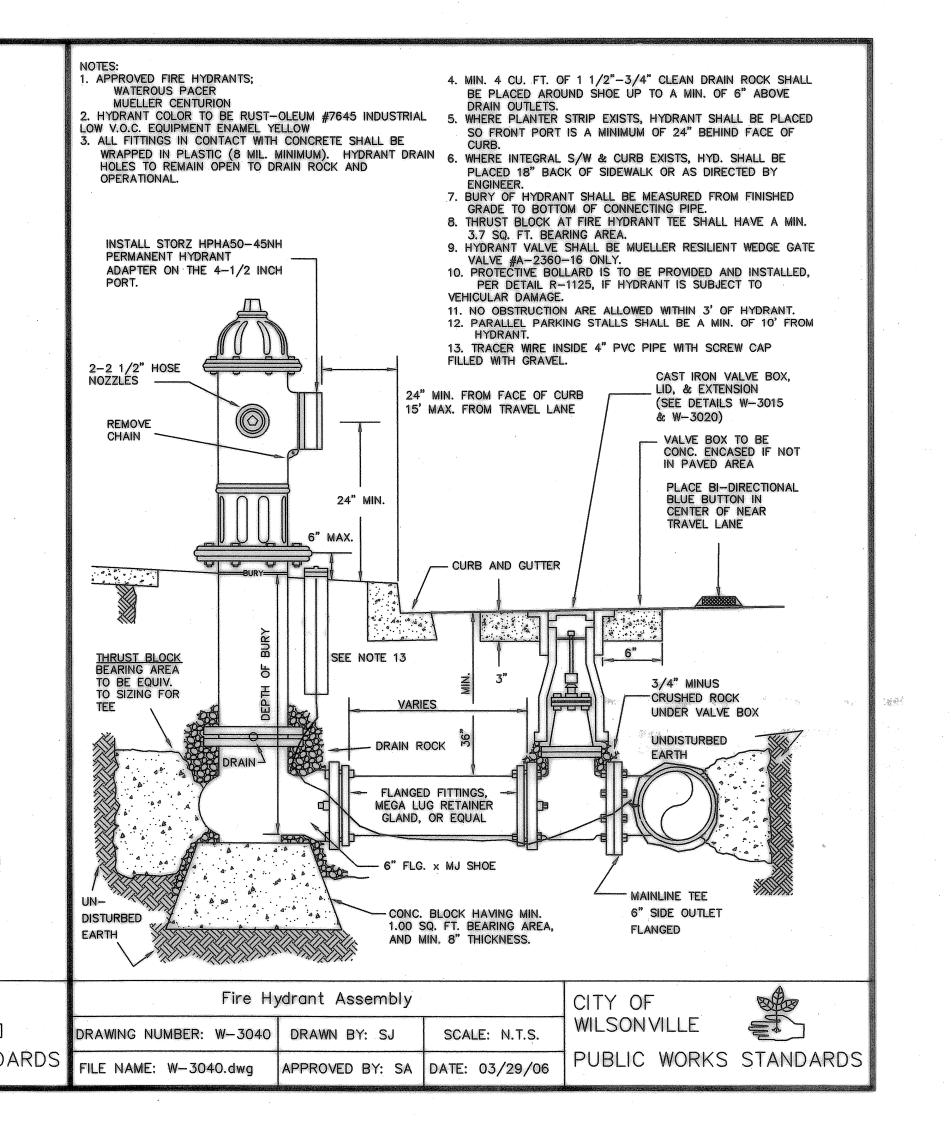
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GENERAL NOTES:

- PROVIDE ALL MATERIALS AND PERFORM ALL WORK ACCORDING TO THE OREGON 1 STANDARD SPECIFICATIONS FOR CONSTRUCTION 2002, THE LATEST SUPPLEMENTAL STANDARD SPECIFICATIONS FOR CONSTRUCTION, OF THE OREGON DEPARTMENT OF TRANSPORTATION AND THE SPECIAL PROVISIONS.
- BRIDGE IS DESIGNED WITH NO ALLOWANCE FOR PRESENT OR FUTURE WEARING SURFACE AND ALL OF THE FOLLOWING LIVE LOADS ACCORDING TO THE 2. CURRENT AASHTO LRFD BRIDGE DESIGN SPECIFICATIONS:

SERVICE AND STRENGTH-1 LIMIT STATE: THE CONTROLLING ARRANGEMENT OF A SINGLE DESIGN TRUCK (HS-20 EQUIVALENT) INCLUDING BRAKING FORCE OR 85 PSF PEDESTRIAN LIVE LOAD IMPACT FACTOR = 0% MULTIPLE PRESENCE FACTOR = 1.0

- 3. BRIDGE RAIL IS DESIGNED IN ACCORDANCE WITH THE CURRENT AASHTO LRFD BRIDGE DESIGN SPECIFICATIONS FOR BICYCLE RAILINGS. RAILS ARE NOT DESIGNED FOR VEHICULAR TRAFFIC.
- BRIDGE IS DESIGNED IN ACCORDANCE WITH AASHTO LRFD BRIDGE DESIGN 4 SPECIFICATIONS, EXCEPT FOR PILING ELEMENTS WHICH ARE DESIGNED BY ALLOWABLE STRESS DESIGN IN ACCORDANCE WITH AASHTO STANDARD SPECIFICATIONS FOR HIGHWAY BRIDGES.
- 5. SEISMIC DESIGN IINCLUDING CONNECTIONS BETWEEN SUPERSTRUCTURE AND SUBSTRUCTURE IS IN ACCORDANCE WITH THE "AASHTO LRFD BRIDGE DESIGN SPECIFICATIONS" AS MODIFIED BY THE "ODOT BRIDGE DESIGN & DRAFTING MANUAL"

SITE COEFFICIENT (S)=1.5 500 YEAR PEAK BEDROCK ACCELERATION COEFFICIENT=0.18G 1000 YEAR PEAK BEDROCK ACCELERATION COEFFICIENT=0.25G

PROVIDE ALL REINFORCING STEEL ACCORDING TO ASTM SPECIFICATION A706, OR 6 AASHTO M31 (ASTM A615) GRADE 60. PROVIDE FIELD BENT STIRRUPS ACCORDING TO ASTM SPECIFICATION A706. USE THE FOLLOWING SPLICE LENGTHS (UNLESS SHOWN OTHERWISE):

			REI	NFORC	ING SPL	ICE LE	NGTHS	(CLASS	B) GR	ADE 60	,
BAR	SIZE	#3	#4	# 5	#6	#7	#8	#9	#10	#11	
UNCO	ATED	1'-0"	1'-4"	1'-8"	2'-0"	2'-8"	3'-6"	4'-4"	5'-7"	6'-9"	١


FOR TOP BARS, MULTIPLY LAP LENGTH ABOVE BY 1.4. TOP BARS ARE HORIZONTAL BARS WITH MORE THAN 12" OF CONCRETE CAST BELOW THE BARS.


- 7. SPLICE REINFORCING STEEL AT ALTERNATE BARS, STAGGERED AT LEAST ONE SPLICE LENGTH OR AS FAR AS POSSIBLE, UNLESS SHOWN OTHERWISE.
- 8. PLACE BARS 2" CLEAR OF THE NEAREST FACE OF CONCRETE (UNLESS SHOWN OTHERWISE).
- 9. PROVIDE CLASS 3600 1/2, 1 OR 3/4 CONCRETE FOR ALL CONCRETE.
- 10. PREFABRICATED TIMBER BRIDGE (SUPERSTRUCTURE, PEDESTRIAN/BIKE RAIL) SHALL BE DESIGNED AND PROVIDED BY AN APPROVED SUPPLIER. REFERENCE SPECIAL PROVISIONS FOR ADDITIONAL REQUIREMENTS. COORDINATE FINAL SUBSTRUCTURE AND SUPERSTRUCTURE DIMENSIONS WITH APPROVED TIMBER BRIDGE SHOP DRAWINGS.
- 11. SEE FOUNDATION PLAN ON DWG. S3 FOR FOUNDATION DESIGN NOTES.



111 SW 5th Avenue Suite 2500 Portland, Oregon 97204 503-227-3251 Proj. No. 207144


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	DESIGNED BY:	JSW / KJ
	DRAWN BY:	JW
	CHECKED BY:	CJT
	PLOT DATE:	4/10/08 2
	PLOTTED BY:	jwilkes
	DWG NAME:	12-207144
	TAB NAME:	Layout1
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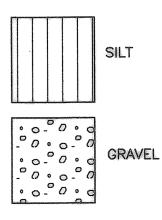


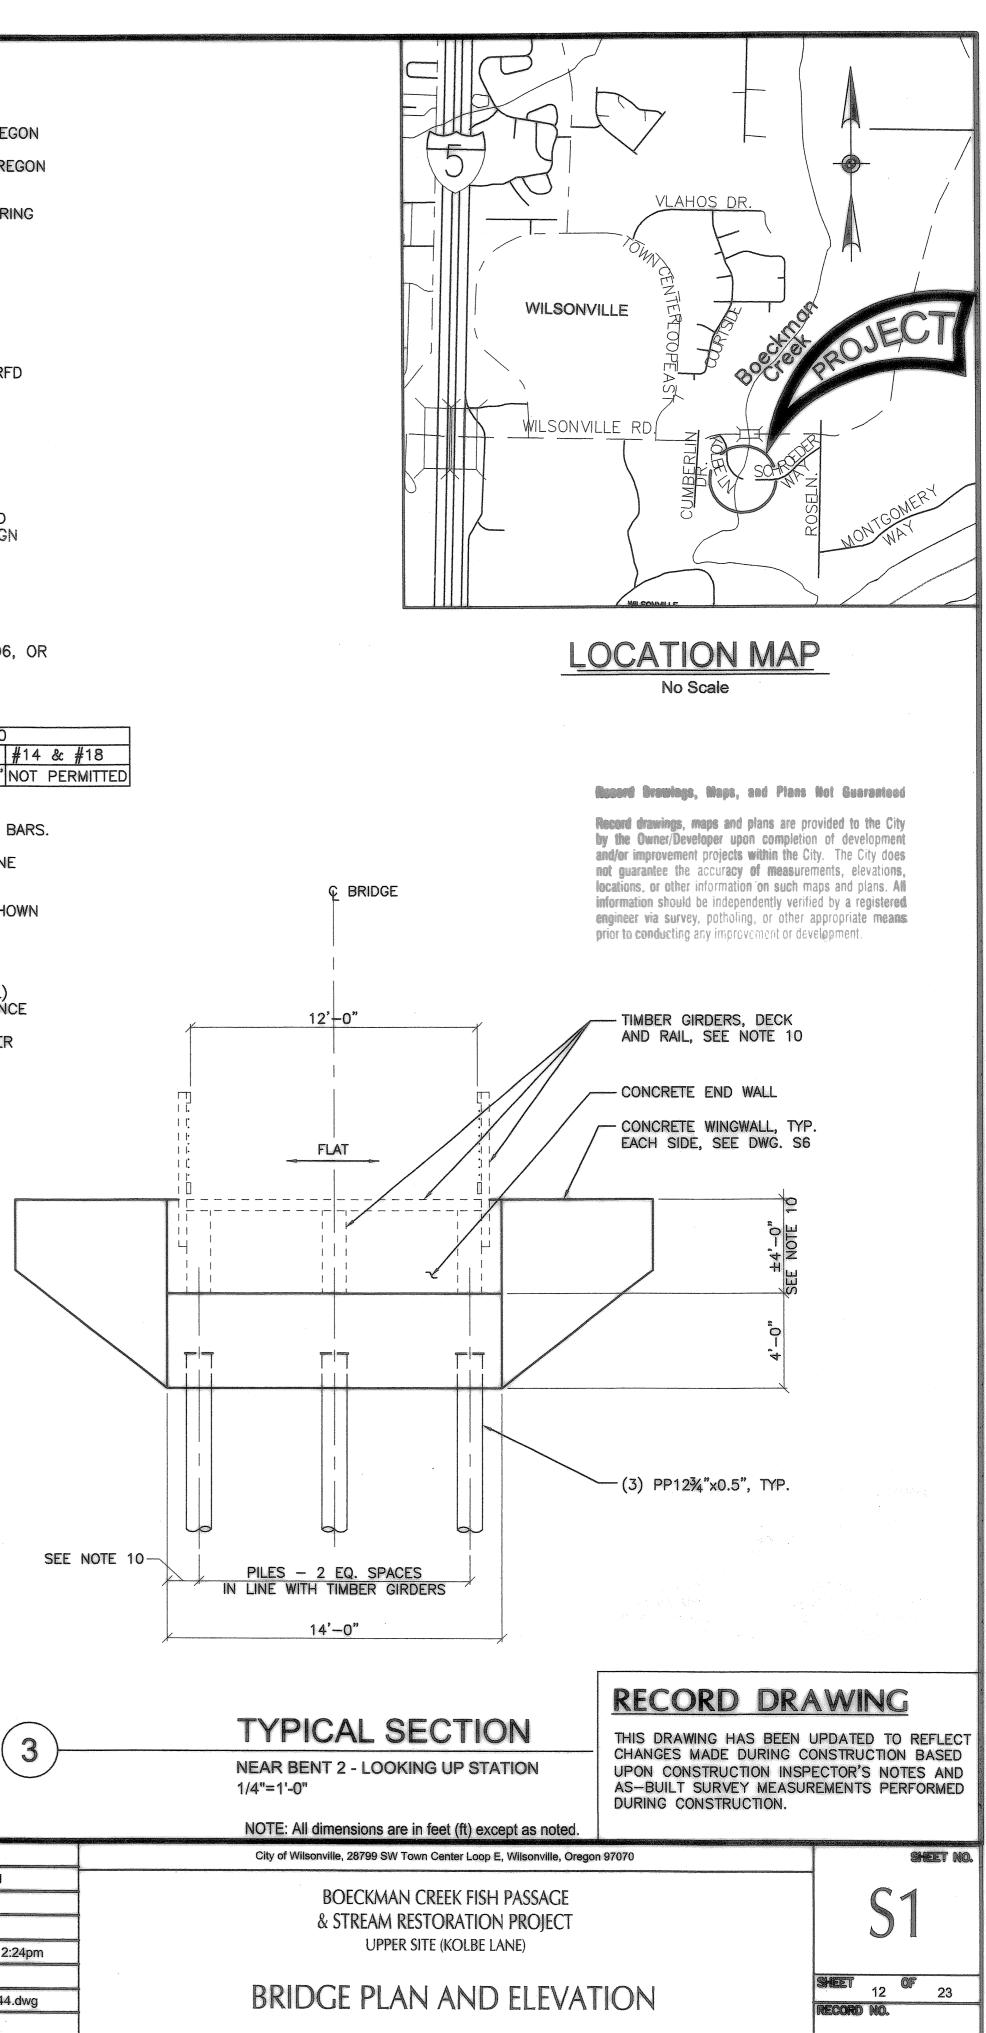
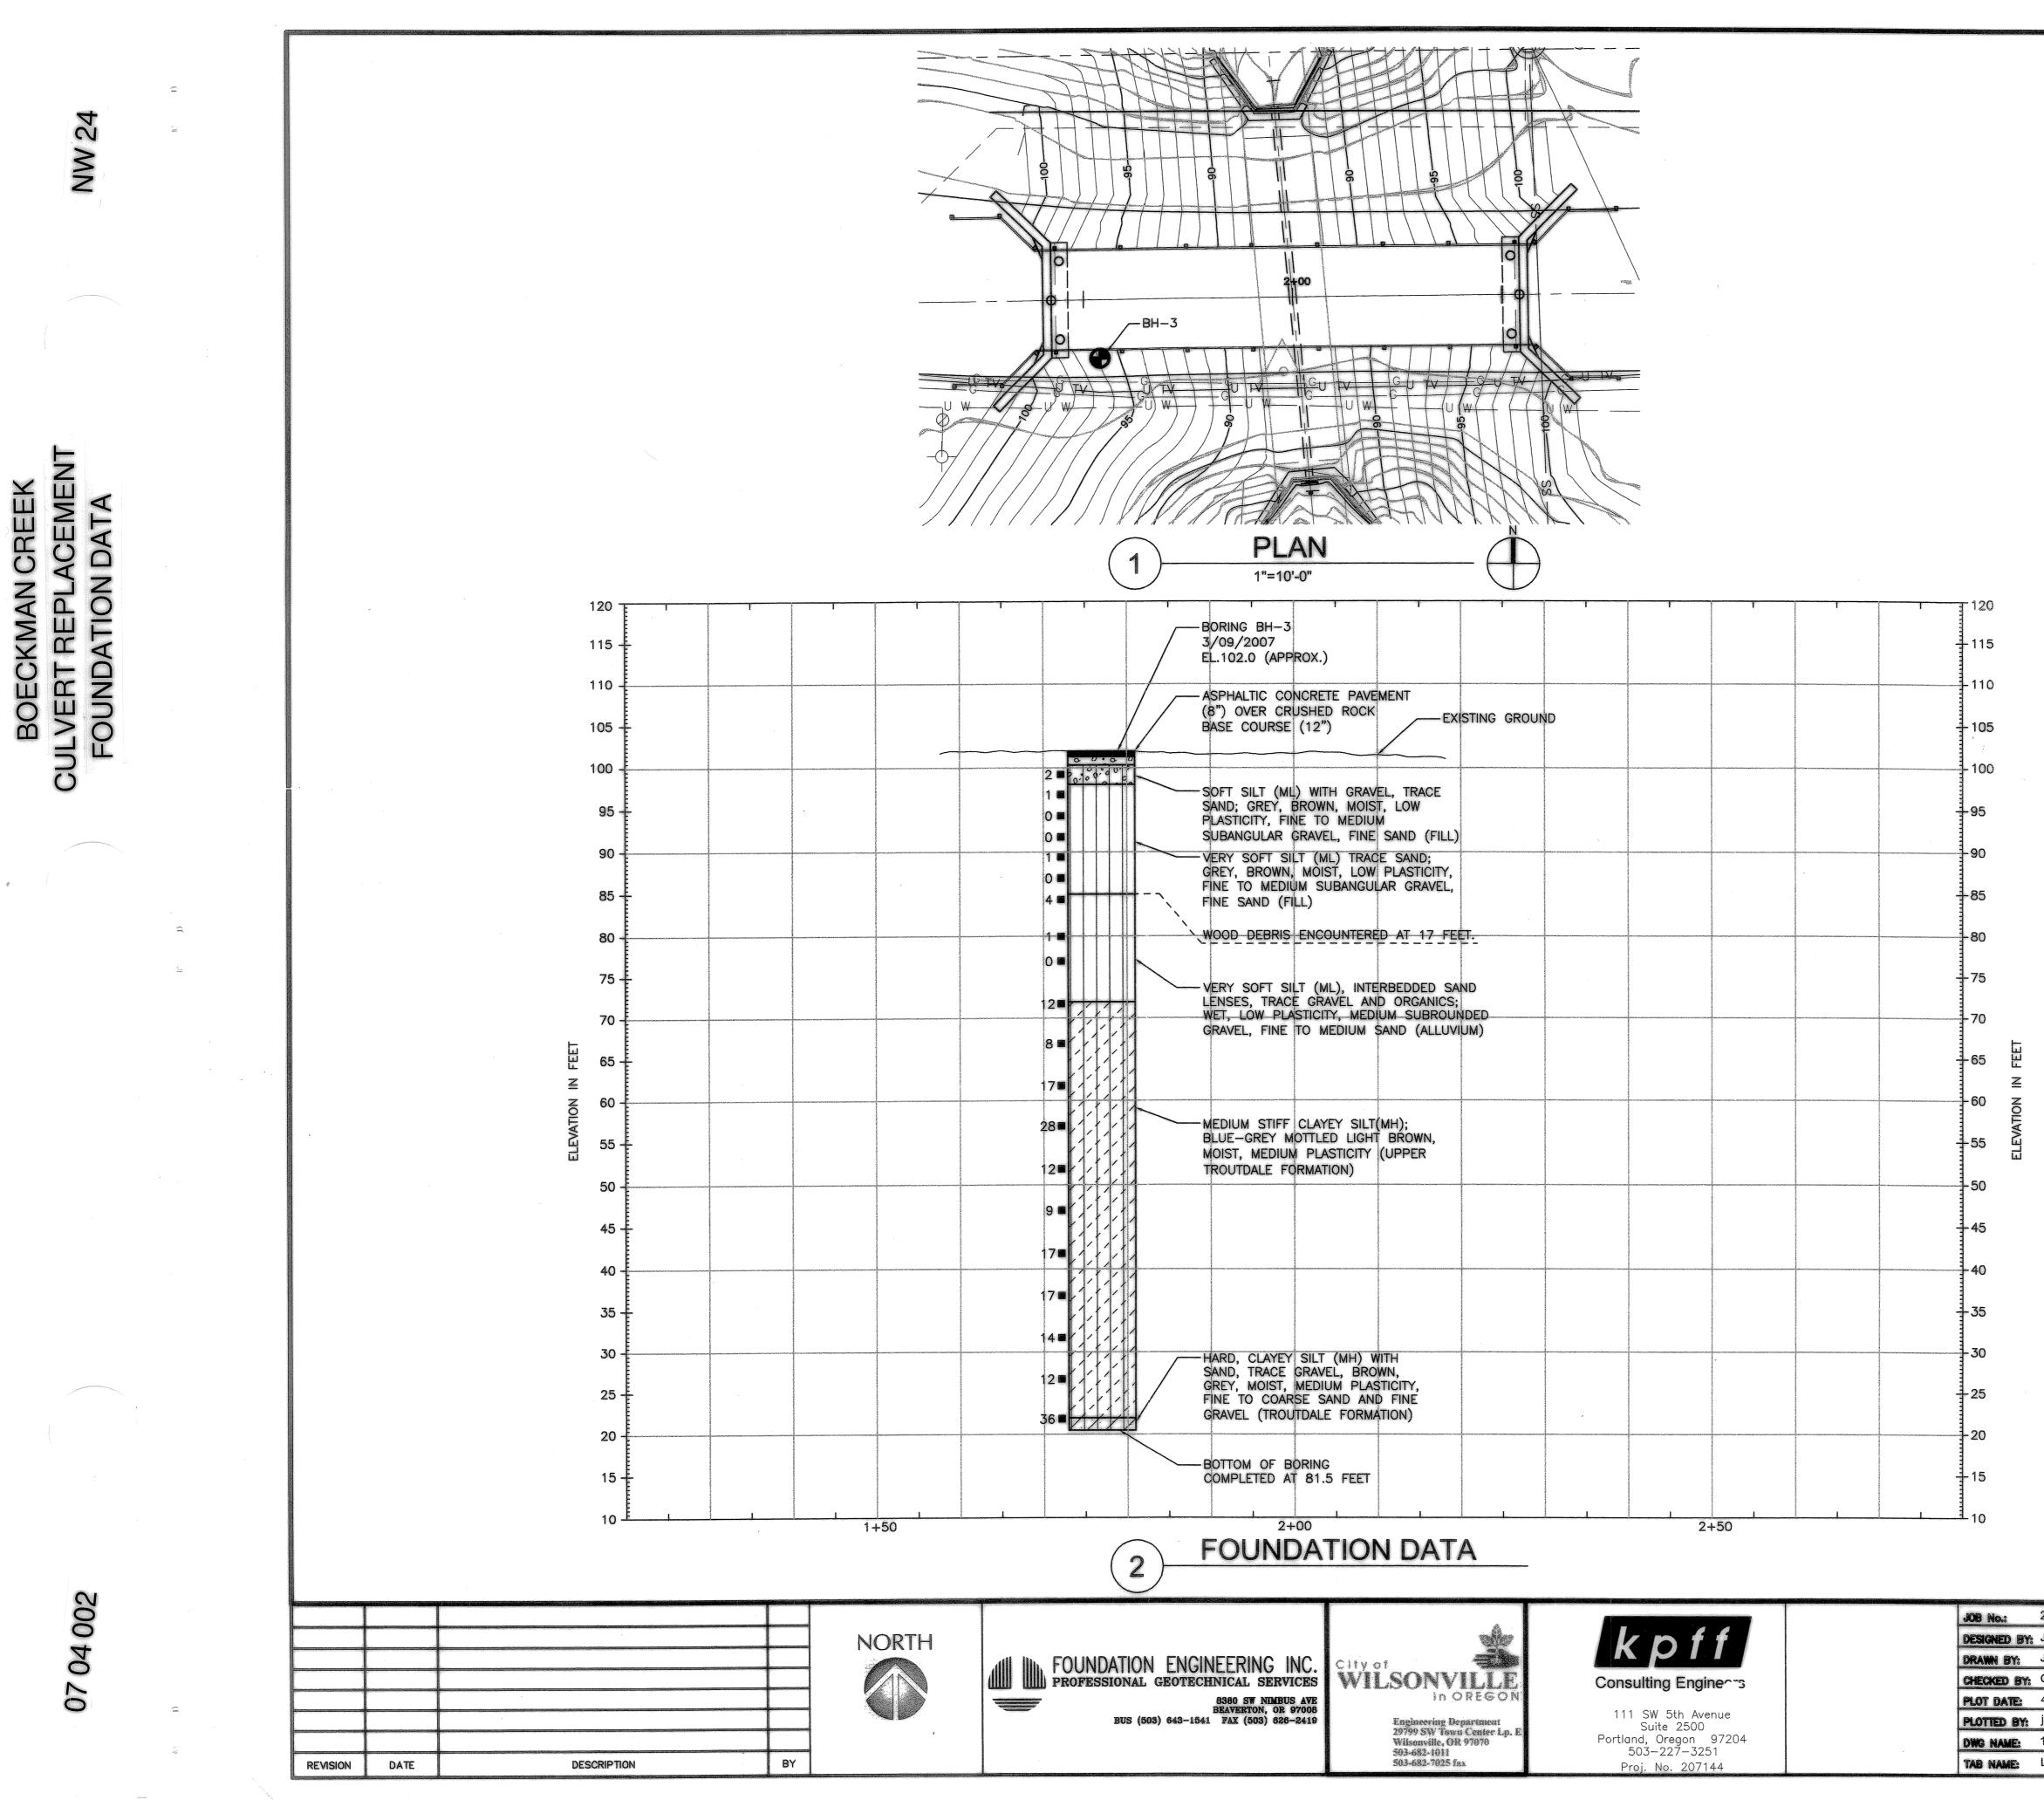
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	JOB No.:	207144
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	CHECKED BY:	CJT
	PLOT DATE:	4/10/08 2
	PLOTTED BY:	jwilkes
	DWG NAME:	13-207144
	TAB NAME:	Layout1

LEGEND OF MATERIALS



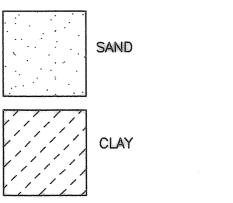



=DRILL HOLE LOCATION.

4 ■ =STANDARD PENETRATION TEST N VALUE.

TEST HOLE LOCATION AND ELEVATION ARE APPROXIMATE.

FOUNDATION DATA SHOWN ON THIS DRAWING IS A CONSOLIDATION OF INFORMATION AND/OR REVISION IN TERMINOLOGY FROM THE SOILS AND GEOTECHNICAL EXPLORATION LOGS. THE SOILS AND GEOTECHNICAL EXPLORATION LOGS USED IN COMPILING THIS DRAWING ARE AVAILABLE UPON REQUEST.

GROUNDWATER LEVEL ASSUMED TO BE AT THE ELEVATION OF BOECKMAN CREEK.


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RECORD DRAWING

	City of Wilsonville, 28799 SW Town Center Loop E, Wilsonville, Oregon 97070	an ann an	(HEET NO.	
:25pm	BOECKMAN CREEK FISH PASSAGE & STREAM RESTORATION PROJECT UPPER SITE (KOLBE LANE)		S2		
.dwg	FOUNDATION DATA	Sheet Record (13 NO.	23	

			E BENT 1 STA. 1+72.50	
		WINGWALL A, SEE DWG. S6 FOR DETAILS	1'-6" 1'-6" 1'-6" 1'-0" 1'-0" 1'-0" 1'-0" 1'-0" PP12¾"X0.5, TYP.	
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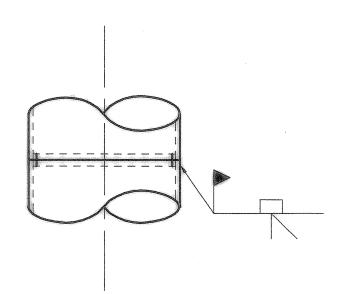



FOUNDATION NOTES

- 1. ALL BENTS PROVIDE 123/2"x0.500", ASTM A252 GRADE 2 PILING DRIVEN CLOSED-ENDED TO AN ULTIMATE CAPACITY OF 165 KIPS PER PILE.
- 2. ESTIMATED PILE TIP ELEVATION FOR REQUIRED CAPACITY AT ALL BENTS IS ELEVATION 36 FT.
- 3. DRIVE ALL PILING TO THE SPECIFIED ULTIMATE CAPACITY USING DRIVING CRITERIA DEVELOPED FROM THE ODOT GATES EQUATION.
- 4. LOCATE EXISTING UTILITIES PRIOR TO COMMENCEMENT OF WORK. AVOID DAMAGING AND PROTECT AS REQUIRED.
- 5. © PIPE PILE TO ALIGN WITH © OF TIMBER GIRDER. COORDINATE WITH APPROVED TIMBER BRIDGE SHOP DRAWINGS.

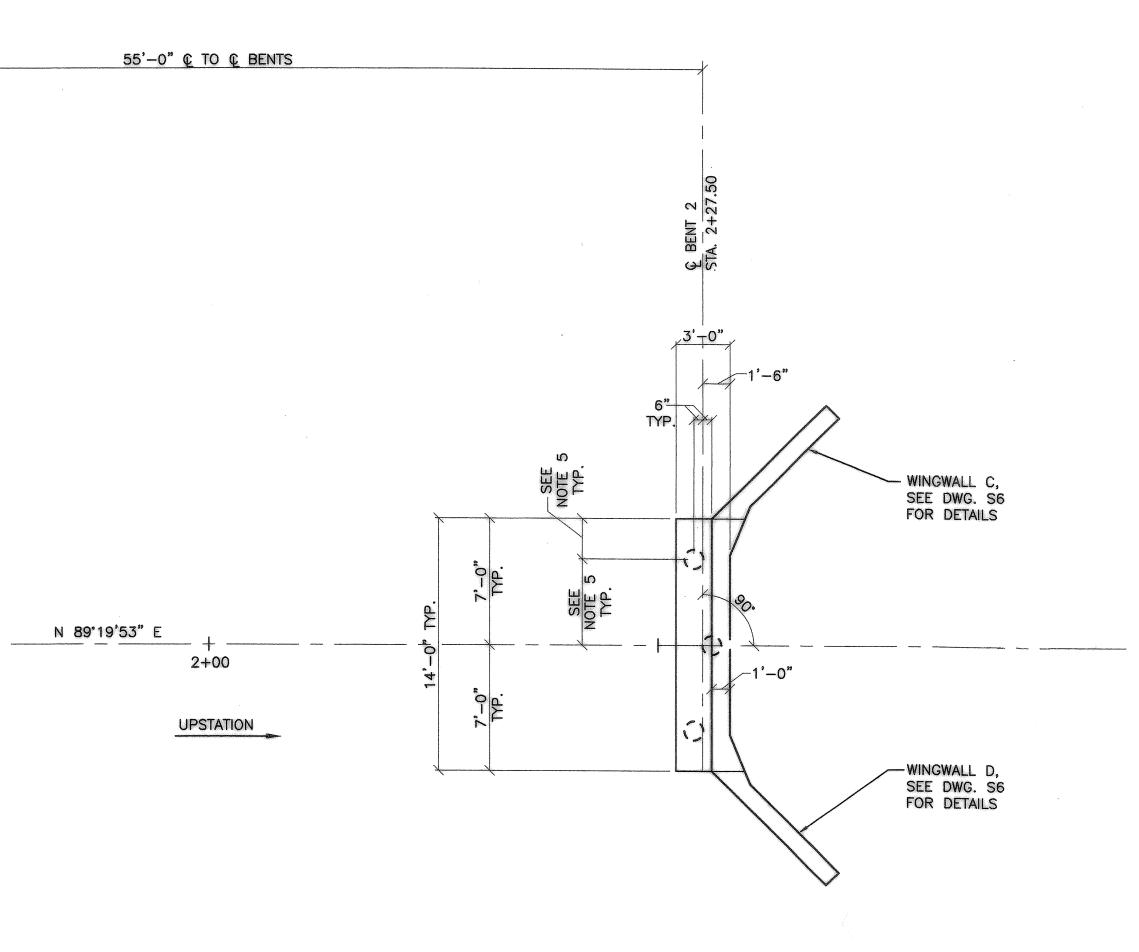Record Browings, Maps, and Plans Not Ausrantood

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NO SCALE

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RECORD DRAWING

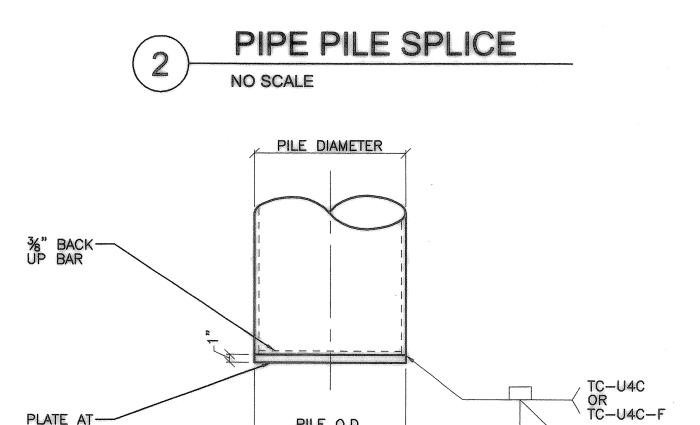
THIS DRAWING HAS BEEN UPDATED TO REFLECT CHANGES MADE DURING CONSTRUCTION BASED UPON CONSTRUCTION INSPECTOR'S NOTES AND AS-BUILT SURVEY MEASUREMENTS PERFORMED DURING CONSTRUCTION.

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and house and	City of Wilsonville, 28799 SW Town Center Loop E, Wilsonville, Oregon 97070			SH	et no.
	BOECKMAN CREEK FISH PASSAGE & STREAM RESTORATION PROJECT UPPER SITE (KOLBE LANE)		S	3	
	FOUNDALION PLAN	Sheet Record	14 NO.	OF	23






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RECORD DRAWING

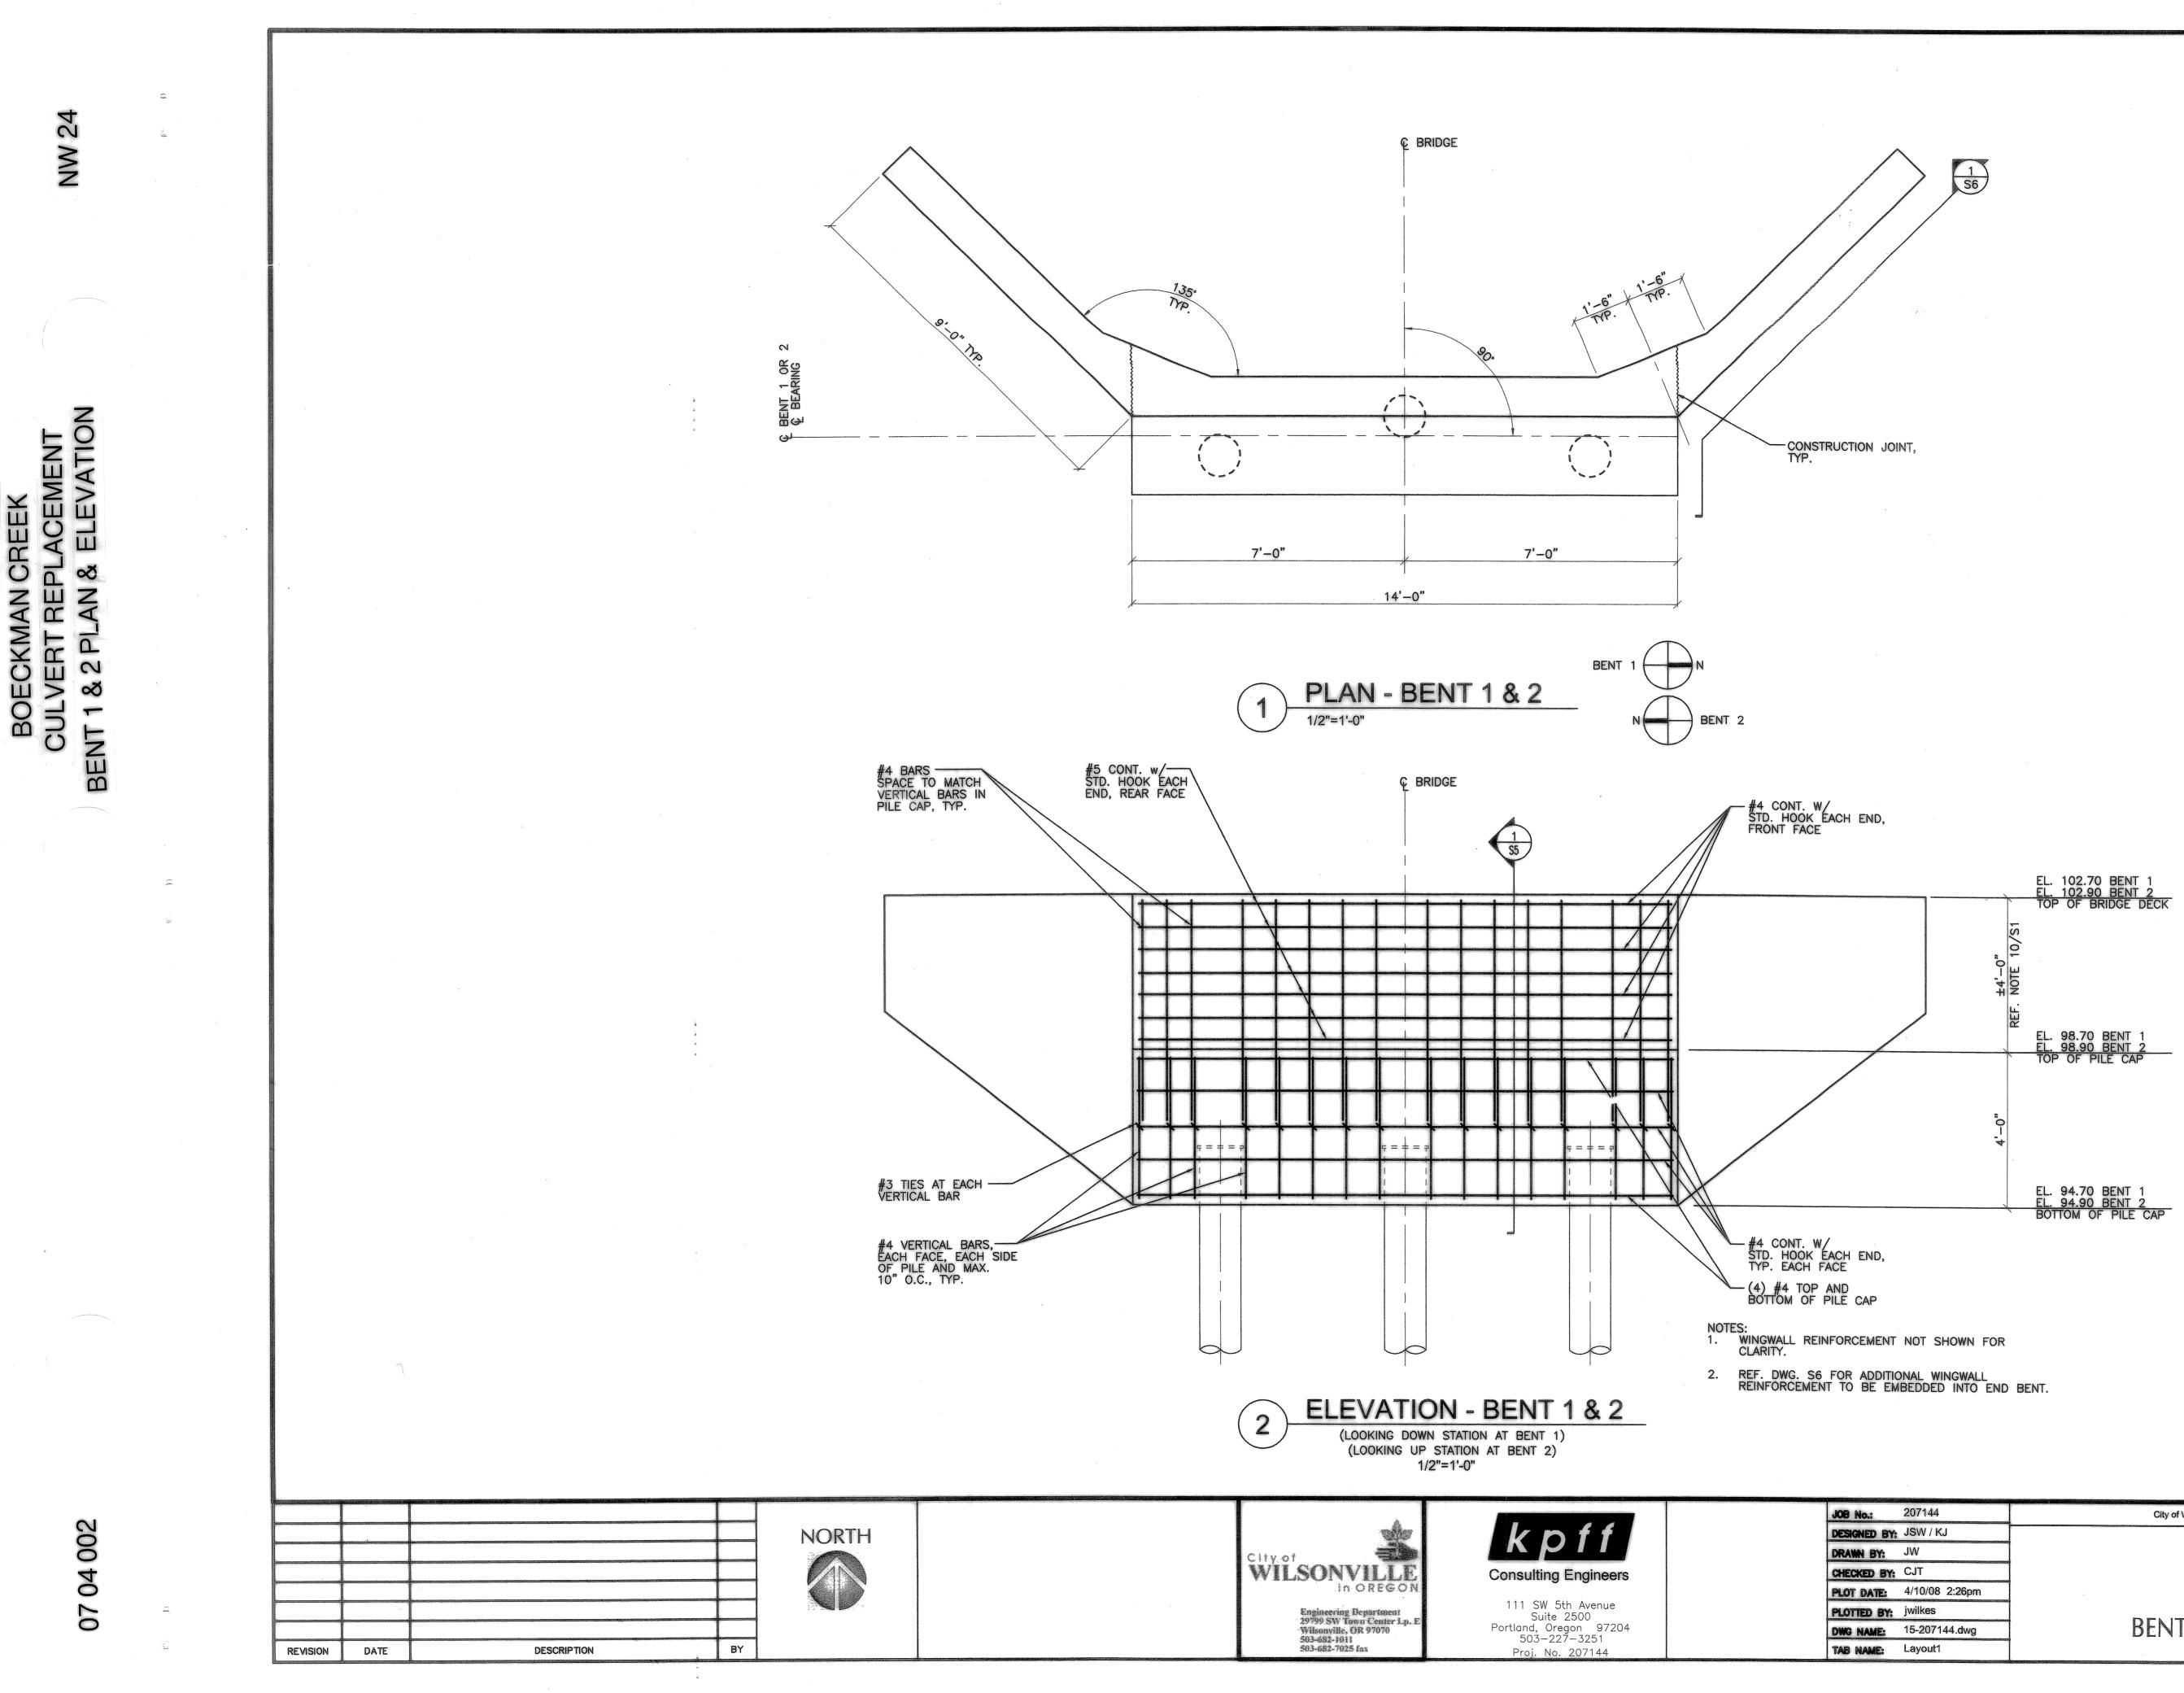	Boning Construction.	
	City of Wilsonville, 28799 SW Town Center Loop E, Wilsonville, Oregon 97070	Sheet No.
2:26pm	BOECKMAN CREEK FISH PASSAGE & STREAM RESTORATION PROJECT UPPER SITE (KOLBE LANE)	S4
4.dwg	I RENT 1 & 2 PLAN AND FLEVATION	Sheet 15 CF 23 Record No.




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	DESIGNED BY:	JSW / KJ
	DRAWN BY:	JW
	CHECKED BY:	CJT
	PLOT DATE:	4/10/08 2
	PLOTTED BY:	jwilkes
	DWG NAME:	16-207144
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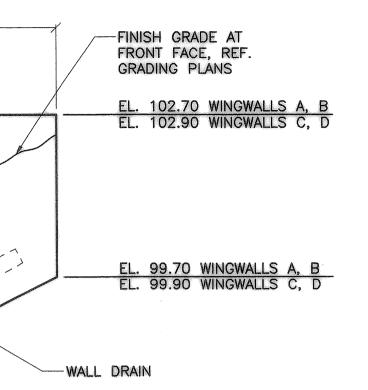
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BRIDGE DESIGNER

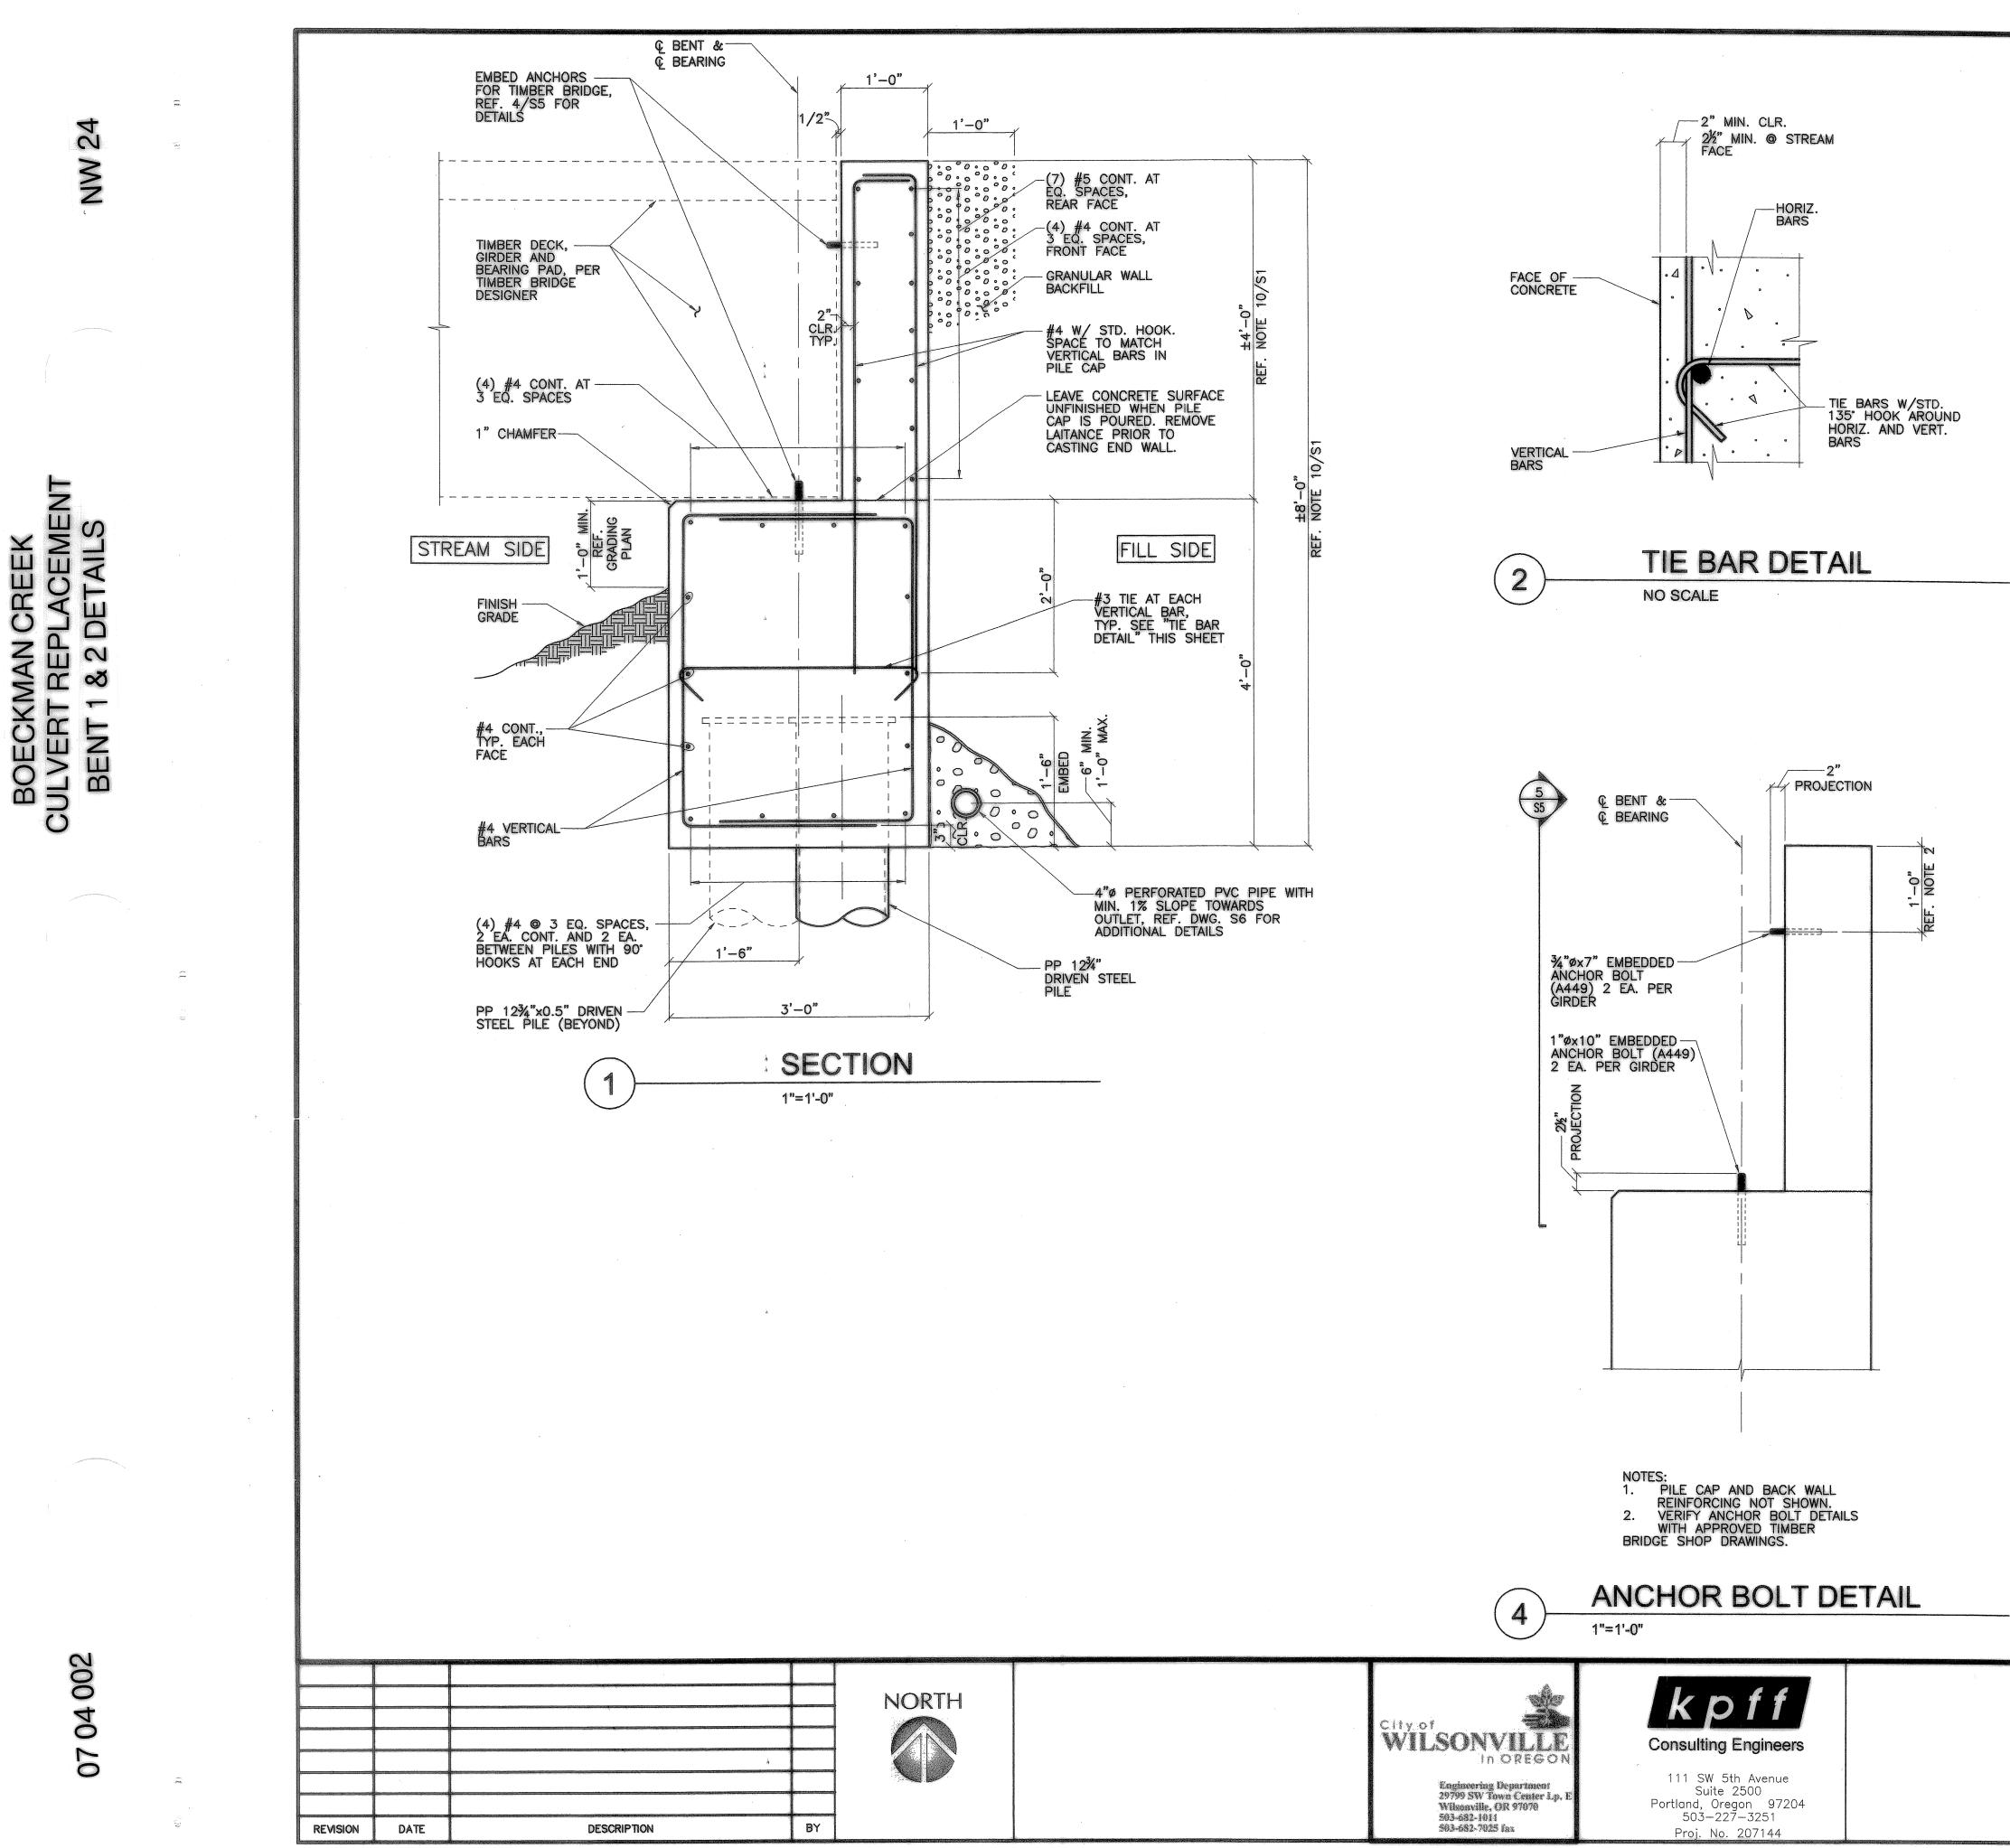
BY TIMBER BRIDGE DESIGNER, TYP.




Ç BENT NW 24 9'-0" EL. REF. 2/S4 3 56 0.000.000 2 56 BOECKMAN CREEK JLVERT REPLACEMENT WINGWALL DETAILS 0-EL. REF. 2/S4 --- CONNECT PIPE TO END BENT DRAIN. STUB PIPE DRAIN THROUGH WALL. TURN AND EXTEND DOWN SLOPE TO DAYLIGHT AT OUTLET EL.=95.0± NOTE: WINGWALLS A AND D SHOWN. WINGWALLS B AND C, MIRROR IMAGE. CUL WINGWALL ELEVATION 1/2"=1'-0" 1'-0" -1" CHAMFER, TYP. 2" CLR.) FRONT FACE REAR FACE #4 HORIZ. BAR AT 12" o.c. MAX. - GRANULAR WALL BACKFILL #4 VERTICAL BAR, @ 12" o.c. MAX. 1'-0" #5 HORIZONTAL BAR @ 6" o.c. MAX. 4"¢ Continuous Perforated PVC Wall Drain BOTTOM ROW HORIZ.— BARS TO FOLLOW BOTTOM OF WALL PROFILE, FULL LENGTH OF WALL 0. 0.0 000 ° 0 . of of o 0 -- 1½"--¾" GRANULAR DRAIN BACKFILL WRAPPED w/ DRAINAGE GEOTEXTILE TYPE1 CAST ON COMPACTED -FILL OR UNDISTURBED GROUND IN CUT LOCATIONS ويعاديه والمحالية والمحار والمحاركة المحالية المحالية والمحالية والمح WINGWALL SECTION 4 3/4"=1'-0" 04 002 NORTH 07 ينتعتر DATE BY REVISION DESCRIPTION

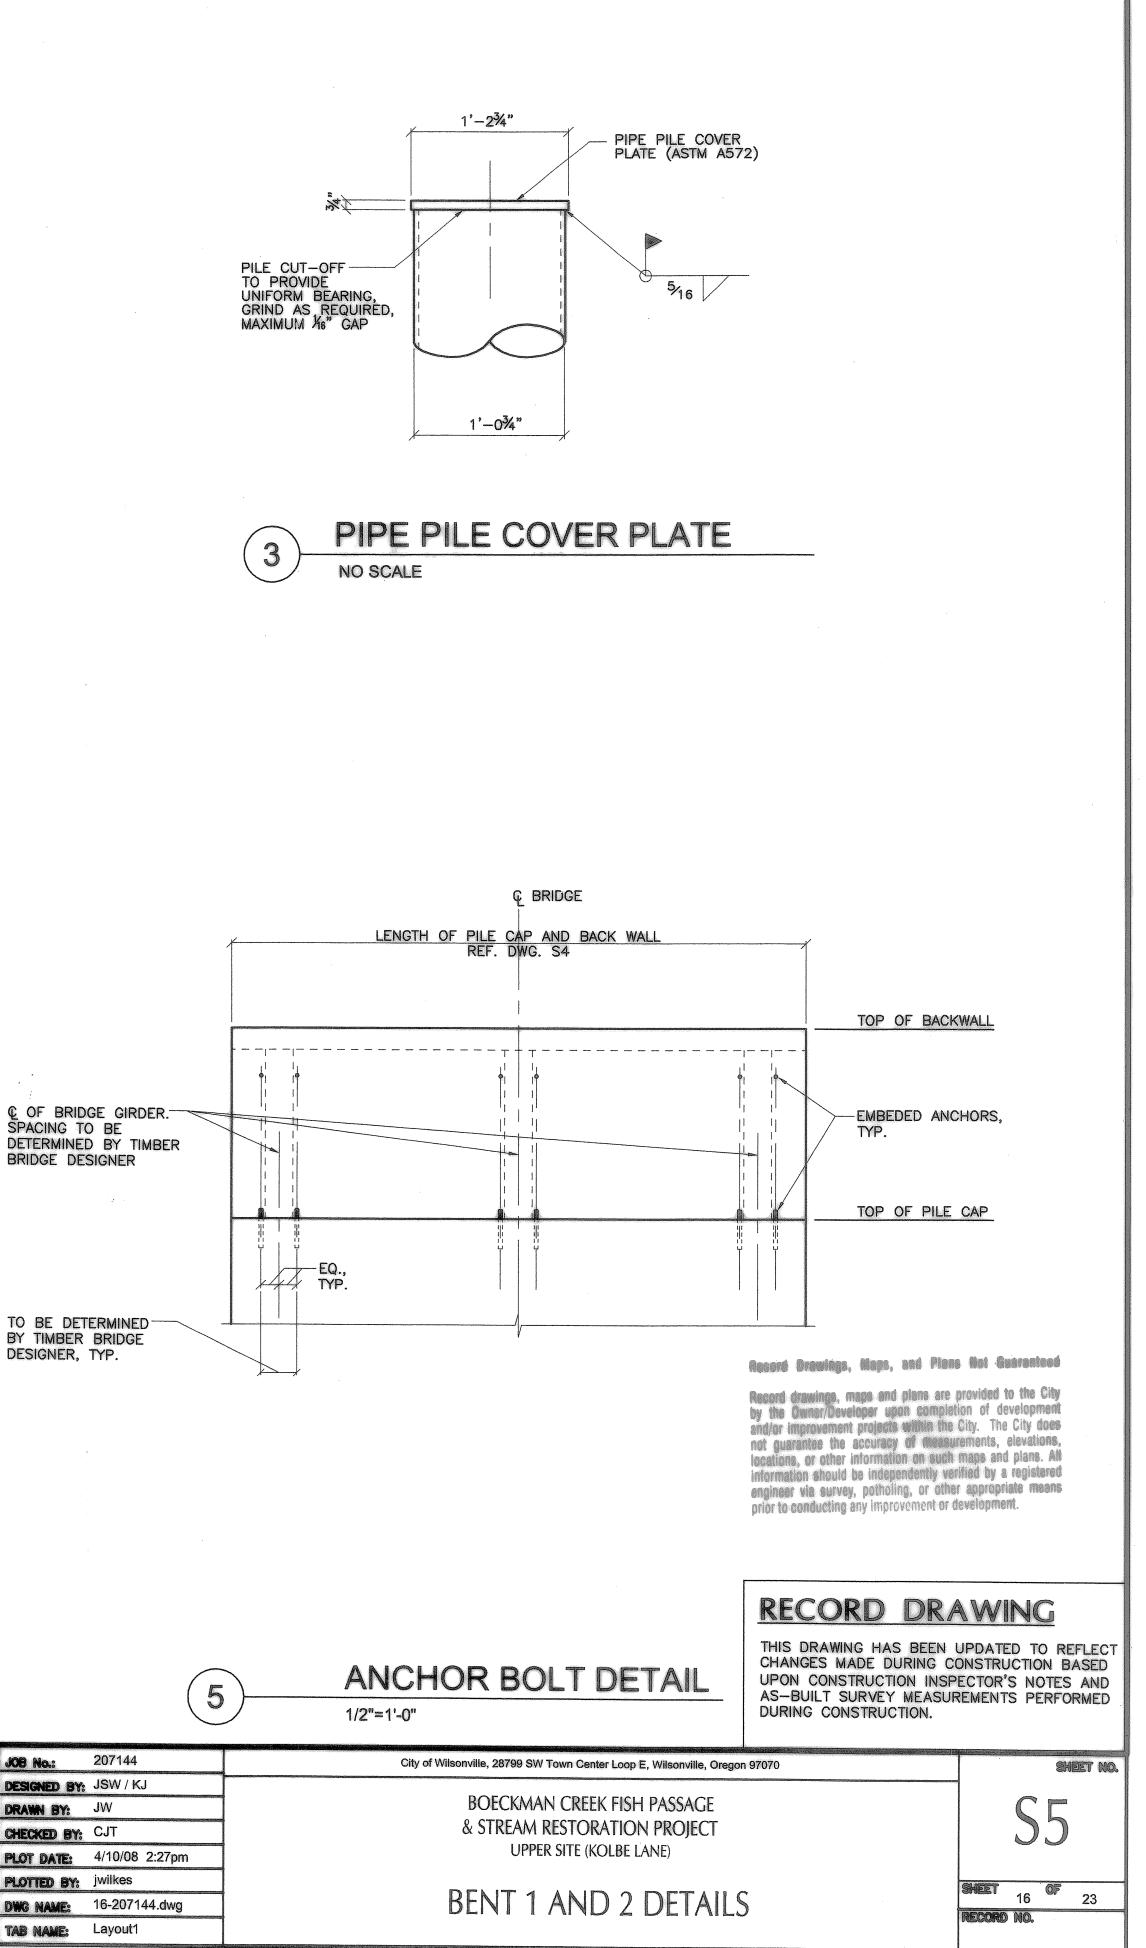



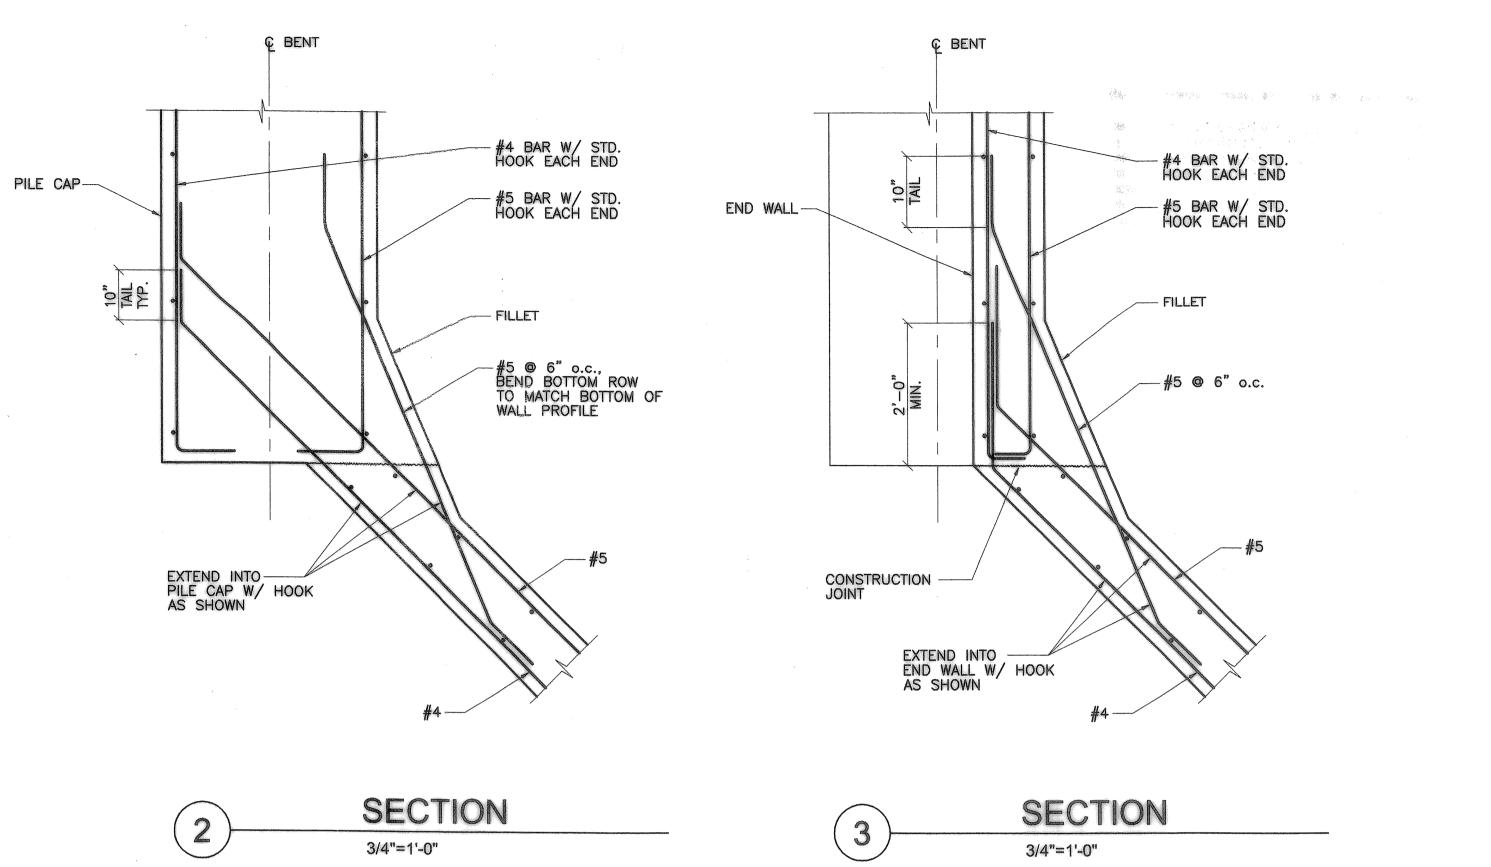

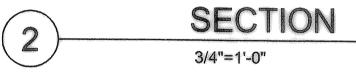





111 SW 5th Avenue Suite 2500 Portland, Oregon 97204 503-227-3251 Proj. No. 207144


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RECORD DRAWING

	City of Wilsonville, 28799 SW Town Center Loop E, Wilsonville, Oregon 97070	Sheet no.
28pm	BOECKMAN CREEK FISH PASSAGE & STREAM RESTORATION PROJECT UPPER SITE (KOLBE LANE)	S6
dwg	WINGWALL DETAILS	Sheet 17 OF 23 Record No.



IPPER BOECKMAN CREEK TURNAROUND PLANTING AREA Spacing Size/Form % Common Name 24 PAVER SEED MIX (2 lbs./1,000 sf) Achillee millefolium seed common yarrow MN seed California brome omus carinatus seed Clarkia amoena godetia blue wildrye seed Elymus glaucus schscholzia californica California poppy seed Trifolium fragiferum Salina strawberry clover se VISUAL SCREEN (AROUND PERIMETER/OUTSIDE OF PAVERS) seed 20' O.C. 1 gallon Arbutus menziesii madrone 4' O.C. 1 gallon tostaphylus uva-ursi kinnickinnick 8' O.C. 1 gallon enothus sanguineus red stem ceanothus amnus purshiana cascara 8' O.C. 1 gallon red flowering currant 8' O.C. 1 gallon bes sanguineum UPPER BOECKMAN CREEK PALUSTRINE SCRUB-SHRUB PLANTING AREA Sze/Form lotanical Name Common Name Spacing Š Nodding beaggartick | 1' O.C. 4" pot idens cernua 1 gallon Cornus stolonifera Red-osier dogwood 6' O.C S LACEMENT 10' 0.0 Douglas hawthorn Crataegus douglasii **DETAIL** 15' O.C. 1 gallon Fraxinus latifolia Oregon ash 6" O.C. Lincus patens Spreading rush plug 3' O.C. **Clustered** rose Rosa pisocarpa 15' O.C **Pacific willow** pole cuttings Salix lasiandra **LIST** 8' O.C. 1 gallon Scouler willow Salix scouleriana Scouler willow 3' O.C. cuttings Salix scouleriana AN, 8' O.C. 1 gallon Stka willow Salix sitchensis ANT 3' O.C. Stka willow cuttings Salix sitchensis 15' O.C pole cuttings** BOECKMAN ambucus cerulea | blue elderberry D D Δ 3' O.C. 200 i galion Spiraea douglasi/ Douglas spirea Ш rooted seedling or 1 galon **5-8 feet in height ANTING Ω VERT **BOECKMAN CREEK** SUL Ω XX NEW BRIDGE \bigcirc TURF PAVER TURNAROUND AREA . WETLAN 0000000 000506 a tan Turke JOHN VAN STAVEREN 8/18/1995 MELTYNO 002 NORTH \bigcirc 64 07 BY DATE DESCRIPTION REVISION


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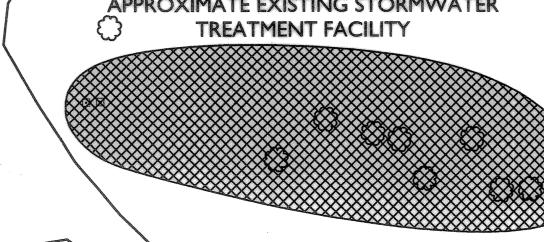
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Beckmannia syzigachne	American sloughgrass	6" O.C.	plug	200
Eleocharis palustris	Creeping spike rush	6" O.C.	plug	300
Scirpus microcarpus	Small-fruited bulrush	6* O.C.	plug	100
Veronica americana	American Brooklime	1' O.C.	plug	50
Veronica scutellata	Marsh speedwell	6" O.C.	plug	50
Salix scouleriana	Scouler willow	3' O.C.	cuttings	100
Salix sitchenis	Stka willow	3' O.C.	cuttings	150

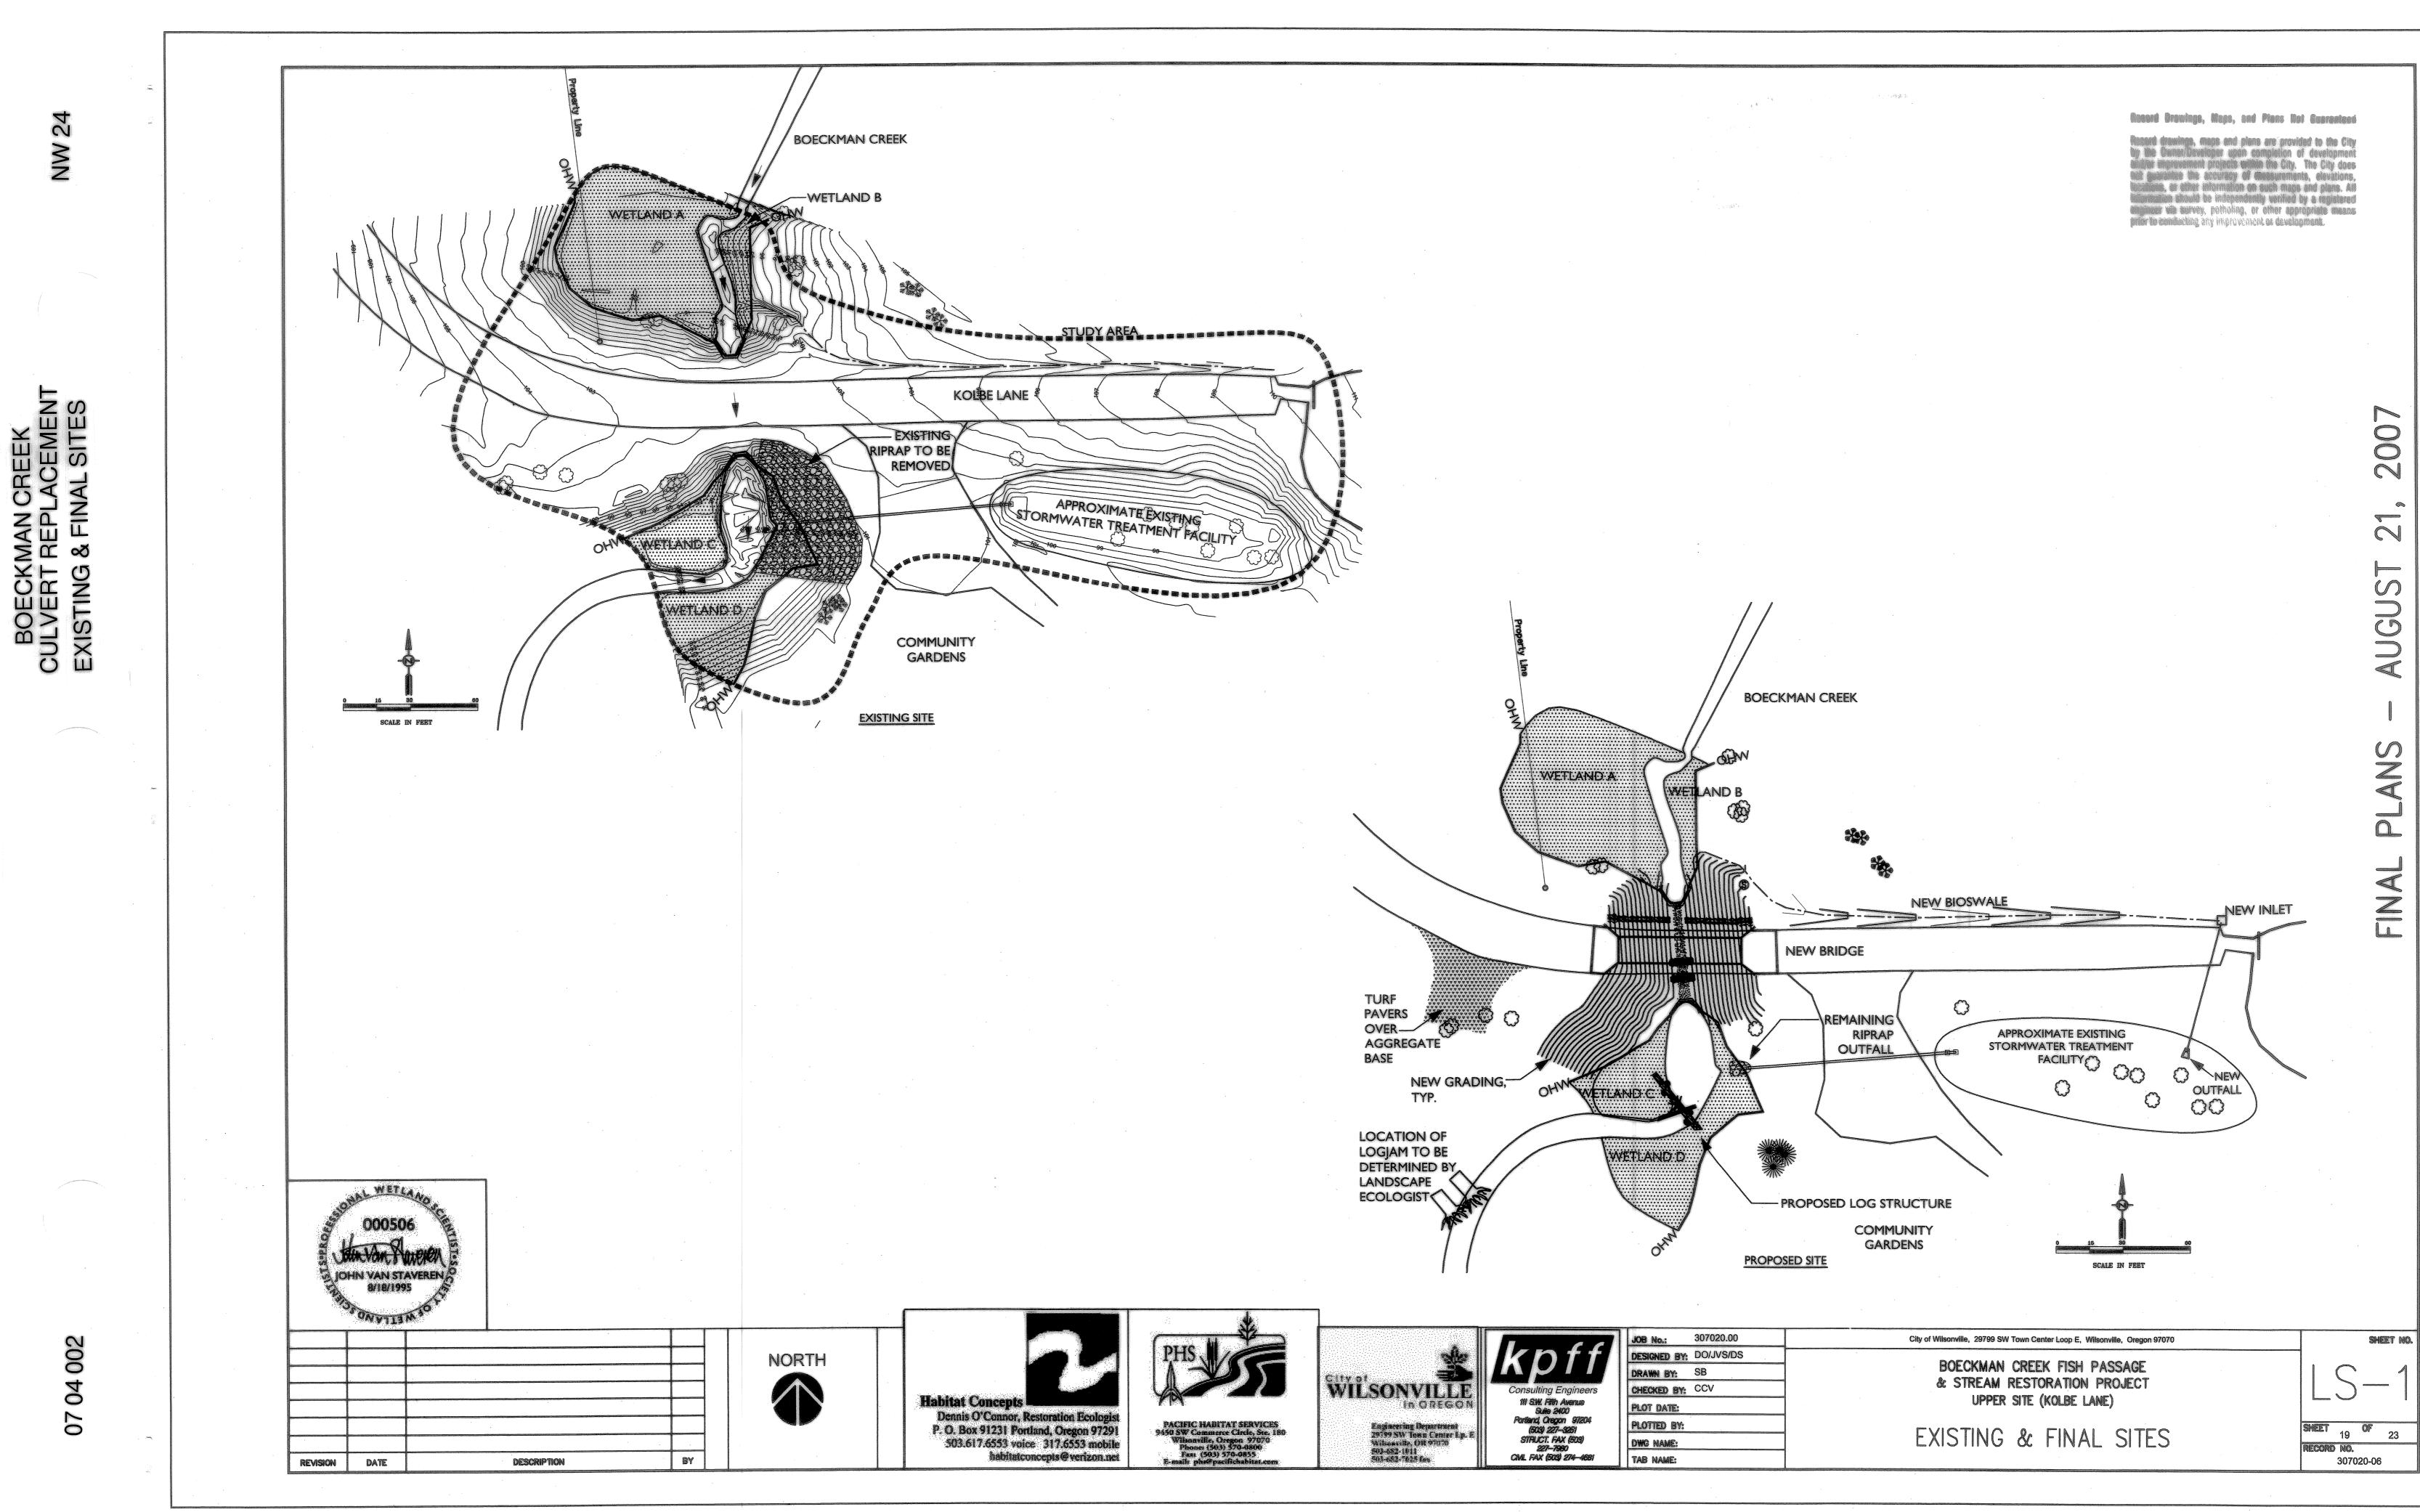Botanical Name	Common Name	Spacing	Sze/Form	Quantity
Abies grandis	Grand fir	30' O.C.	1 gallon	5
Acer circinatum	Vine maple	10 O.C.	rooted seedling	25
Acer macrophyllum,	Big leaf maple	30' O.C.	1 gallon	6
Alnus rubra	Red alder	15'O.C.	1 gallon	1 30
Arbutus menziesii	Madrone	20' O.C.	1 gellon	10
Arctoslaphyllos uva-ursi	Kinnickinnick	2' O.C.	4" pot	200
Camassia quamash	Common camas	1' O.C.	bulb	50
Ceenalhus sanguineus	Oregon redstem ceanothus	6' O.C.	1 gellon	20
Comus nultaliii	Pacific dogwood	10' O.C.	5 gallon	10
Hotodiscus discolor	Oceanspray	6' O.C.	1 gallon	50
Lonicera ciliosa	Orange honeysuckle	4' O.C.	1 gallon	50
Quercus genyana	Oregon white oak	25' O.C.	1 gallon	10
Riamus purstiana	Cascara	6' O.C.	1 gellon	50
Ribes sanguineum	Red flowering currant	5' O.C.	1 gallon	50
Simphoricarpos albus	Showberry	4' O.C.	1 gallon	100
UPLAND FOREST S	EEDIMIX			
Bromus carinatus	Native California brome		seed	10 lb/acrs
Bymus glaucus	Blue wildrye		seed	15 lb/acre


Botanical Name	Common Name	% of Mix
GRASSES (30 LBS/ACRE)		
Agrostis exarata	spike bentgrass	10
Beckmannia syzigachne	American sloughgrass	20
Deschampsia cespitosa	tufted hairgrass	15
Deschampsia elongata	slender hairgrass	15
Gyceria Occidentalis	western mannagrass	10
Hordeum brachyantherum	meadow barley	30
FORBS & WILDFLOWERS (5 LBS/ACRE)	
Downingia elegans	downingia	15
Epilobium densiflorum	dense spike primrose	35
Lupinus polyphyllus	streamside lupine	35
Sisyrinchium angustifolium	blue-eyed grass	15
SED GES, RUSHES, EMERGEI	NTS (10 LBS/ACRE)	
Alisma plantago-aquatica	water plantain	25
Carex obnupta	slough sedge	50
Eleocharis ovata	ovate spike rush	25





VEGETATED SWALE
KOLBE LANE
APPROXIMATE EXISTING STORMWAT

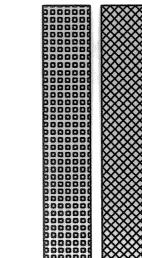





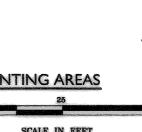


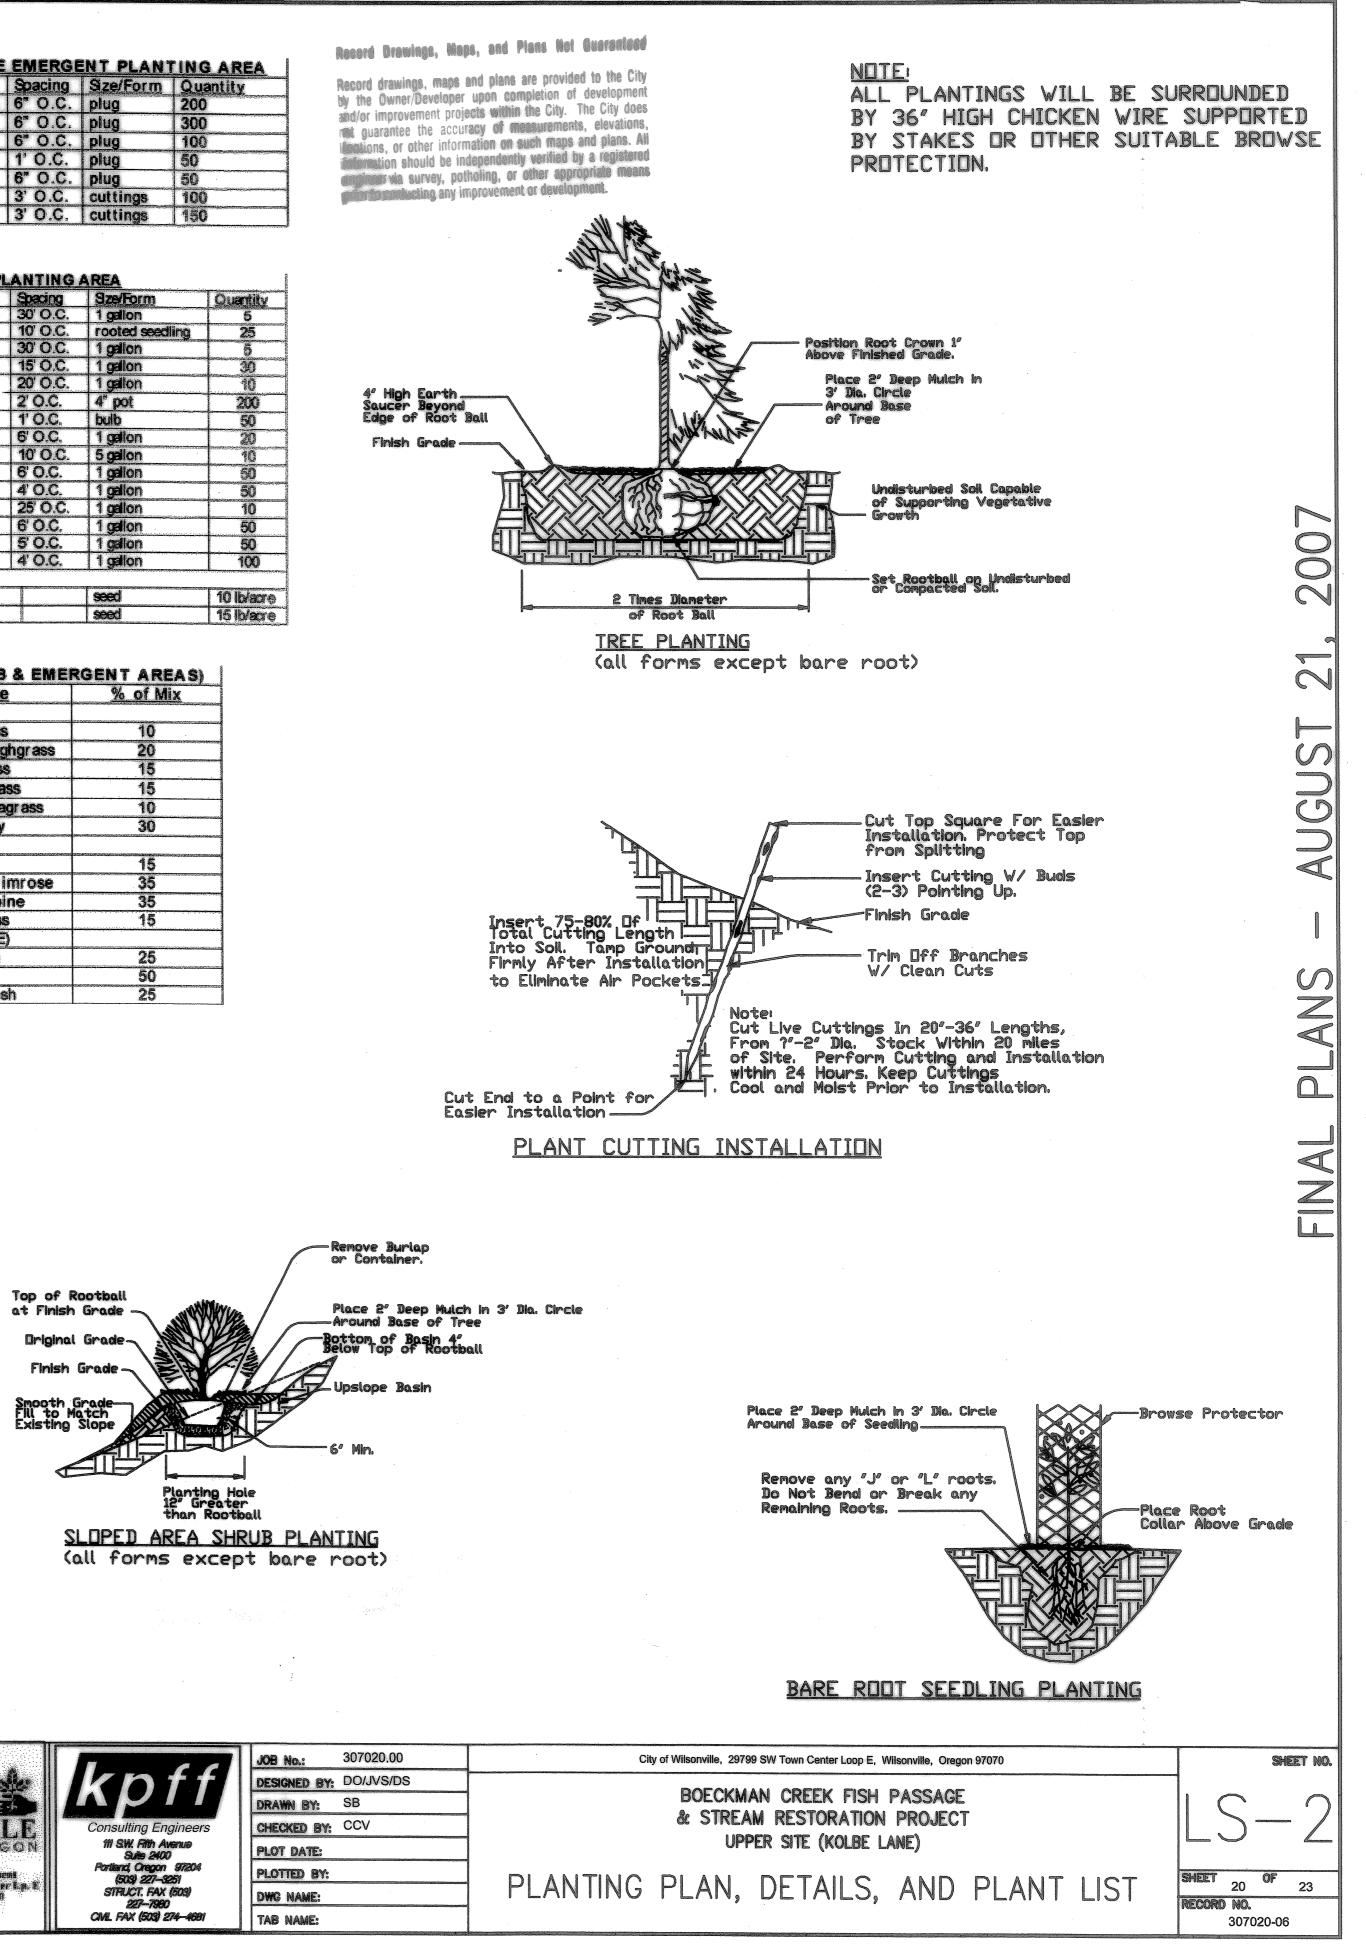


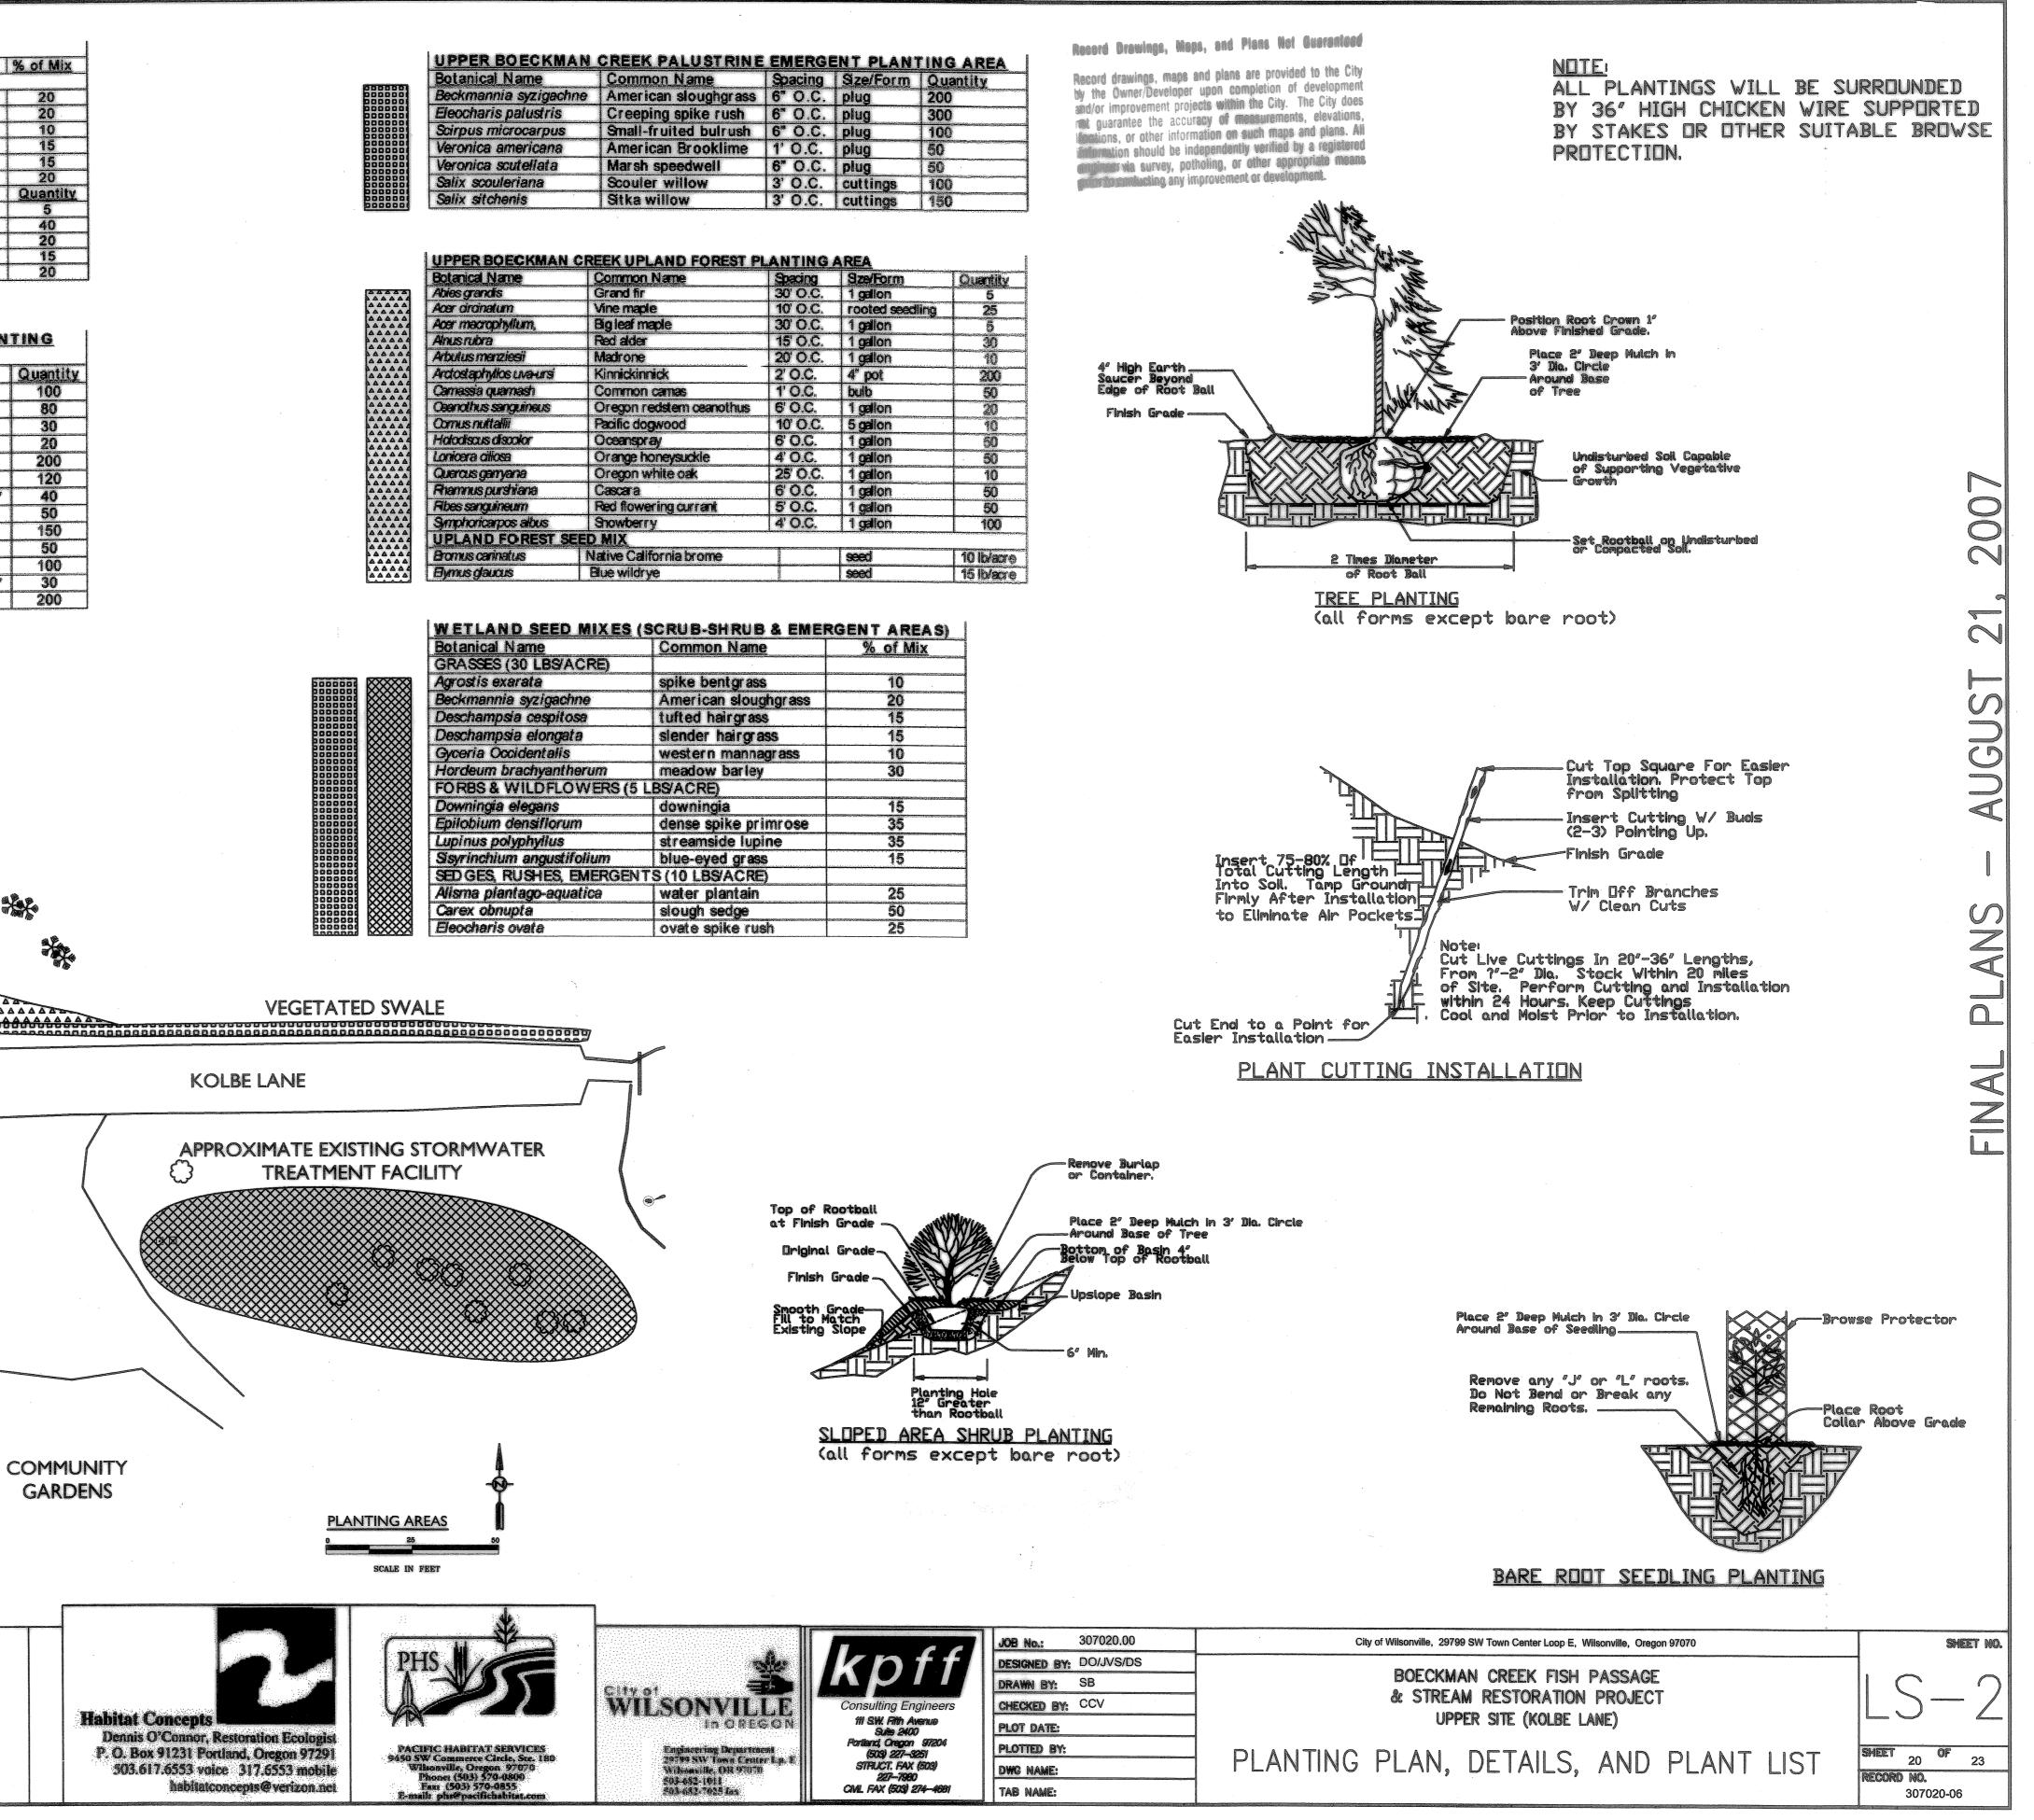


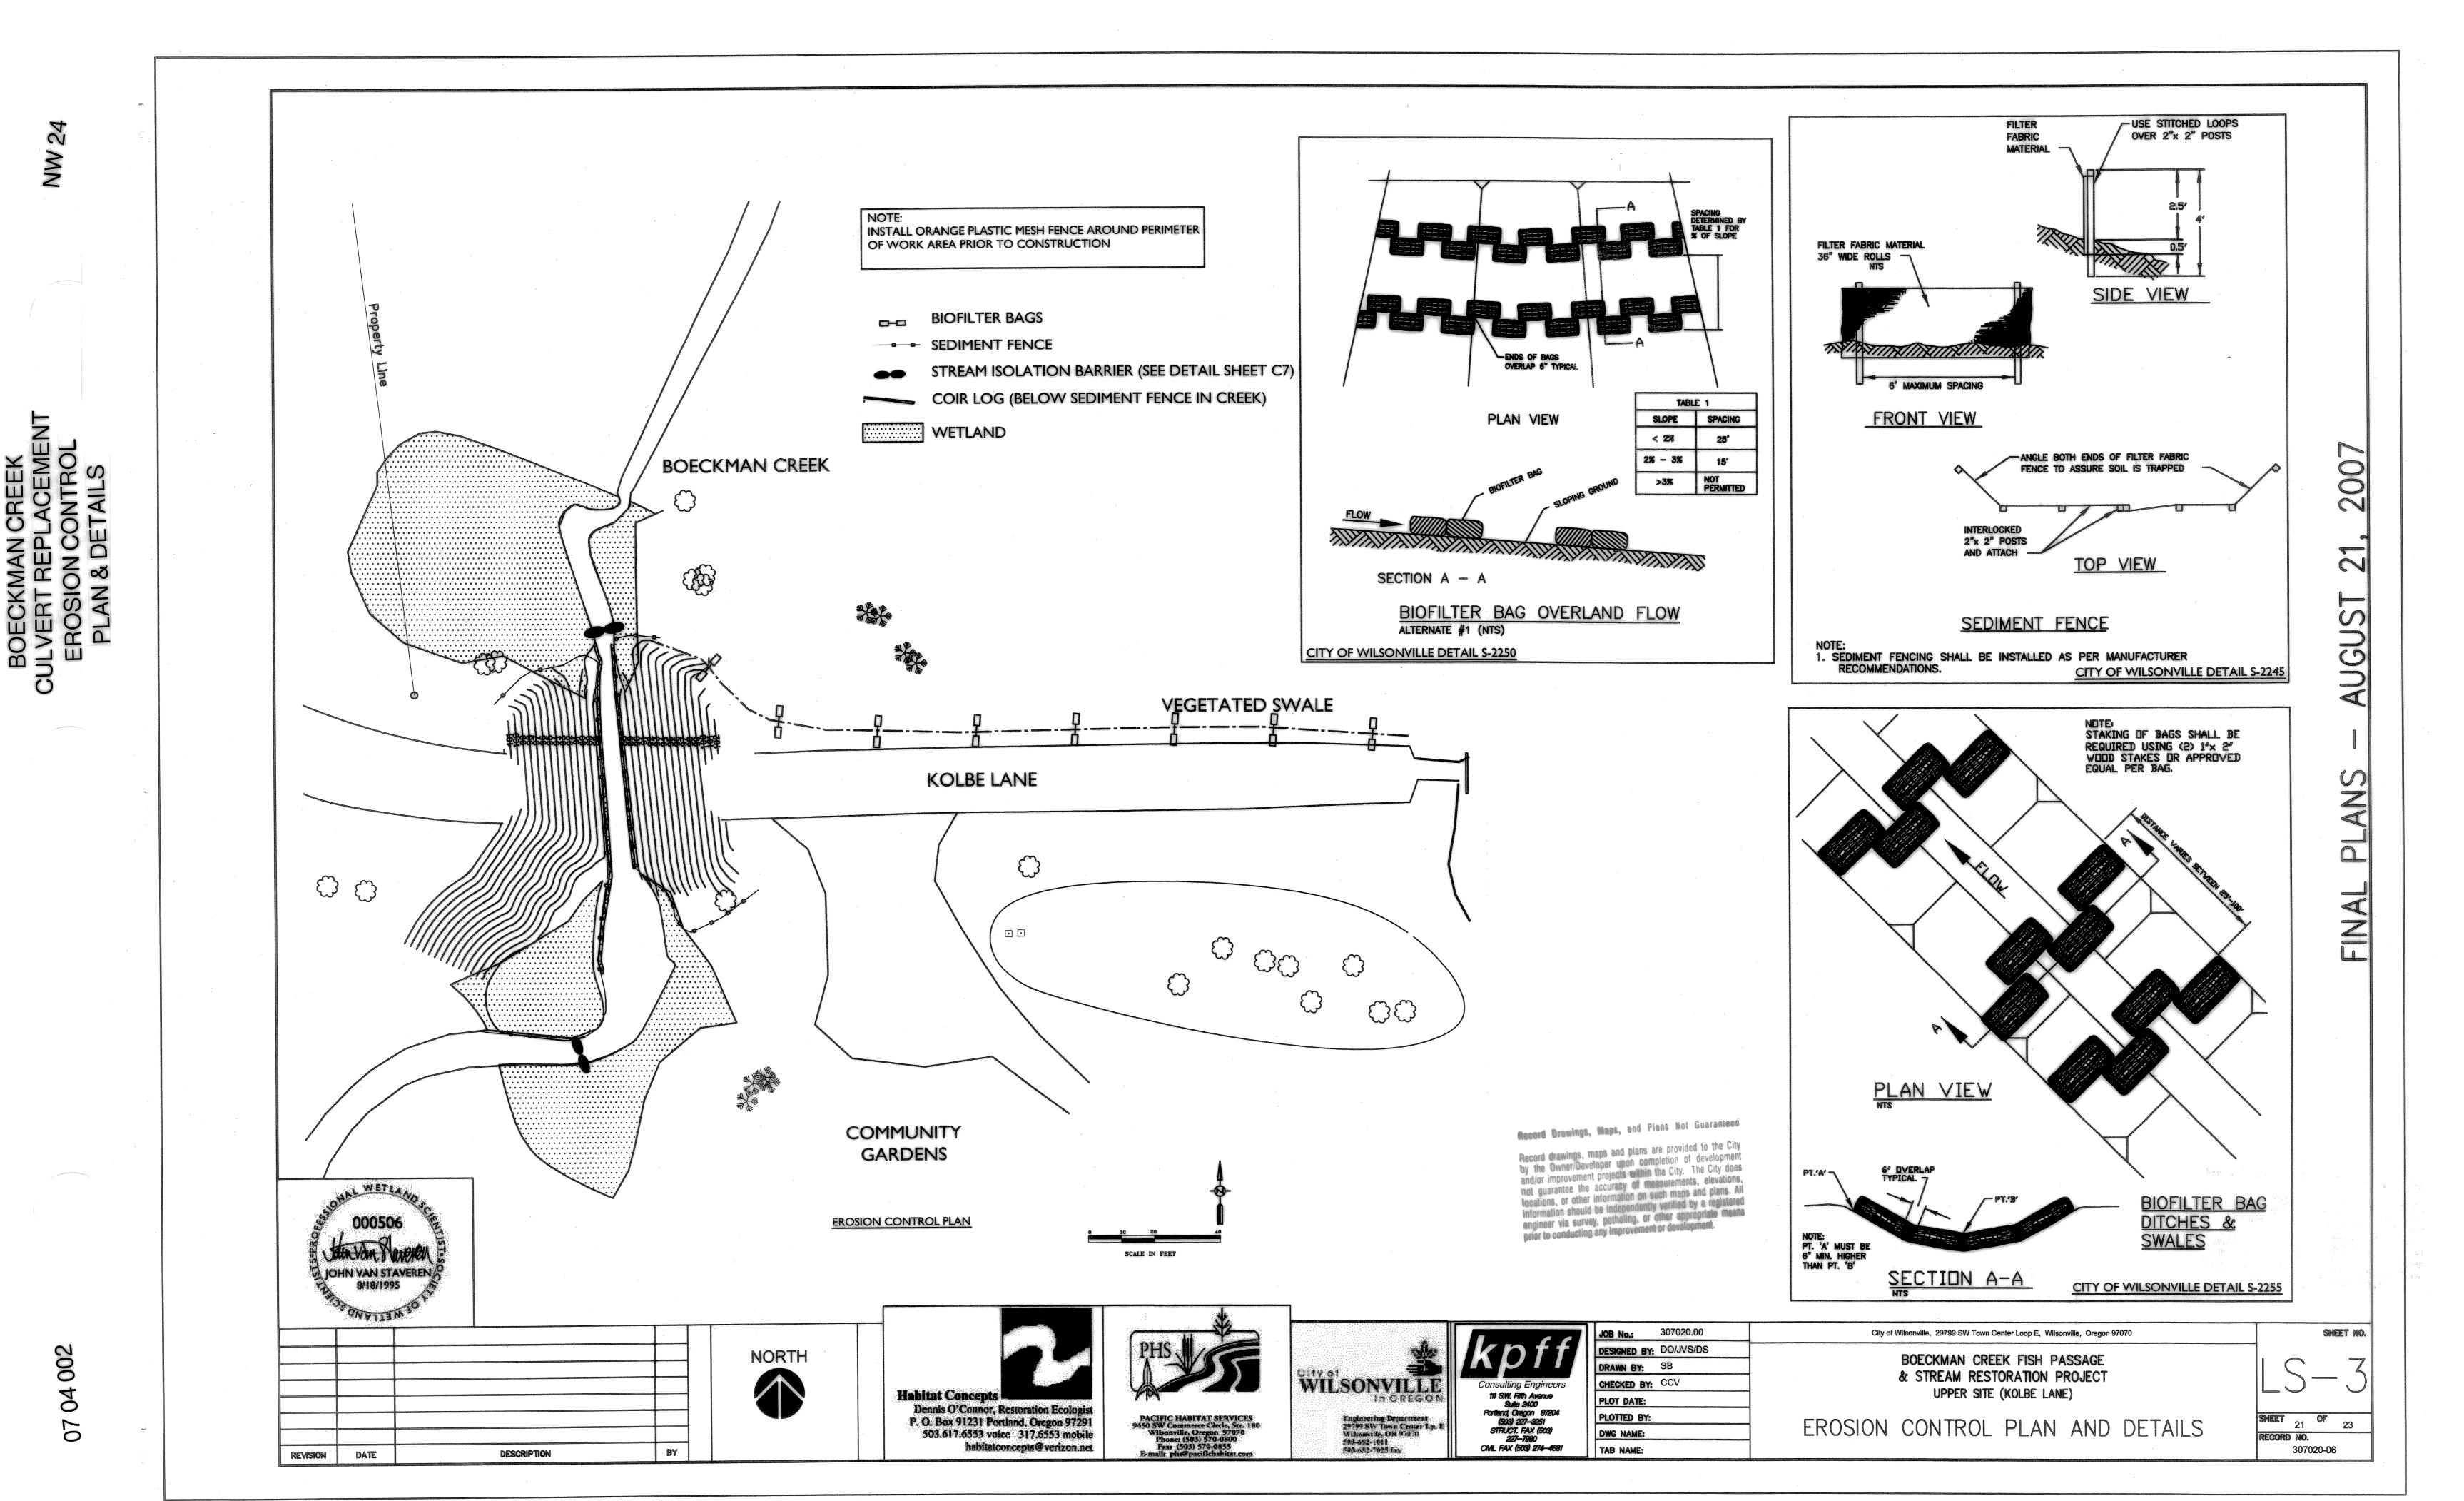


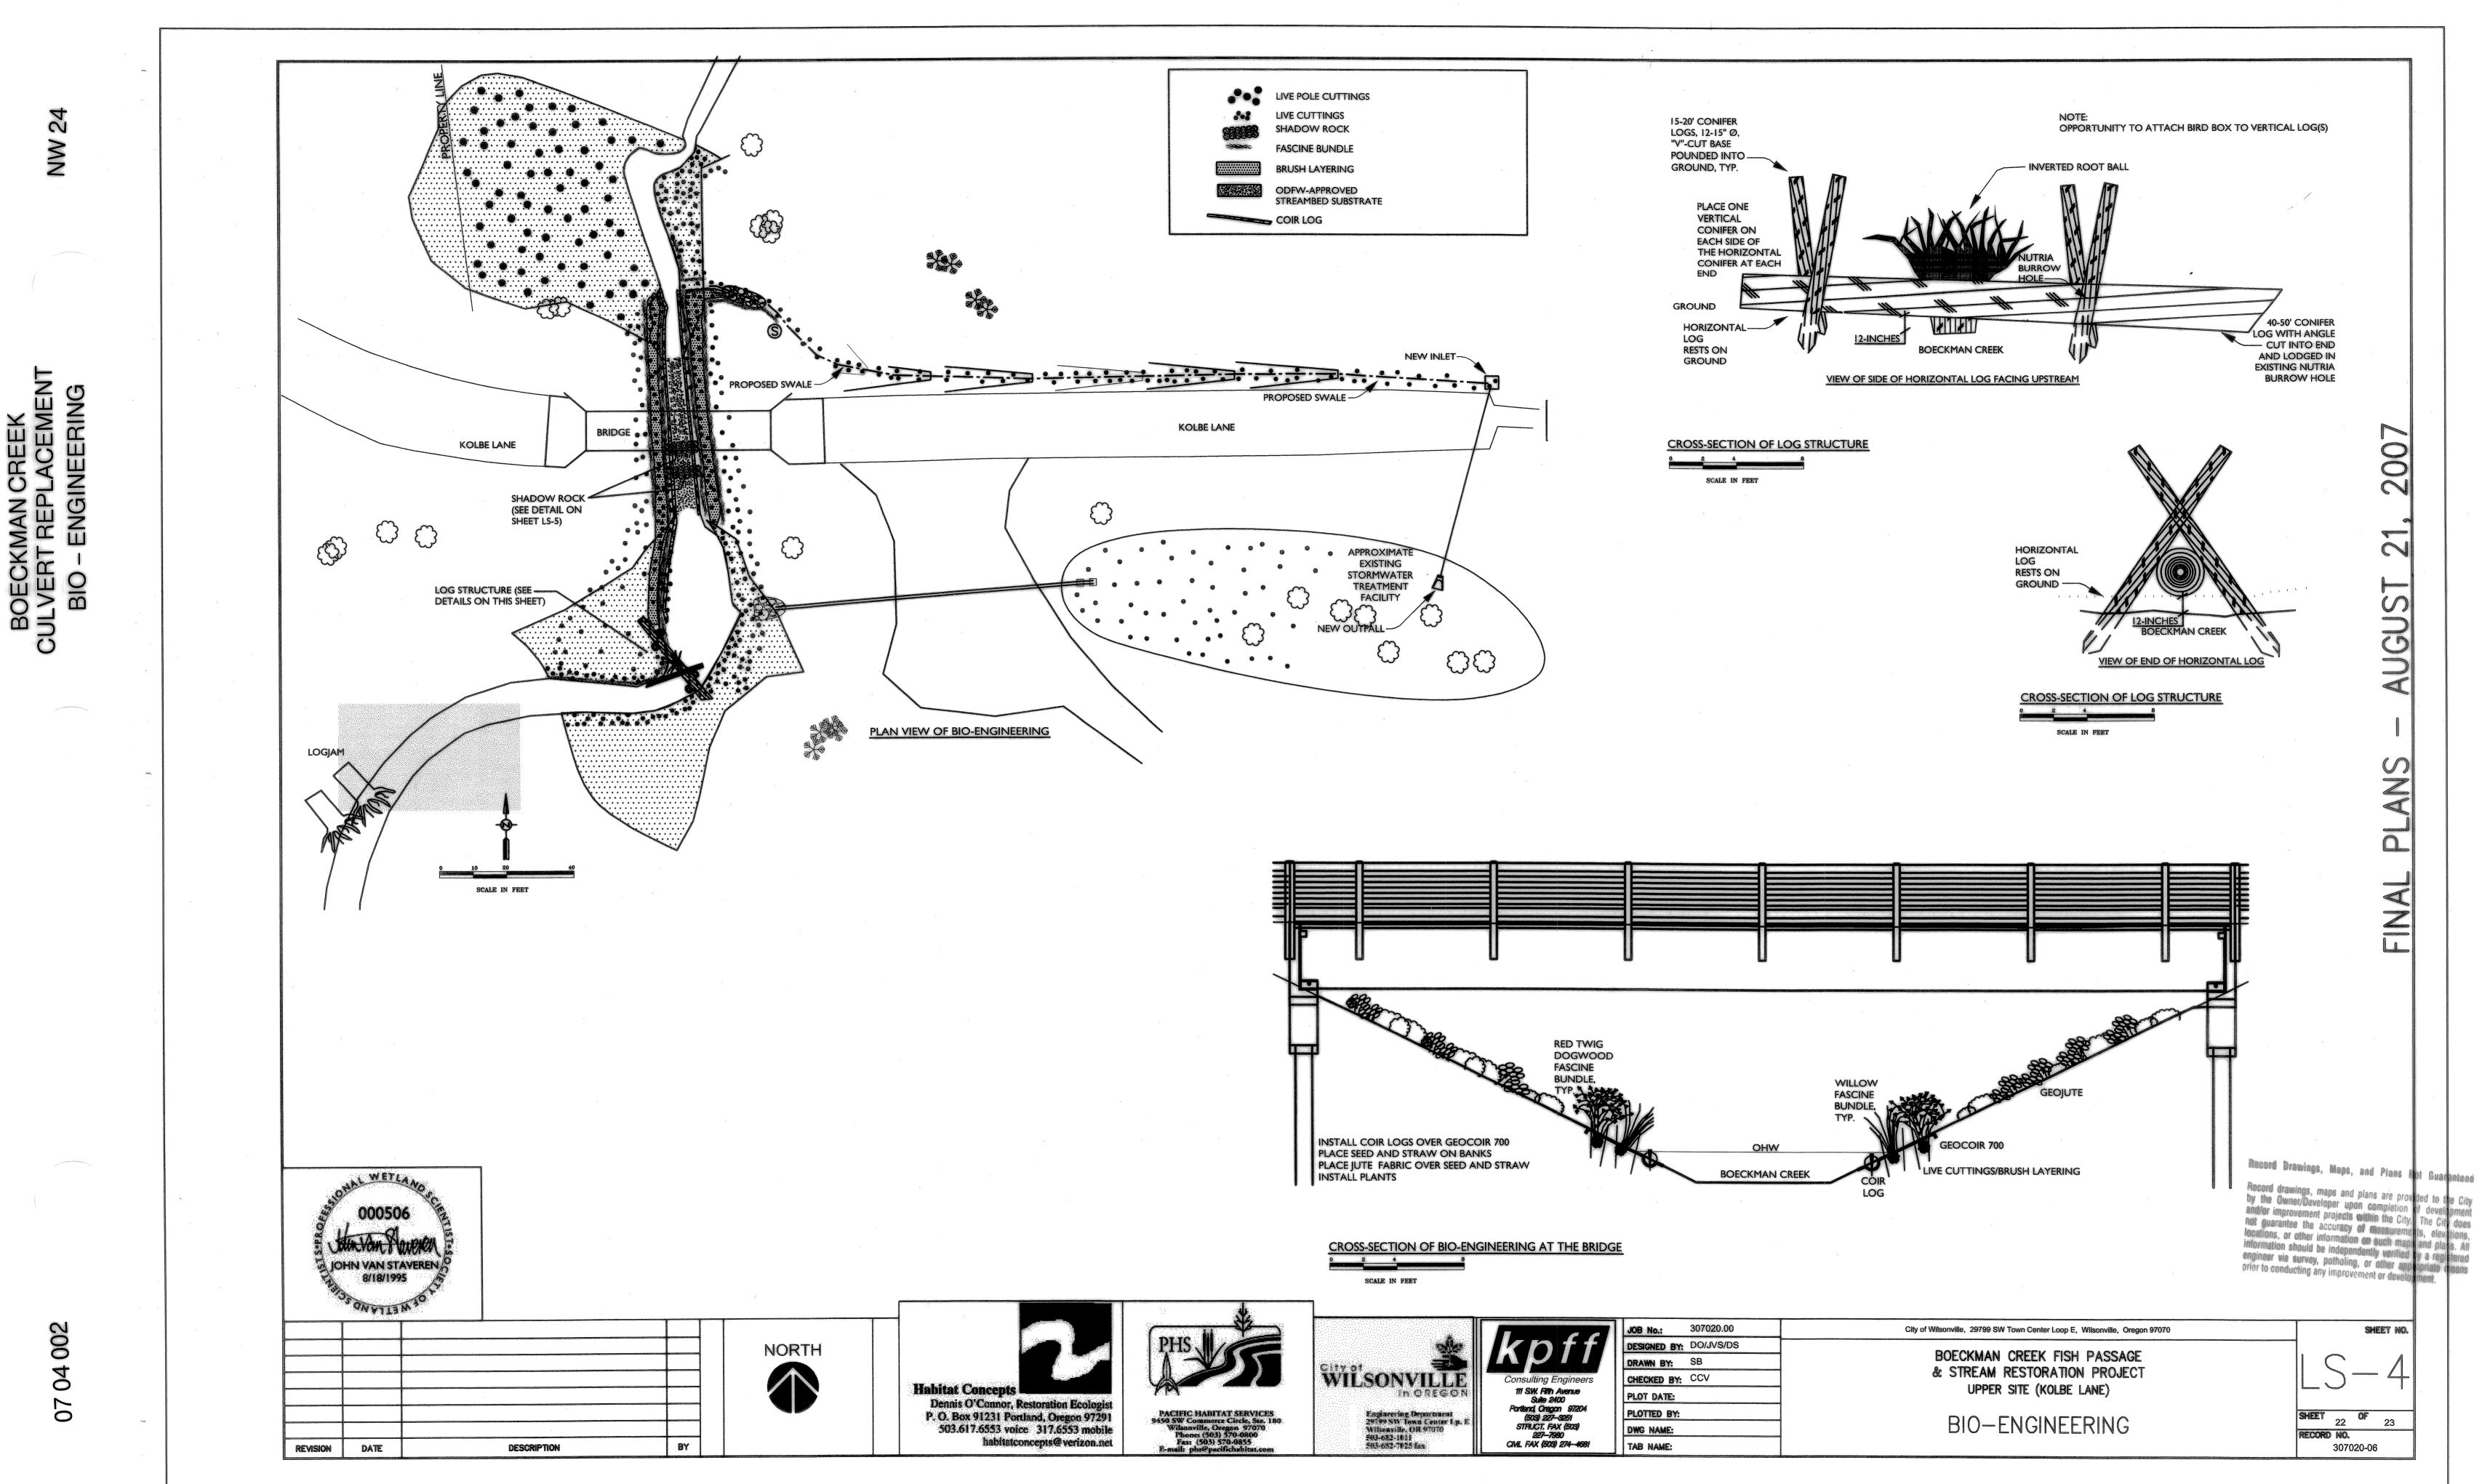

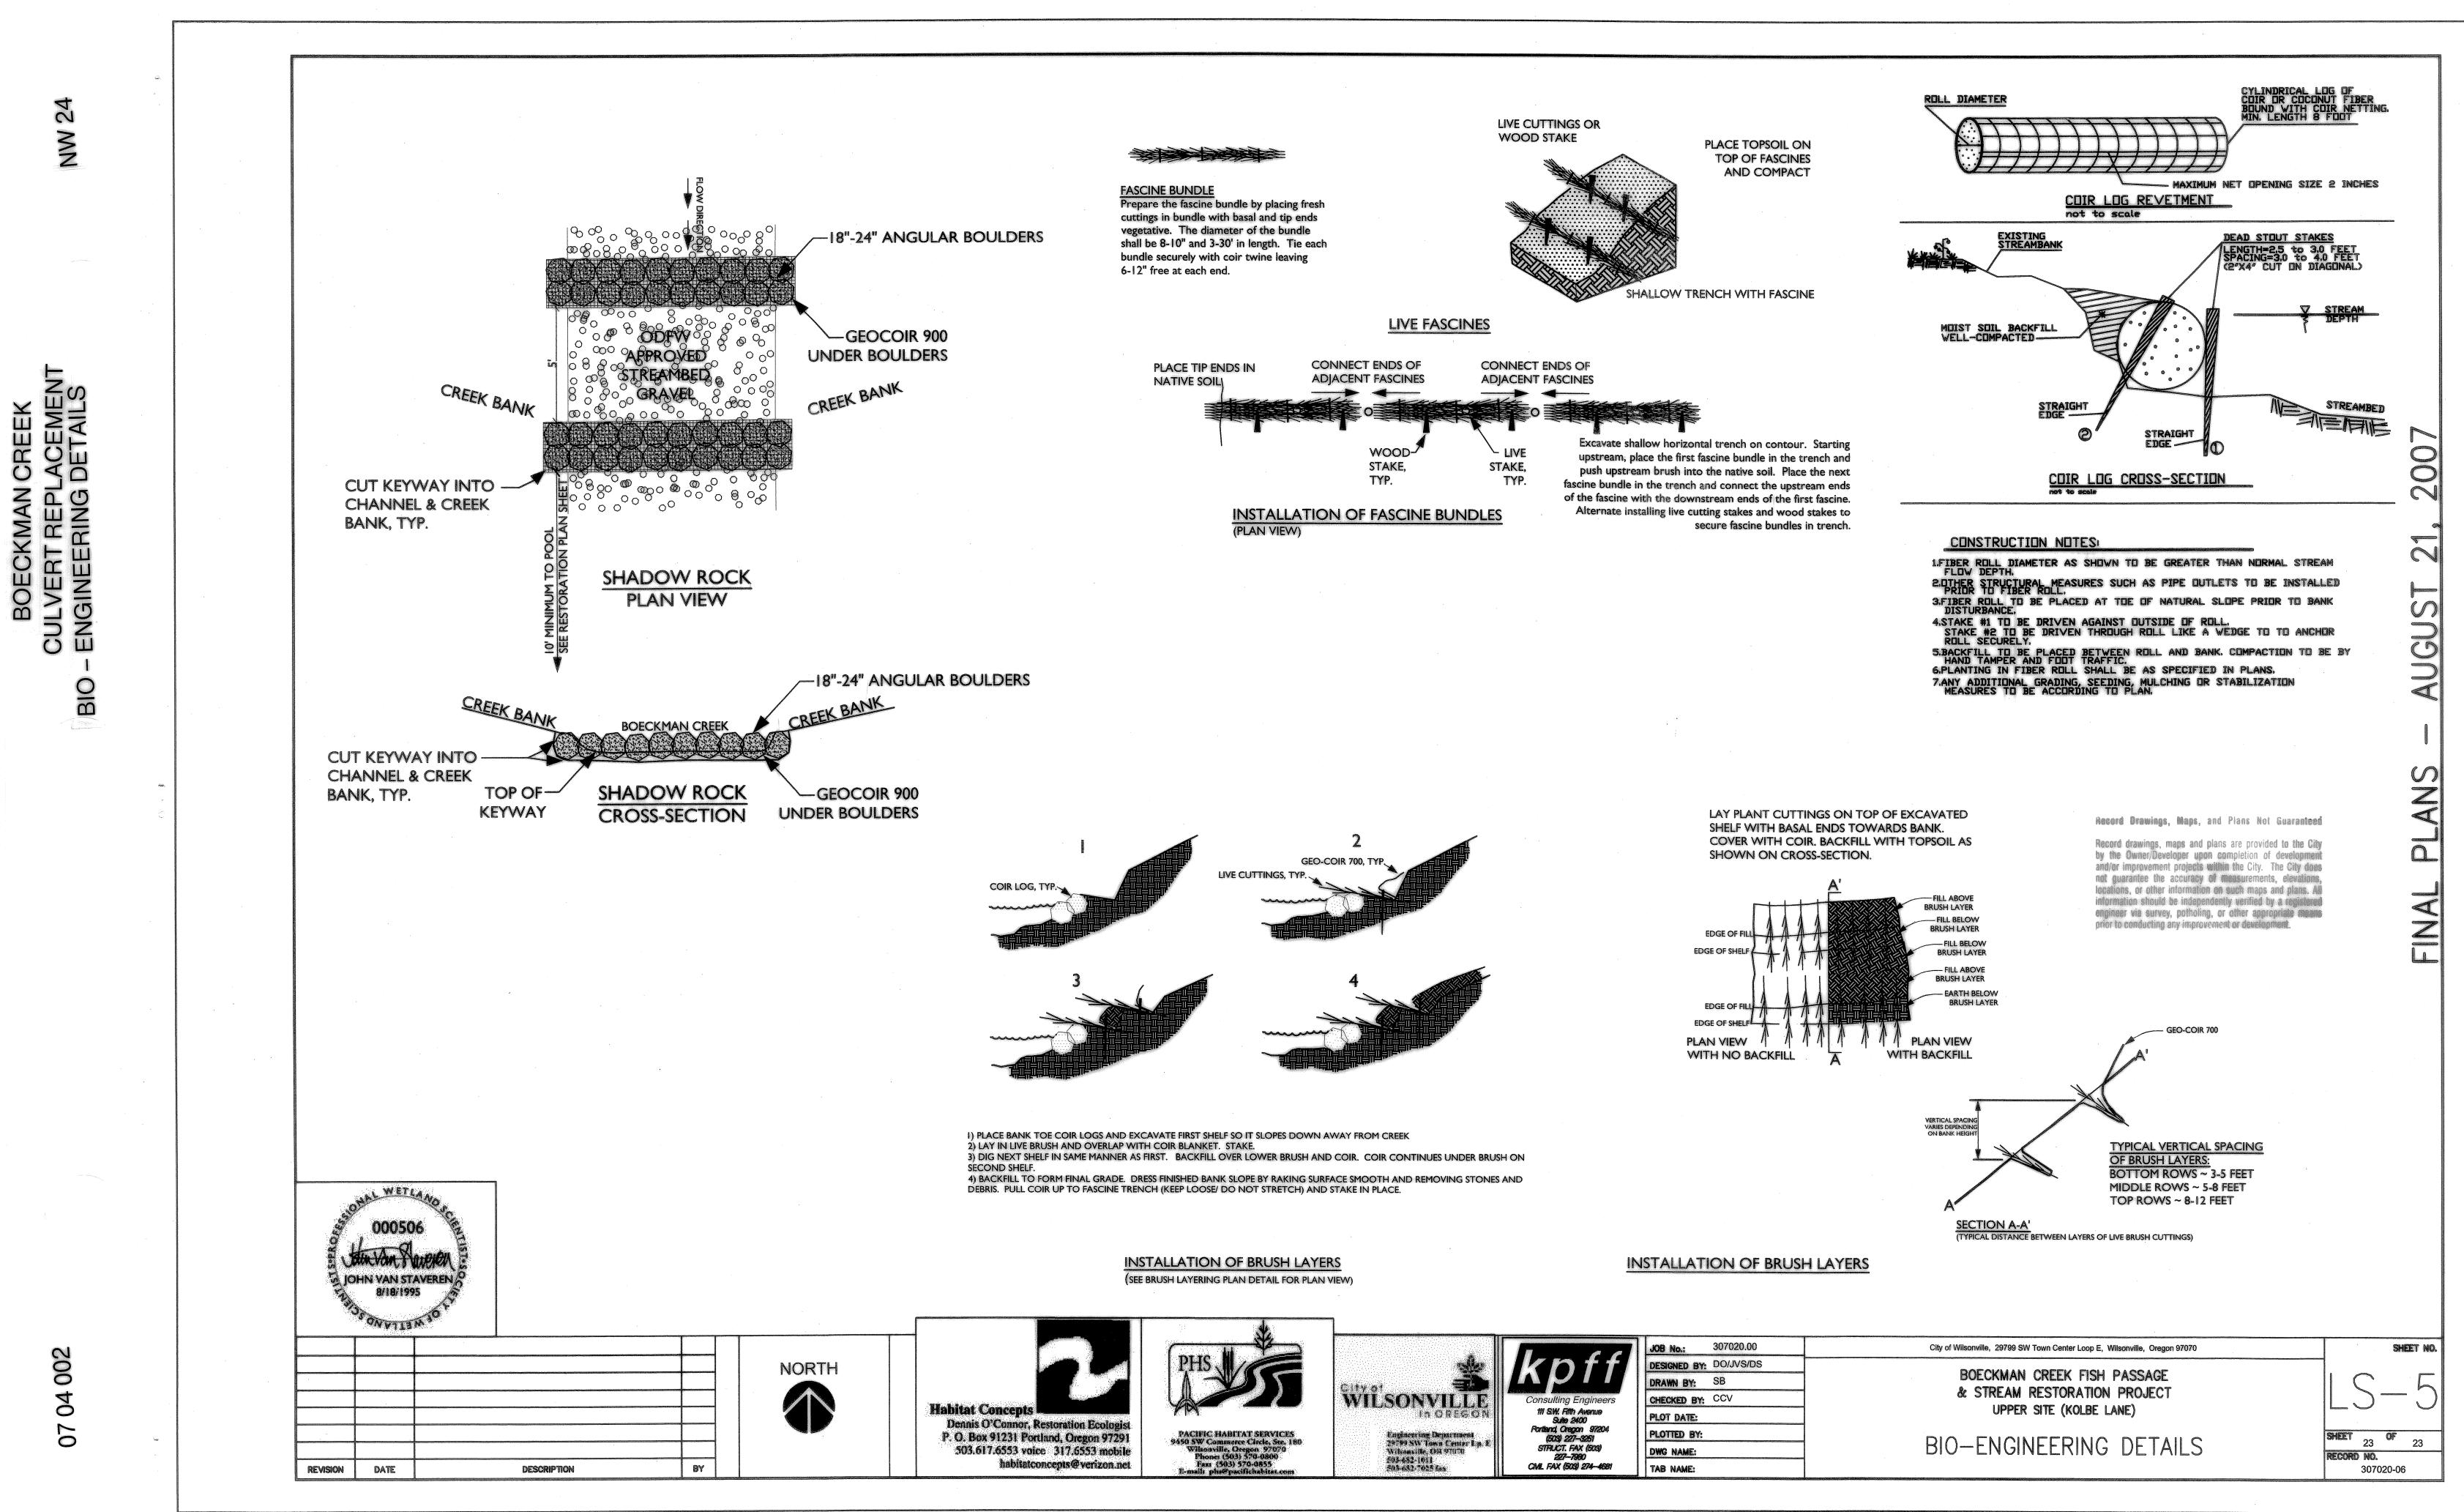

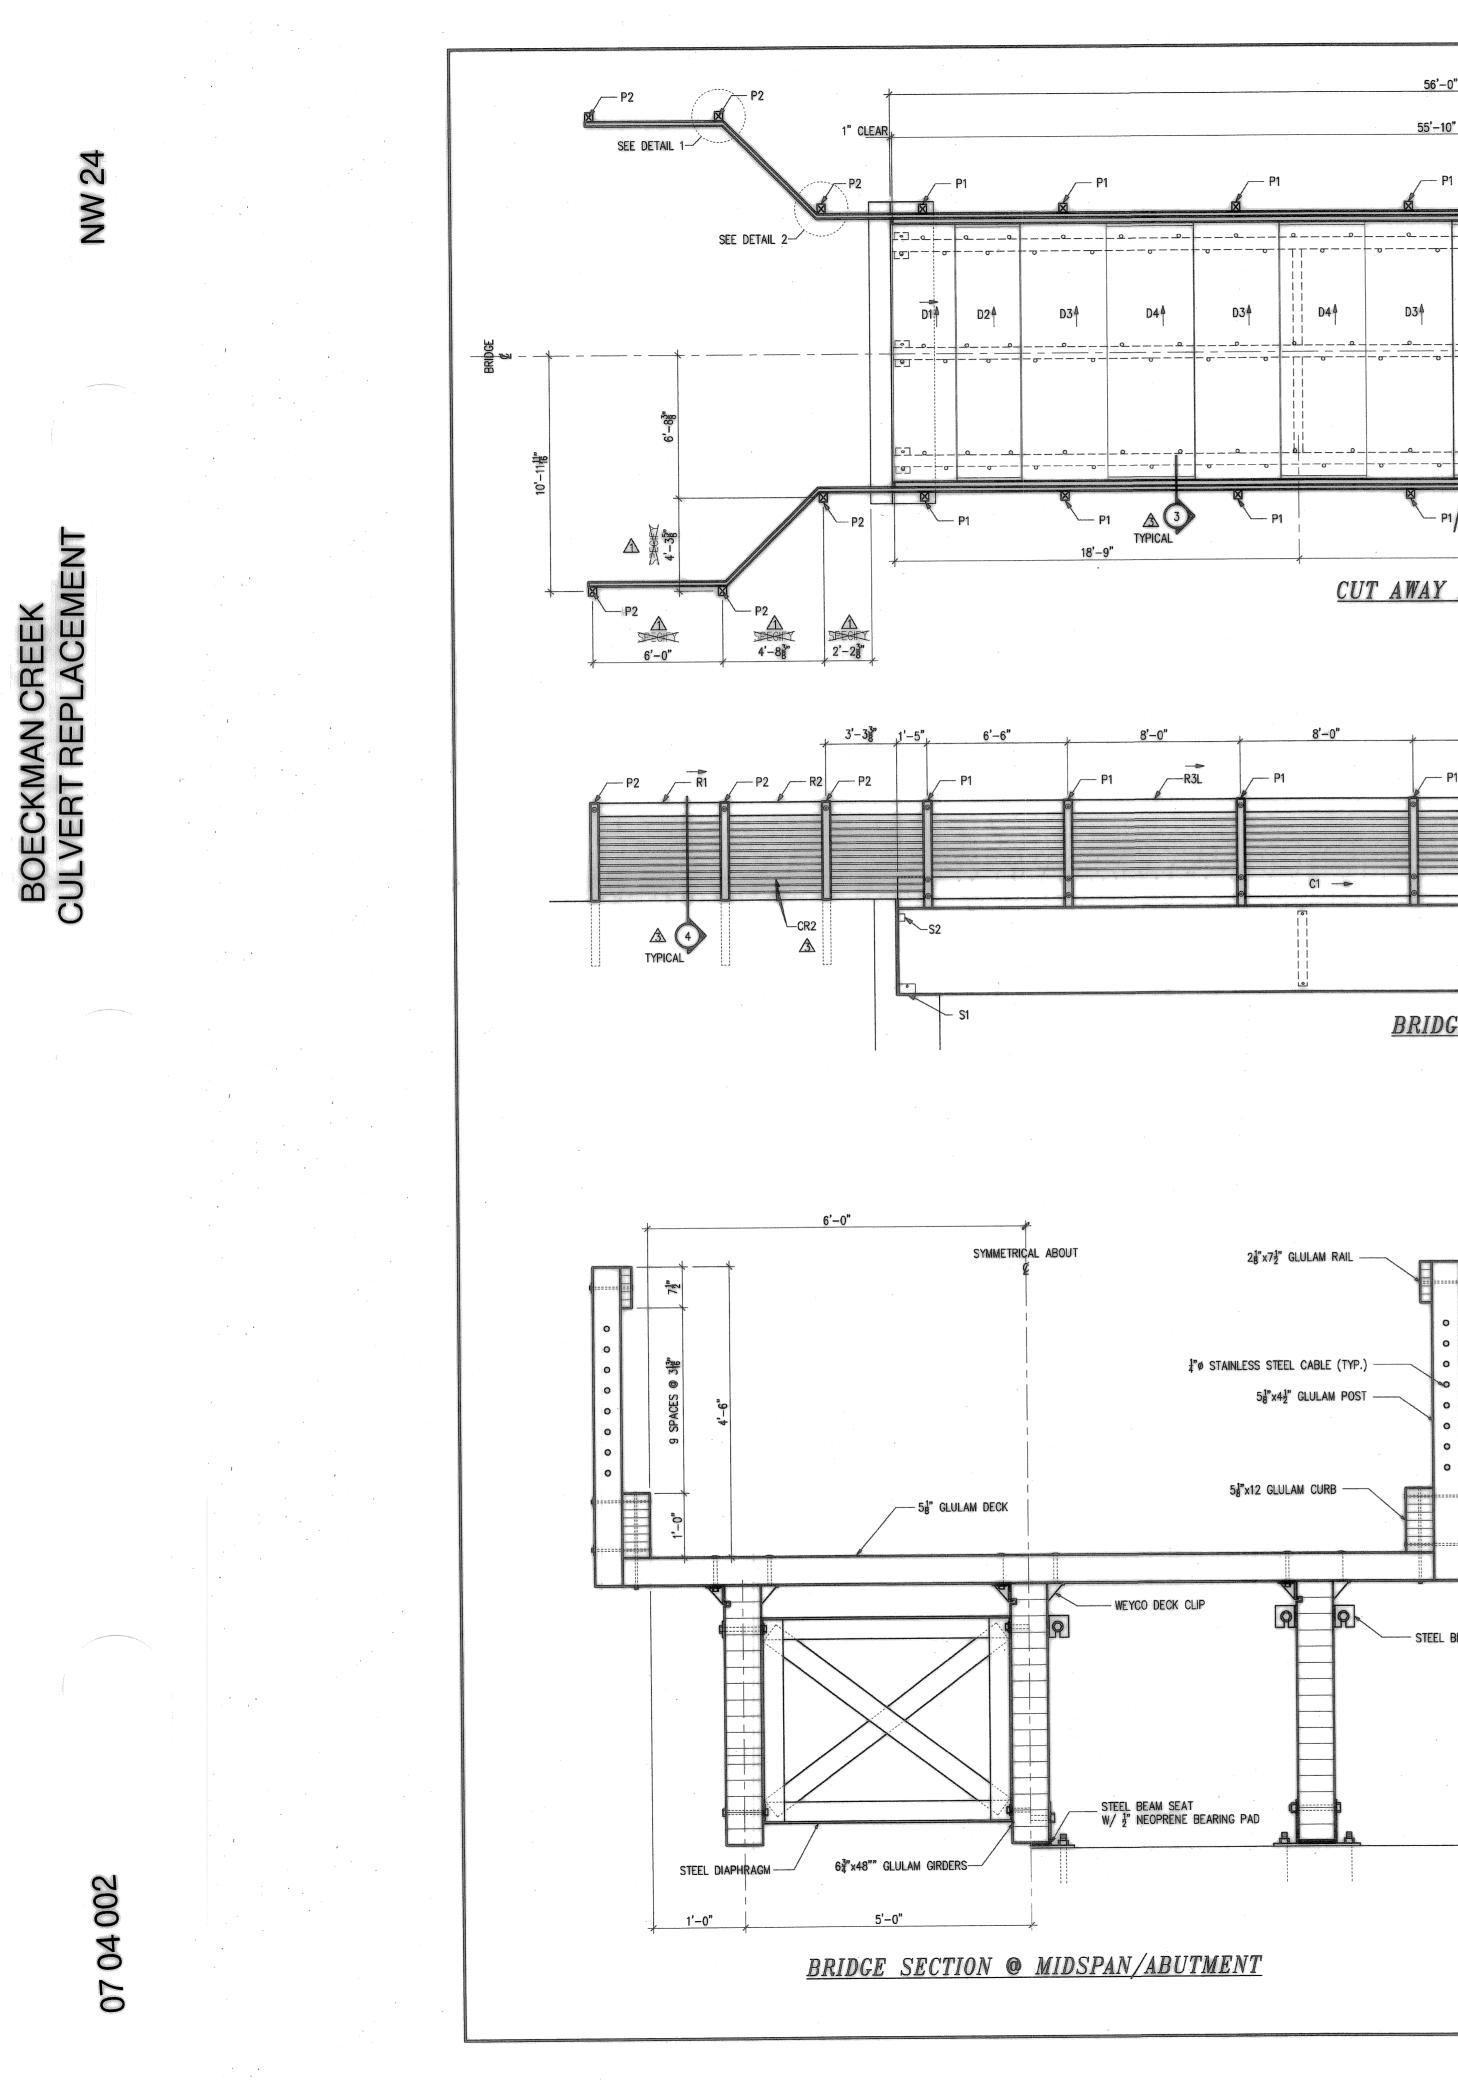

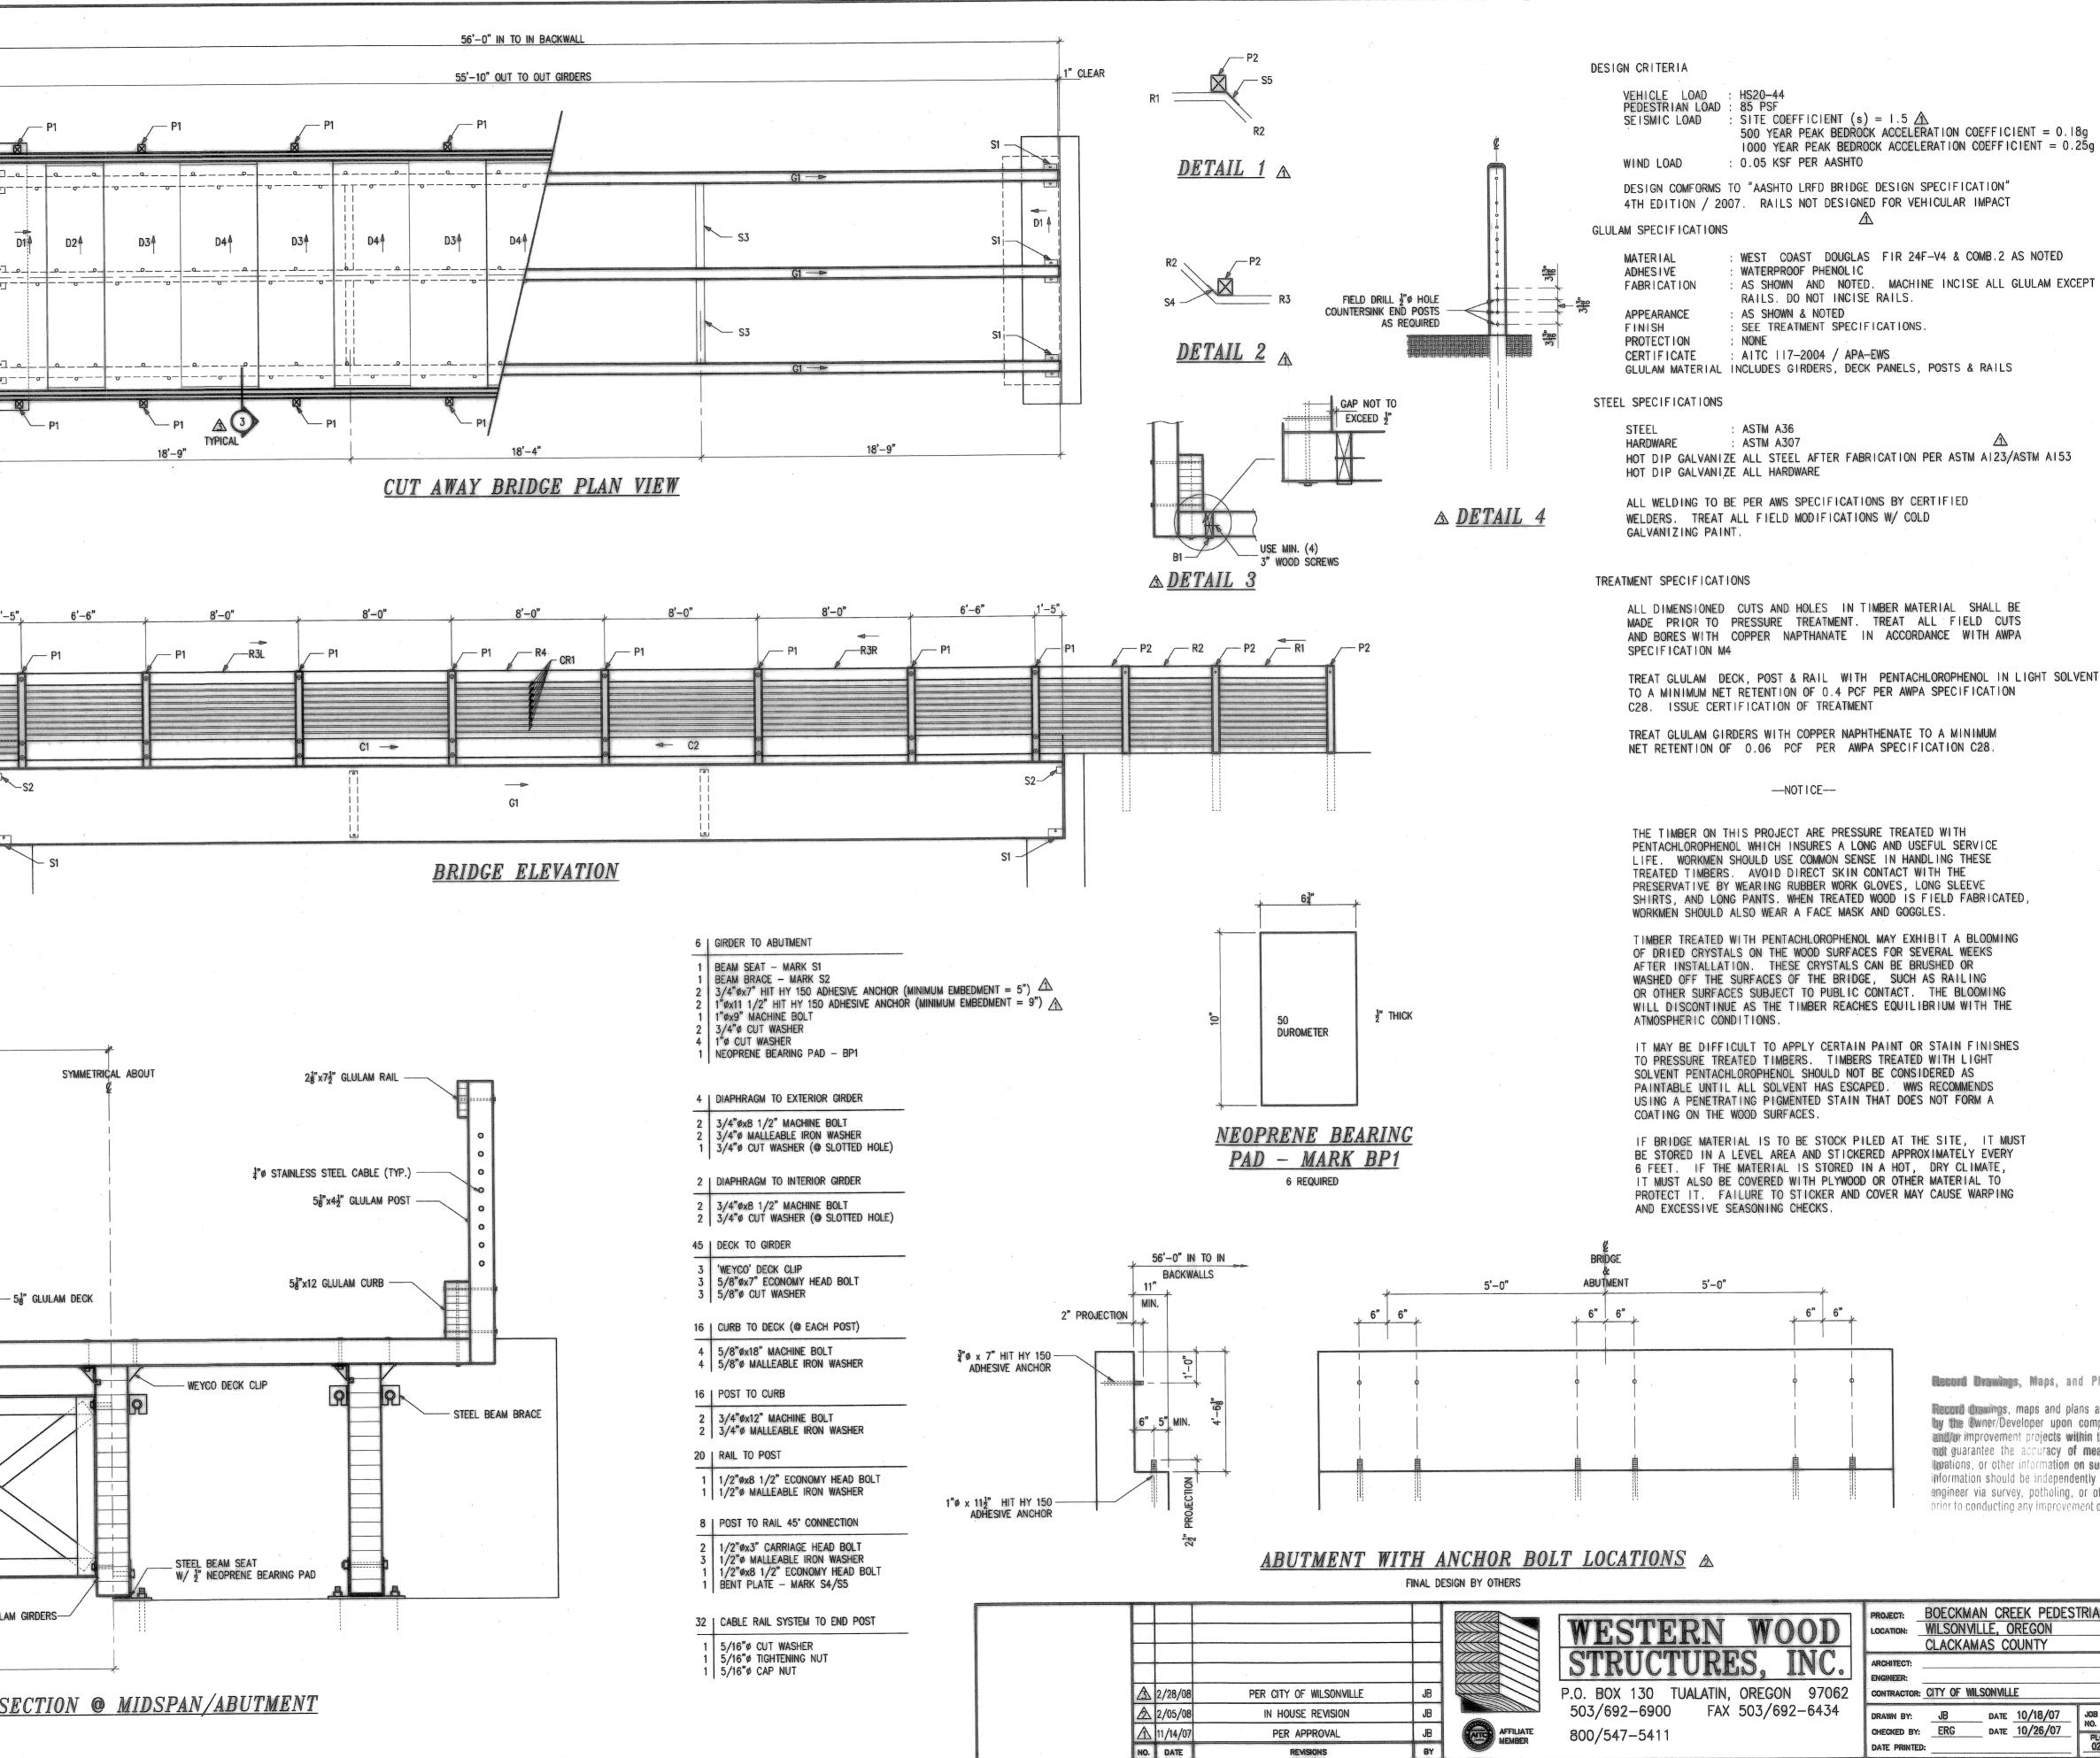

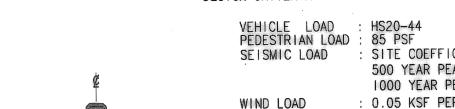

DESIGN COMFORMS TO "AASHTO LRFD BRIDGE DESIGN SPECIFICATION" 4TH EDITION / 2007. RAILS NOT DESIGNED FOR VEHICULAR IMPACT

HOT DIP GALVANIZE ALL STEEL AFTER FABRICATION PER ASTM A123/ASTM A153

AND BORES WITH COPPER NAPTHANATE IN ACCORDANCE WITH AWPA

TREAT GLULAM DECK, POST & RAIL WITH PENTACHLOROPHENOL IN LIGHT SOLVENT TO A MINIMUM NET RETENTION OF 0.4 PCF PER AWPA SPECIFICATION

TREAT GLULAM GIRDERS WITH COPPER NAPHTHENATE TO A MINIMUM NET RETENTION OF 0.06 PCF PER AWPA SPECIFICATION C28.

THE TIMBER ON THIS PROJECT ARE PRESSURE TREATED WITH PENTACHLOROPHENOL WHICH INSURES A LONG AND USEFUL SERVICE LIFE. WORKMEN SHOULD USE COMMON SENSE IN HANDLING THESE TREATED TIMBERS. AVOID DIRECT SKIN CONTACT WITH THE PRESERVATIVE BY WEARING RUBBER WORK GLOVES, LONG SLEEVE SHIRTS, AND LONG PANTS, WHEN TREATED WOOD IS FIELD FABRICATED, WORKMEN SHOULD ALSO WEAR A FACE MASK AND GOGGLES.

TIMBER TREATED WITH PENTACHLOROPHENOL MAY EXHIBIT A BLOOMING OF DRIED CRYSTALS ON THE WOOD SURFACES FOR SEVERAL WEEKS AFTER INSTALLATION. THESE CRYSTALS CAN BE BRUSHED OR WASHED OFF THE SURFACES OF THE BRIDGE, SUCH AS RAILING OR OTHER SURFACES SUBJECT TO PUBLIC CONTACT. THE BLOOMING WILL DISCONTINUE AS THE TIMBER REACHES EQUILIBRIUM WITH THE


IT MAY BE DIFFICULT TO APPLY CERTAIN PAINT OR STAIN FINISHES TO PRESSURE TREATED TIMBERS. TIMBERS TREATED WITH LIGHT SOLVENT PENTACHLOROPHENOL SHOULD NOT BE CONSIDERED AS PAINTABLE UNTIL ALL SOLVENT HAS ESCAPED. WWS RECOMMENDS USING A PENETRATING PIGMENTED STAIN THAT DOES NOT FORM A


IF BRIDGE MATERIAL IS TO BE STOCK PILED AT THE SITE, IT MUST BE STORED IN A LEVEL AREA AND STICKERED APPROXIMATELY EVERY 6 FEET. IF THE MATERIAL IS STORED IN A HOT, DRY CLIMATE, IT MUST ALSO BE COVERED WITH PLYWOOD OR OTHER MATERIAL TO PROTECT IT. FAILURE TO STICKER AND COVER MAY CAUSE WARPING


Record Drawings, Maps, and Plans Not Guaranteed

Record drawings, maps and plans are provided to the City by the Owner/Developer upon completion of development and/or improvement projects within the City. The City does mot guarantee the accuracy of measurements, elevations, Imations, or other information on such maps and plans. All information should be independently verified by a registered engineer via survey, potholing, or other appropriate means orior to conducting any improvement or development.

			WESTERN STRUCTURE	N_{2} IIV.	ARCHITECT: ENGINEER:	BOECKMAN CREEK PEDES WILSONVILLE, OREGON CLACKAMAS COUNTY	TRIAN BRIDGE
WILSONVILLE	JB		P.O. BOX 130 TUALATIN,		CONTRACTOR:	CITY OF WILSONVILLE	
REVISION	JB		503/692-6900 FAX	503/692-6434	DRAWN BY:	JB DATE 10/18/07	JOB 074052
PROVAL	JB	AFFILIATE MEMBER	800/547-5411		CHECKED BY:	ERG DATE 10/26/07	PLOT DATE SHT. 02/28/08 1 OF 3
NONS	BY		•		DATE PRINTEI):	02/28/0810F

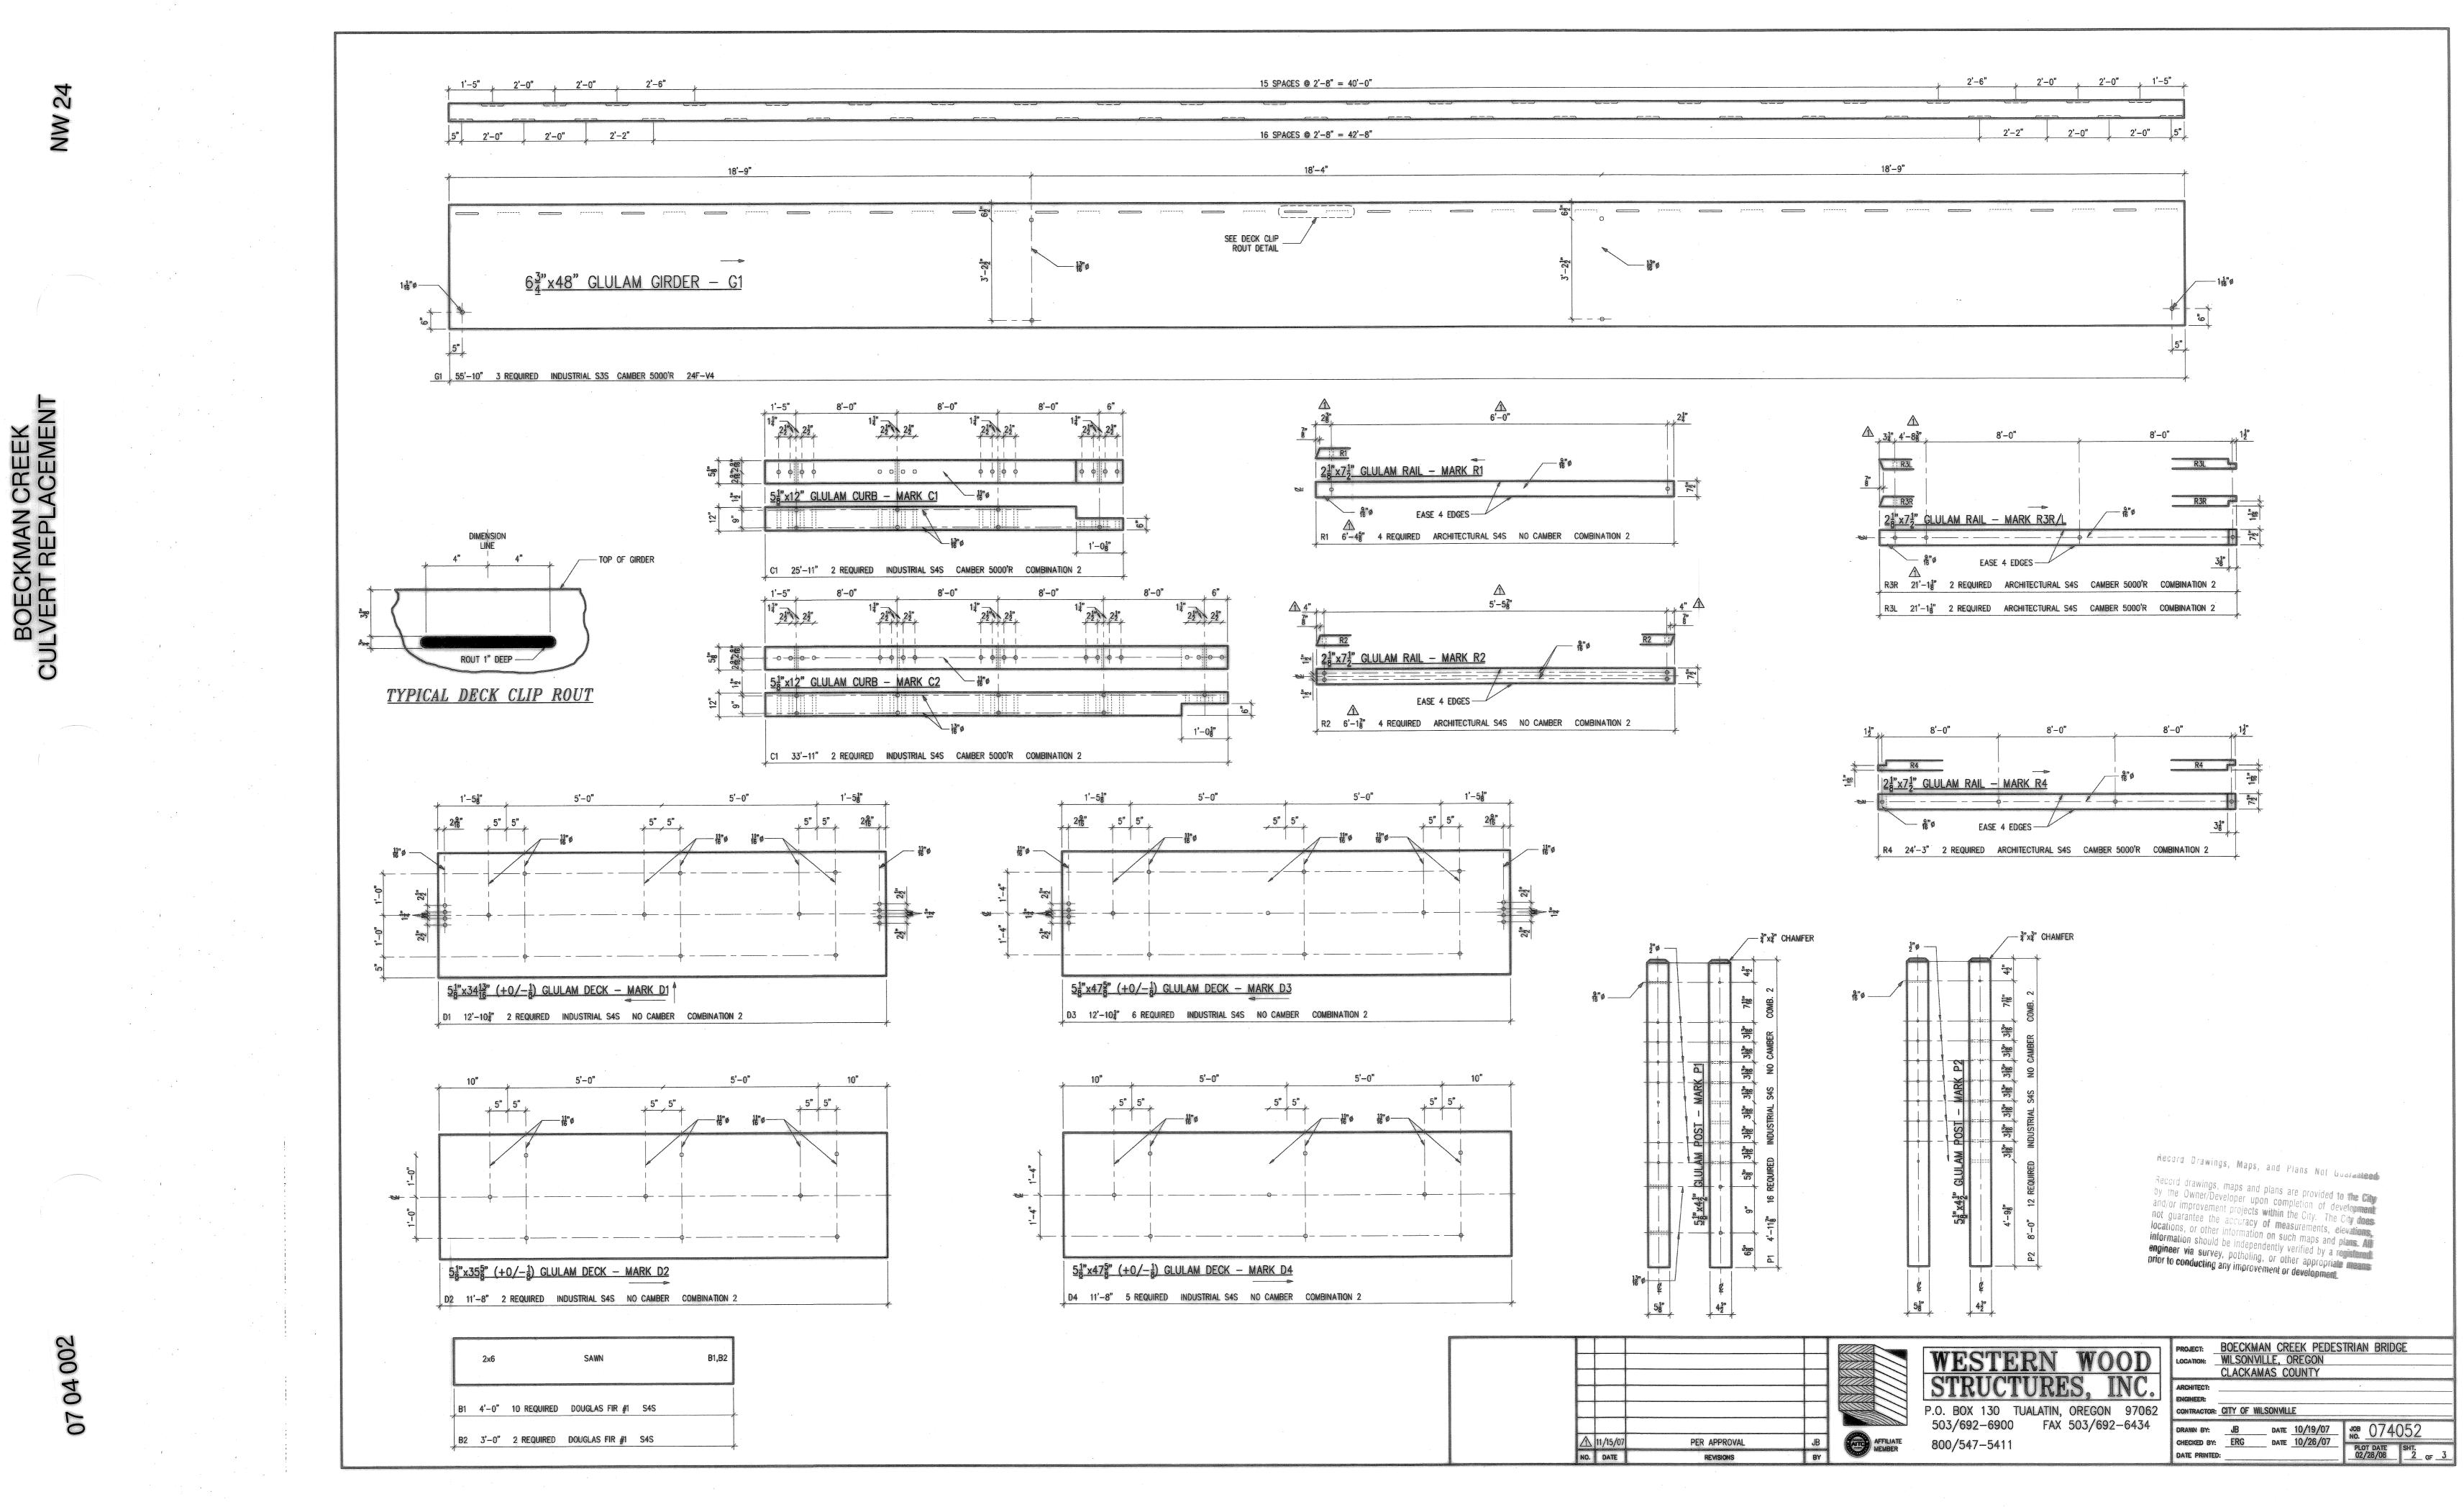

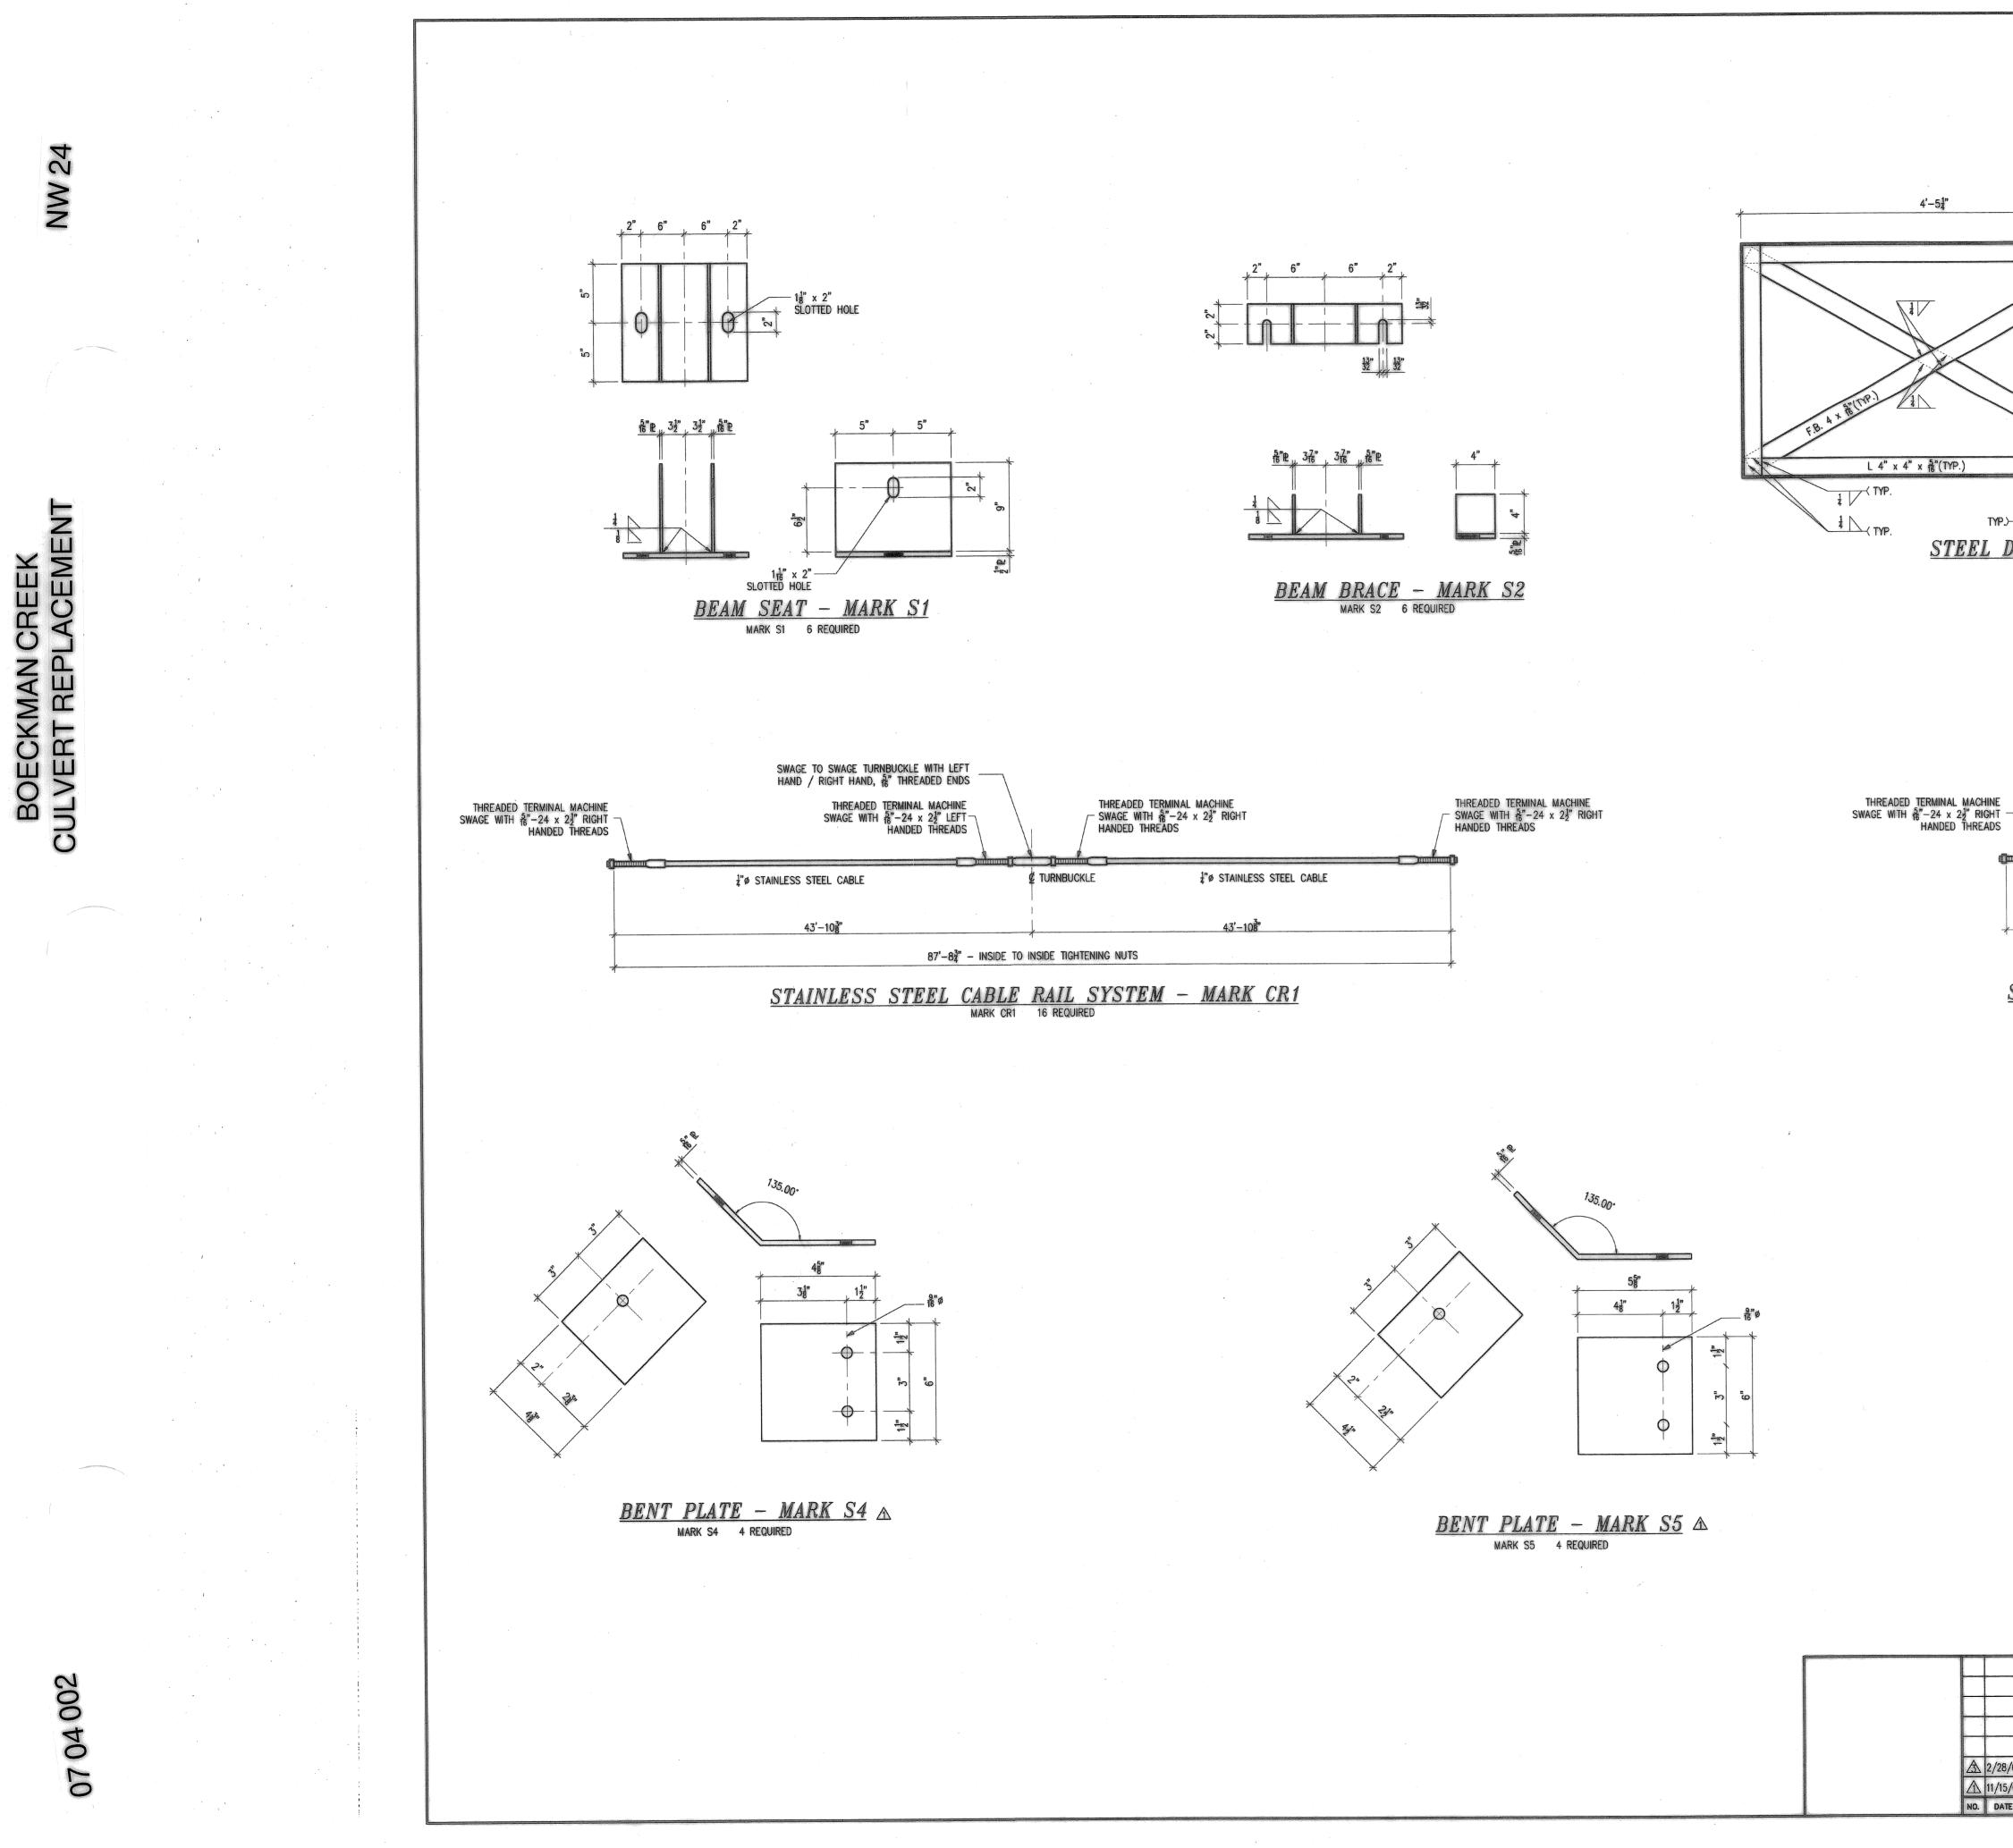


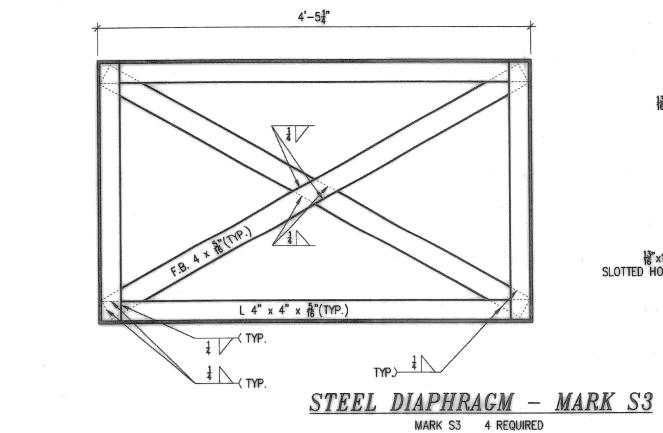




STAINLESS STEEL CABLE RAIL SYSTEM - MARK CR2 MARK CR2 12 REQUIRED &

NO.	DATE	REVISIONS
	11/15/07	PER APPRO
	2/28/08	PER CITY OF WIL

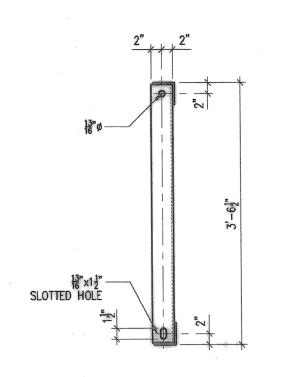



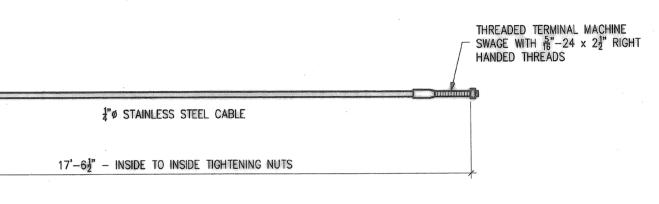

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·			WESTERN WOOD PROJECT: BOECKMAN CREEK PEDESTRIAN BRIDGE WILSONVILLE, OREGON CLACKAMAS COUNTY	
			P.O. BOX 130 TUALATIN, OREGON 97062	
ILSONVILLE	JB		503/692-6900 FAX 503/692-6434 DRAWN BY: JB DATE 10/23/07 JOB 074052	
OVAL	JB	AFFILIATE MEMBER	800/547-5411 CHECKED BY: ERG DATE 10/26/07 PLOT DATE SHT.	2
S	BY		DATE PRINTED:	9