
CIS EXTERIOR MATERIAL BOARD





RECKLI CONCRETE **FORMLINER** 2/74 URAL

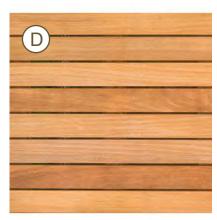

VERTICAL GRAIN CEDAR SOFFIT AT CANOPY & OVERHANG



EQUITONE:


"CHALK"







SHERWIN- WILLIAMS: **GAUNTLET GRAY**

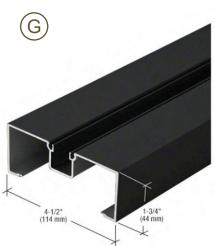



BLACK ANODIZED MULLION








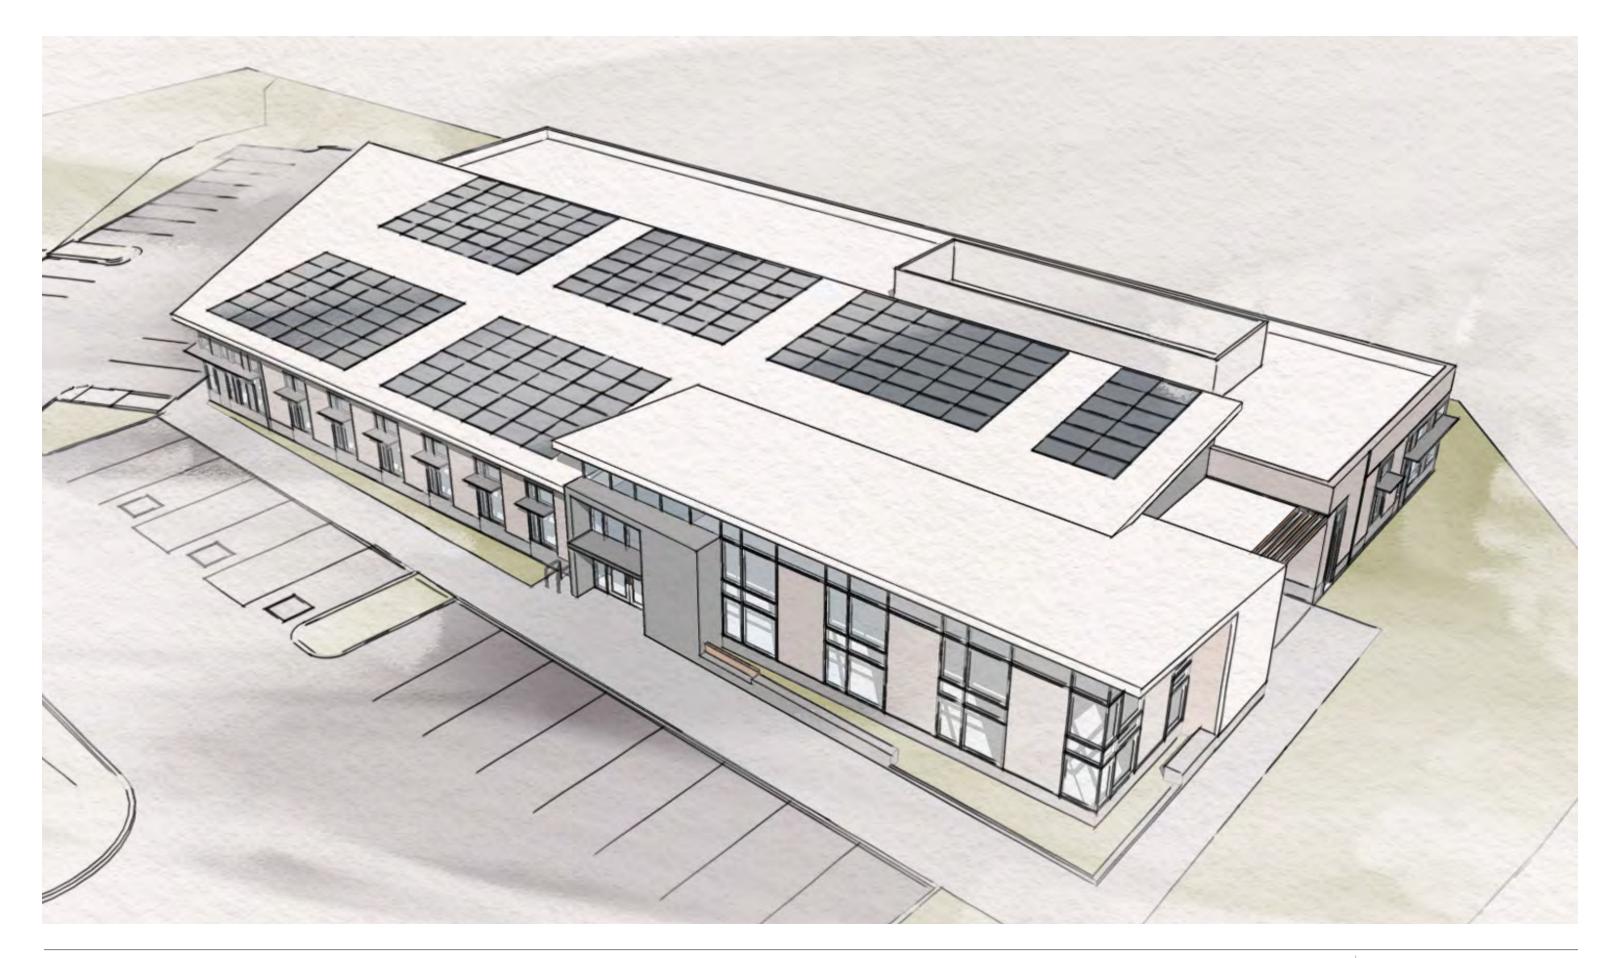

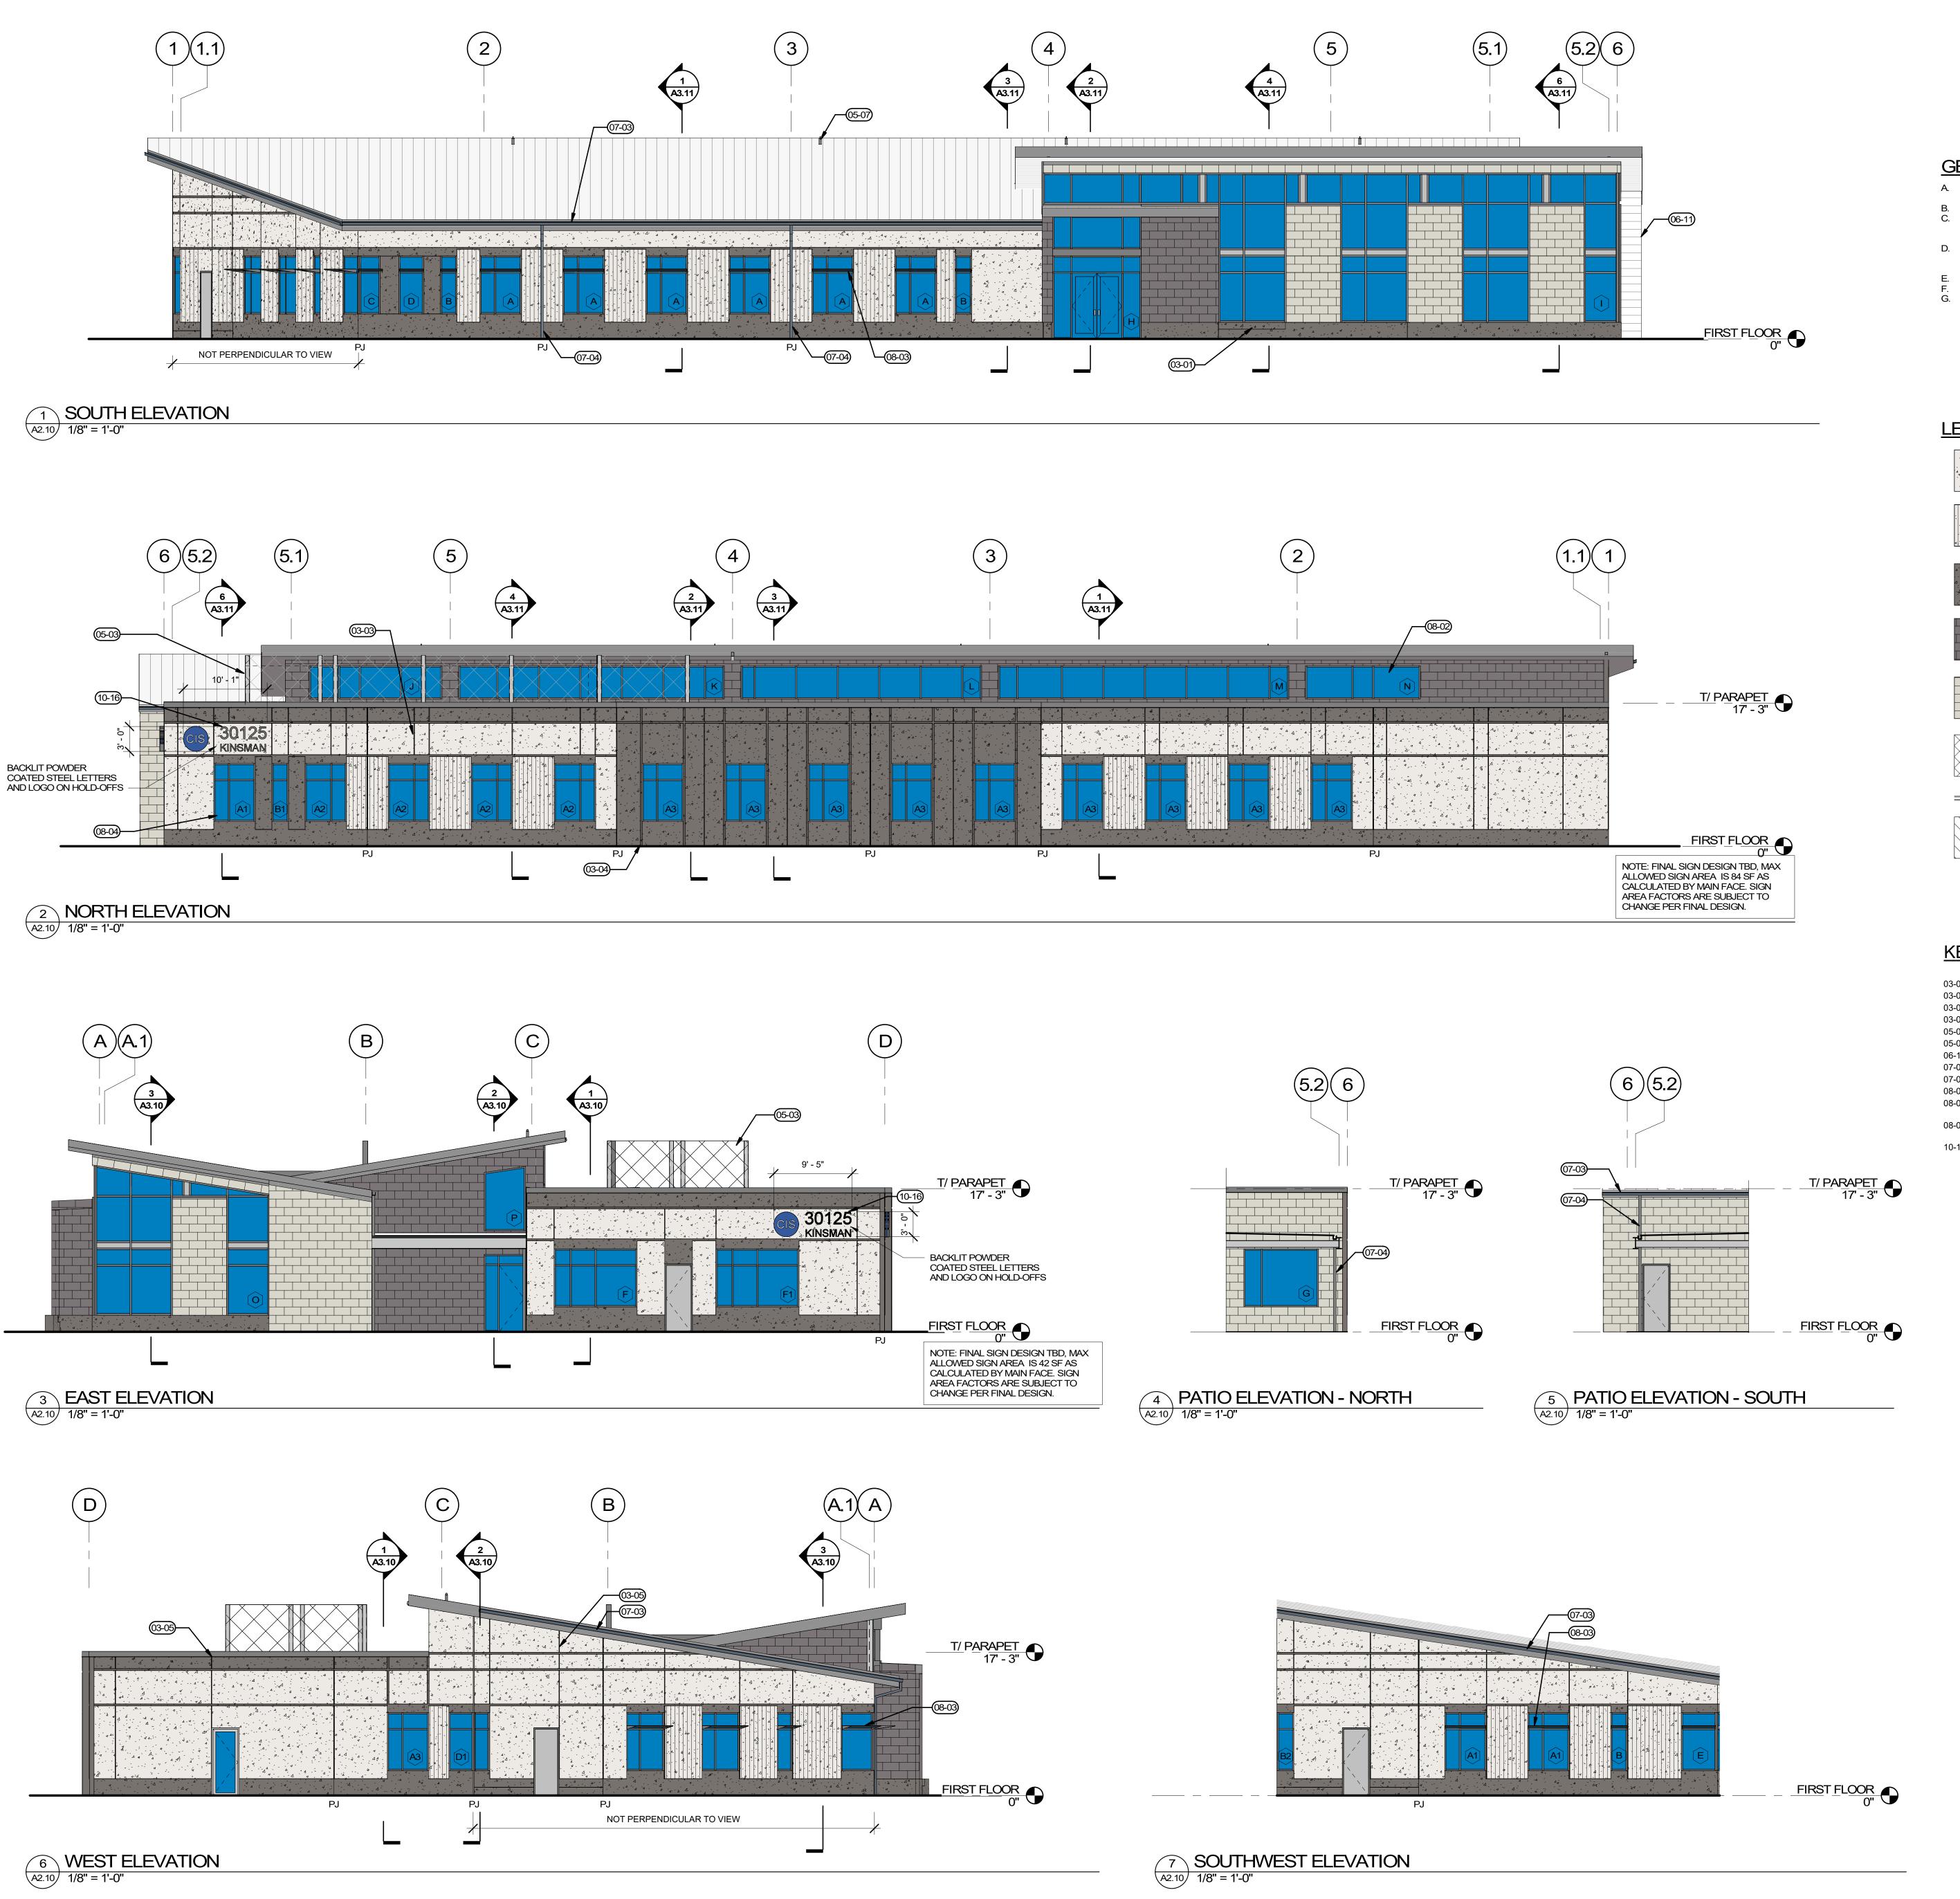

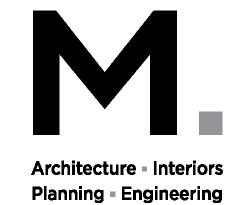

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GENERAL NOTES

- MAINTAIN 1/4" PER FOOT MINIMUM SLOPE THROUGHOUT ROOF. ADD CRICKETS AS REQUIRED TO PROVIDE POSITIVE SLOPE TO DRAIN AT MINIMUM 1/4" PER FOOT AT ENTIRE ROOF, TYPICAL.
 - ALL ROOF ELEVATIONS TO BOTTOM OF DECK. WALKWAY PADS ARE SHOWN SCHEMATICALLY. WALKWAY PADS SHOULD BE PROVIDED AT AREAS SHOWN AND TO INCLUDE ALL EQUIPMENT INSTALLATIONS, DOORWAYS, STAIR/LADDER LANDINGS, AND OTHER AREAS REQUIRING REGULAR MAINTENANCE.
- CONTRACTOR TO PROVIDE COVERS, ENCLOSURES, AND/OR SEALANTS AT ALL ROOF PENETRATIONS, PIPES, CURBS, DUCTS, AND CONNECTIONS. COORDINATE AND REFER TO
- MECHANICAL/ELECTRICAL DISCIPLINES FOR ADDITIONAL INFORMATION. SEE DETAIL 13/A5.14 FOR ELECTRICAL CONDUIT PENETRATIONS
- SEE DETAILS 11-12/A5.14 FOR PIPE PENETRATIONS SEE DETAILS 5/10A5.14 FOR MECHANICAL UNIT CURBS

<u>LEGEND</u>

CONCRETE TILT PANELS - SHERWIN WILLIAMS "SNOWBOUND"

PAINT SHERWIN WILLIAMS "SNOWBOUND"

CONCRETE TILT PANELS - FORMLINER PATTERN PER SPEC -

CONCRETE TILT PANELS - SHERWIN WILLIAMS "GAUNTLET GREY"

FIBER CEMENT PANEL - FC-1: "ARGENT GREY"

FIBER CEMENT PANEL - FC-2: "CHALK"

PAINTED CONCRETE REVEALS

METAL SCREEN, REFER TO DETAIL

METAL INFILL PANEL PER SPECS

KEYNOTES

PJ

- CONCRETE SEAT WALL
- 03-03 VERTICAL REVEALS TO ALIGN WITH WINDOW MULLIONS BELOW, TYP. U.N.O. REVEAL "A" AT JAMBS OF OPENINGS AT BUMP-OUT, TYP.

PANEL JOINT - REFER TO STRUCUTRAL


- REVEAL "B" VERTICAL ALONG ADJACENT DOOR JAMB METAL SCREEN WALL AT ROOFTOP UNITS. SEE EXTERIOR DETAILS.
- ROOF TIE-OFFS. SEE HIGH ROOF PLAN FOR LOCATIONS CEDAR SOFFIT FINISH CONTINUES DOWN FACE OF WALL
- 07-03 METAL GUTTER 07-04 METAL DOWNSPOUT - RECTANGULAR PROFILE, 4"X3"
- CLERESTORY GLAZING PER ELEVATIONS AND EXTERIOR GLAZING SCHEDULE. INTEGRAL STOREFRONT SHADE DEVICES. FINISH TO MATCH MULLION SYSTEM
- OF ASSOCIATED OPENING. PROVIDE ACOUSTIC GLAZING, FRAMES AND SEALS AT NORTH STOREFRONT
- BUILDING ADDRESS SIGN

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> REVISION SCHEDULE Issued As Issue Date

SHEET TITLE:

BUILDING **ELEVATIONS**

A2.10

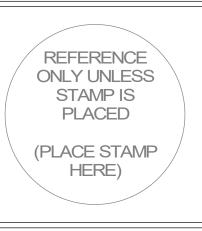

CIS COLLABORATION CENTER

REVISED LAND USE SUBMITTAL - MARCH 12TH, 2024



LEGAL DESCRIPTION: TAXLOT ID: 31W23B 00100

30125 SW KINSMAN ROAD, WILSONVILLE OR 97070 ADDRESS:

SITE SIZE: 2.02 ACRE SITE

JURISDICTION: CITY OF WILSONVILLE

ZONING: PLANNED DEVELOPMENT INDUSTRIAL (PDI)

DEFERRED SUBMITTALS

PER SECTION 107.3.4.2 DEFERRED SUBMITTALS:

DOCUMENTS FOR DEFERRED SUBMITTAL ITEMS SHALL BE SUBMITTED BY THE GENERAL CONTRACTOR TO THE REGISTERED DESIGN PROFESSIONAL IN CHARGE WHO SHALL REVIEW THEM AND RETURN THEM TO THE GENERAL CONTRACTOR WITH A NOTATION INDICATING THAT THE DEFERRED SUBMITTAL DOCUMENTS HAVE BEEN REVIEWED AND FOUND TO BE IN GENERAL CONFORMANCE TO THE DESIGN OF THE BUILDING. THE DEFERRED SUBMITTAL ITEMS SHALL NOT BE INSTALLED UNTIL THE DEFERRED SUBMITTAL DOCUMENTS HAVE BEEN APPROVED BY THE BUILDING OFFICIAL.

- FIRE SPRINKLER NFPA 13 SYSTEM - FIRE ALARM SYSTEM

- CARBON MONOXIDE DETECTION SYSTEM

- PROVIDE CALCULATIONS AND DETAILS FOR SEISMIC ANCHORAGE AND BRACING OF ALL MECHNICAL AND ELECTRICAL AND OTHER EQUPMENT WEIGHING MORE THAN 75 LBS AND ATTACHED MORE THAN 4'-0" ABOVE THE FLOOR OR ROOF LEVEL

- STOREFRONT AND CURTAINWALL SYSTEM DESIGN AND ATTACHMENT - FIXED LADDER DESIGN

- TRASH ENCLOSURE GATE AND CANOPY - REFER TO S0.00 FOR ADDITIONAL INFORMATION **CLIENT**

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PATRICK PRIEST

PPRIEST@CISOREGON.ORG

STEVE NORMAN

OWNER'S REPRESENTATIVE

CUMMING GROUP 6000 MEADOWS RD #410, LAKE OSWEGO, OR 97035

CONTACT: SAMRA EGGER

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CONTACT: JEFF HUMPHREYS,

STRUCTURAL

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> ALEXIUS TAN, PROJECT ENGINEER 206.457.4571

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LANDSCAPE

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MECHANICAL ENGINEER

AND MEP PROJECT MANAGER

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CONTACT: ALAN BURT

ACOUSTICIAN

206.683.6870 ALAN@SSAACOUSTICS.COM

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NORTHWEST GEOTECH INC.

WILSONVILLE, OR 97070

CONTACT: WAYNE OLSEN P.E.

9120 SW PIONEER COURT SUITE B

503.682.1880 INFO@NWGEOTECH.COM

VICINITY MAP NOT TO SCALE

DRAWING INDEX

TITLE SHEET AND DRAWING INDEX

EXISTING CONDITIONS AND DEMOLITION PLAN

SITE PLAN C1.20 GRADING PLAN UTILITY PLAN

L0.01 LANDSCAPE GENERAL INFORMATION L0.02 LANDSCAPE CODE PLAN

L0.03 TREE PLAN L1.10 PLANTING PLAN - NORTH L1.11 PLANTING PLAN - SOUTH

L3.10 ENLARGEMENTS

L5.10 DETAILS

ARCHITECTURAL A1.10 FLOOR PLAN

A5.17 SITE DETAILS

A2.10 BUILDING ELEVATIONS

ELECTRICAL

E1.10 SITE PLAN - ELECTRICAL

SITE MAP NOT TO SCALE

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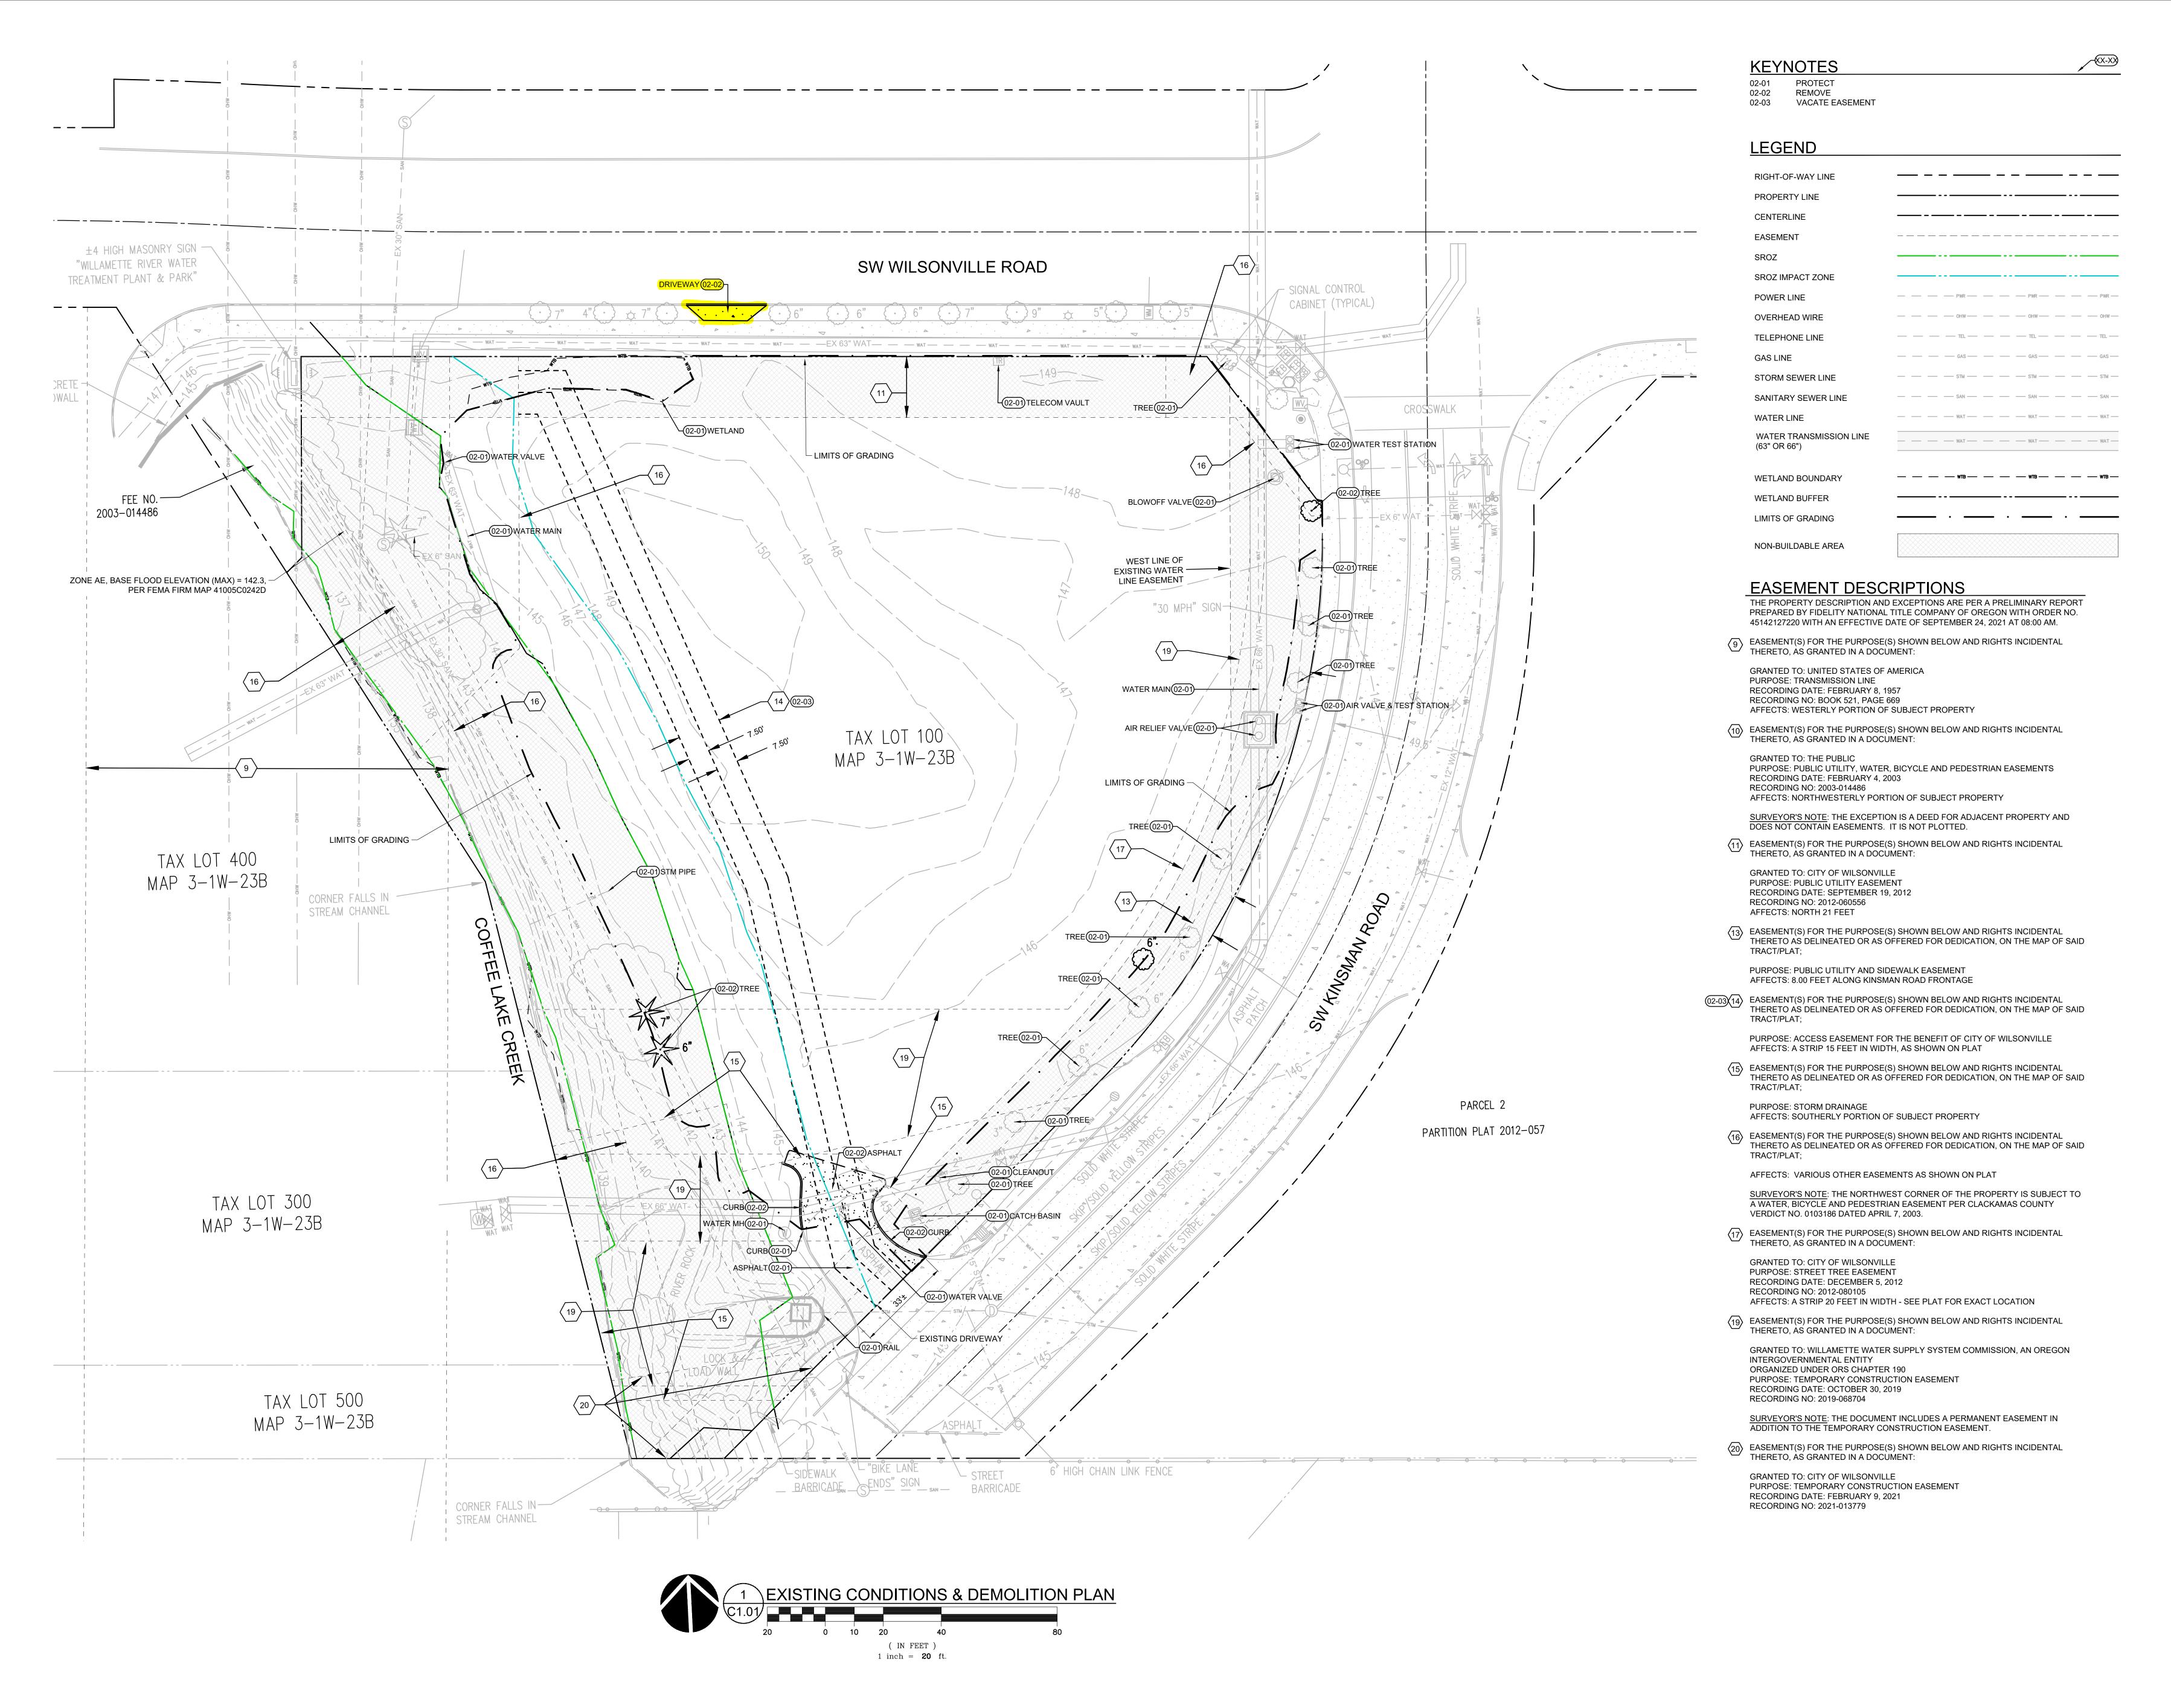
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SHEET TITLE:

TITLE SHEET

G0.01



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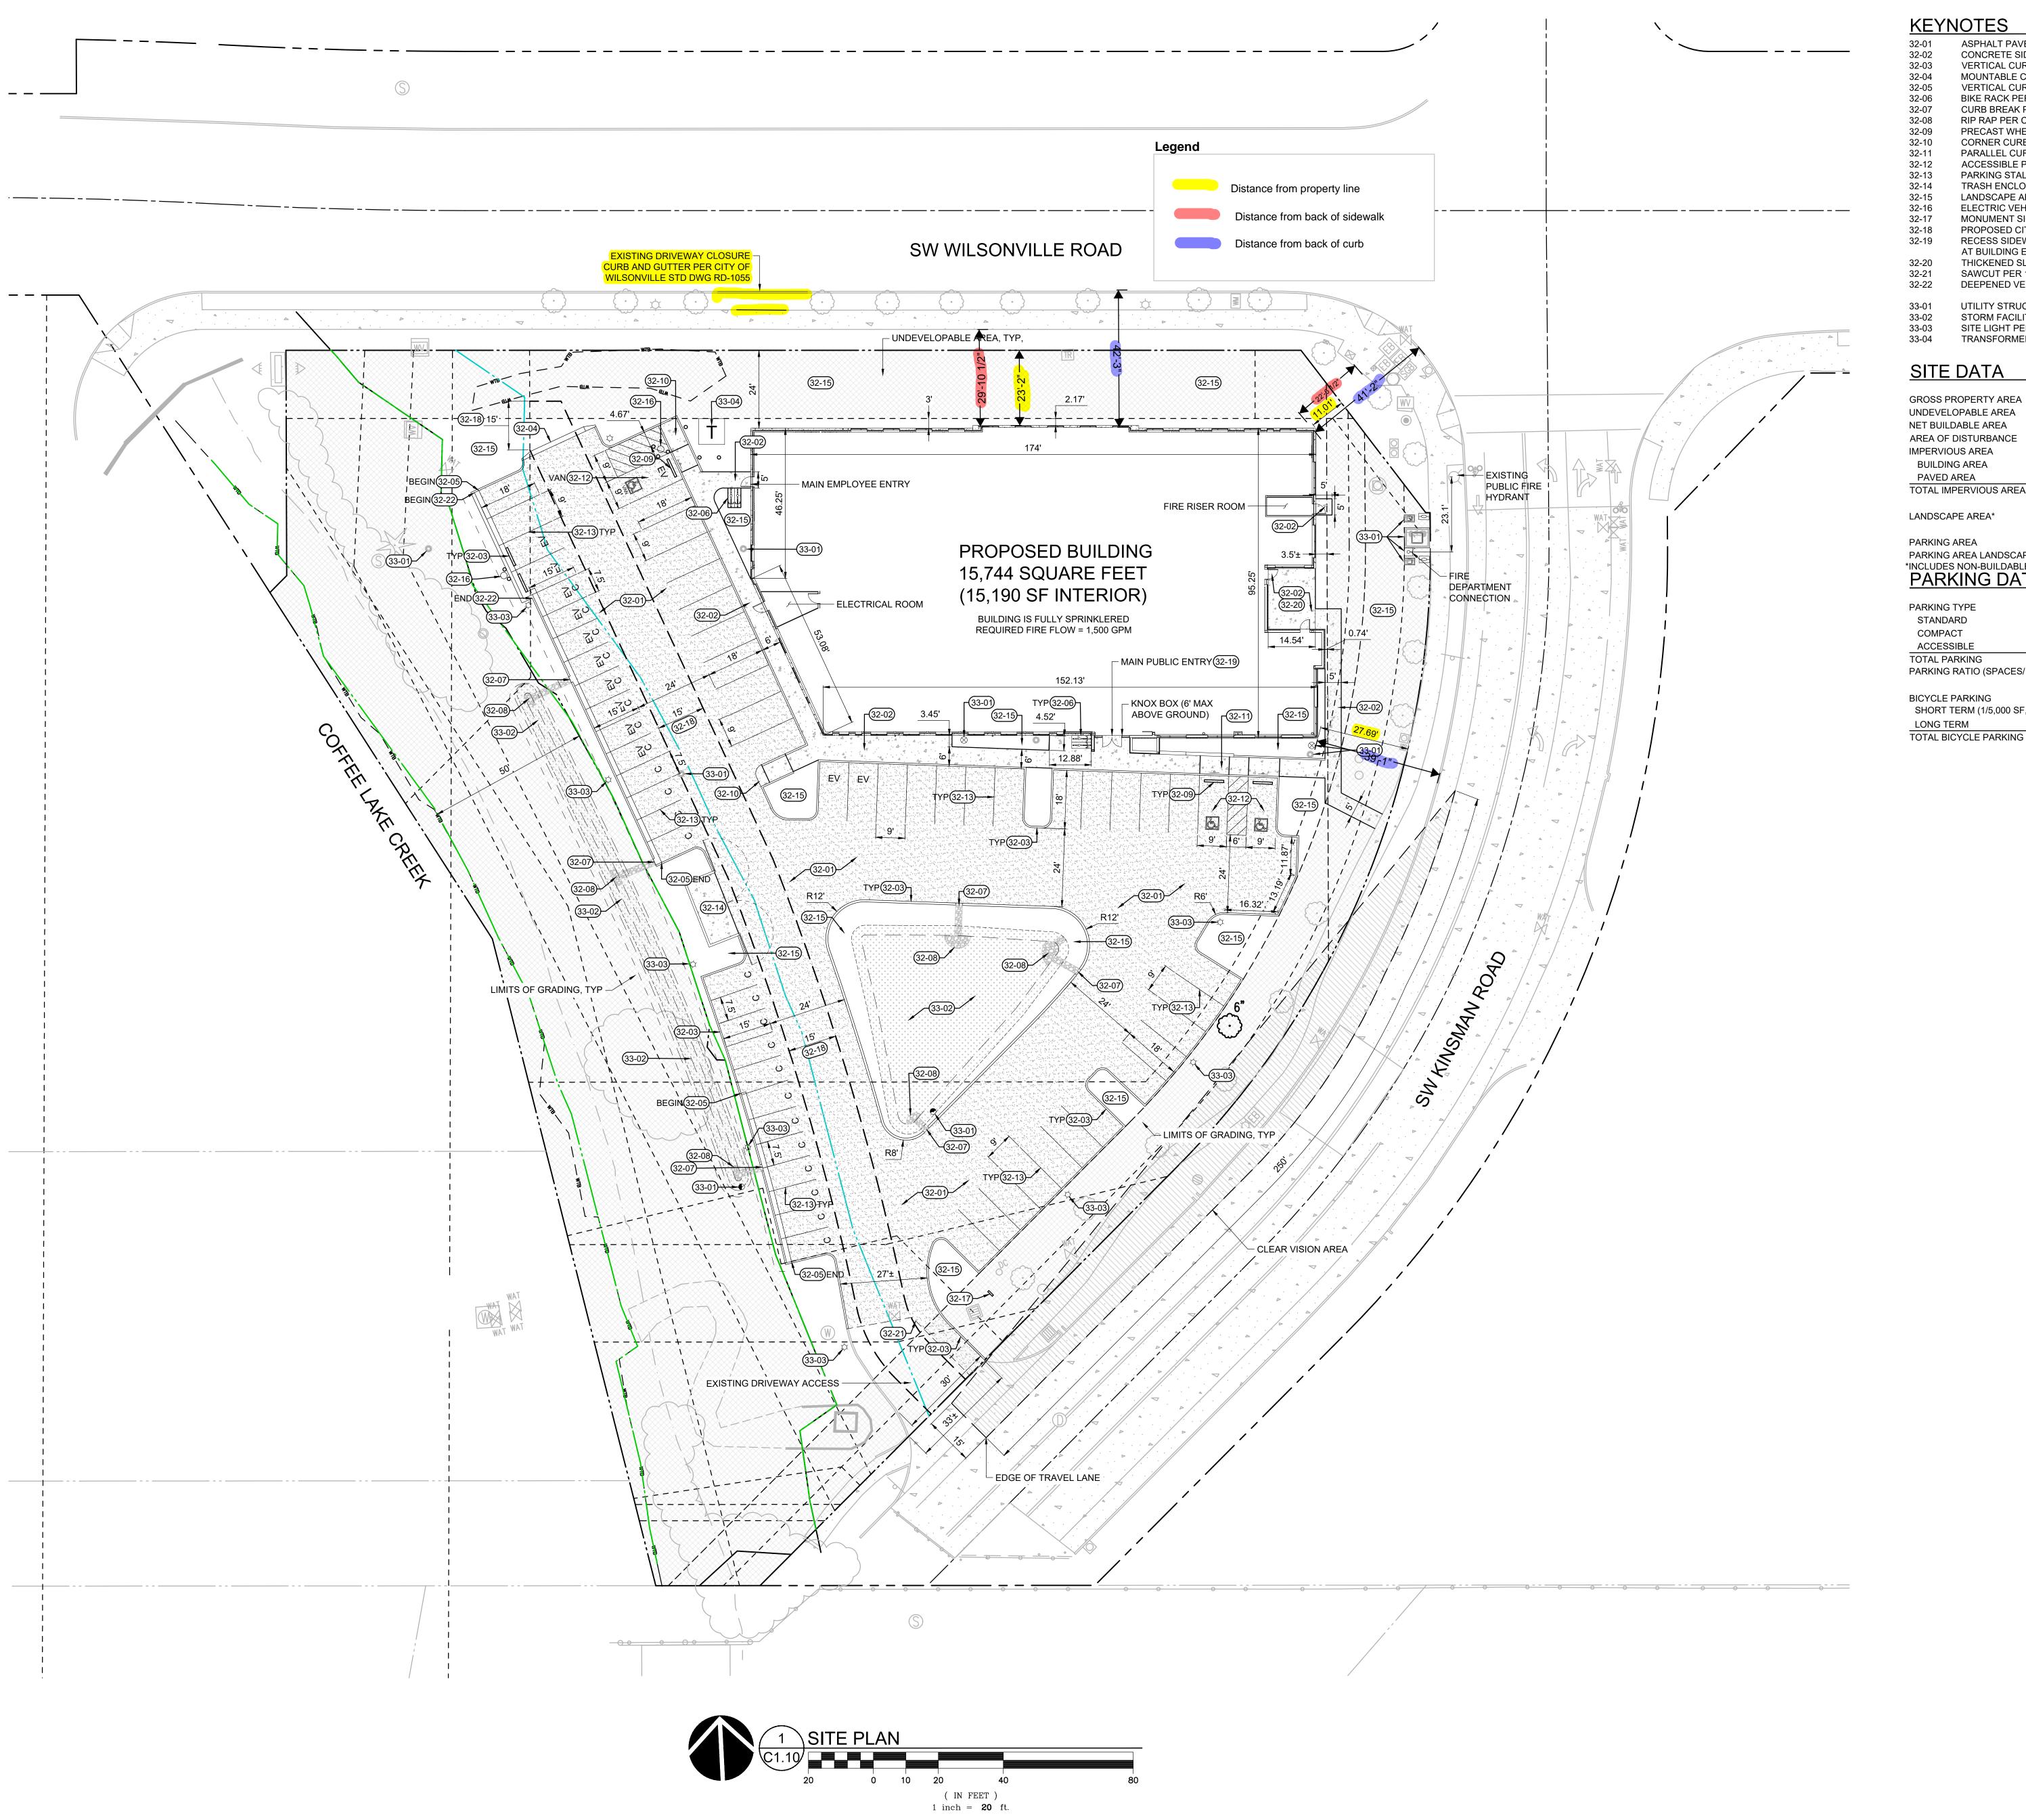
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Delta	Issued As	Issue Date			

EXISTING
CONDITIONS &
DEMOLITION
PLAN

SHEE

C1.01



KEYNOTES

ASPHALT PAVEMENT PER PAVING LEGEND ON C0.01 CONCRETE SIDEWALK PER 2/C5.10

32-03 VERTICAL CURB PER 3/C5.10

MOUNTABLE CURB PER 4/C5.10 32-05 VERTICAL CURB AND GUTTER PER 5/C5.10 BIKE RACK PER 1/C5.10

32-07 CURB BREAK PER 6/C5.10 32-08

RIP RAP PER CITY OF WILSONVILLE STD DWG ST-6020 & ST-6045 32-09 PRECAST WHEEL STOP PER 8/C5.10 CORNER CURB RAMP PER 9/C5.10 32-10

PARALLEL CURB RAMP PER 10/C5.10 ACCESSIBLE PARKING STALL PER 11/C5.10 PARKING STALL STRIPING PER 12/C5.10

TRASH ENCLOSURE PER ARCHITECTURAL PLANS LANDSCAPE AREA PER LANDSCAPE PLANS ELECTRIC VEHICLE CHARGING STATION PER ELECTRICAL PLANS

MONUMENT SIGN PER ARCHITECTURAL PLANS PROPOSED CITY OF WILSONVILLE ACCESS EASEMENT RECESS SIDEWALK THICKNESS AS REQUIRED TO ACCOMMODATE WALK OFF MAT AT BUILDING ENTRANCE PER ARCHITECTURAL PLANS

THICKENED SLAB EDGE ON ALL SIDES OF PATIO SLAB PER 7/C5.10 SAWCUT PER 13/C5.10 DEEPENED VERTICAL CURB PER 14/C5.10 32-22

UTILITY STRUCTURE PER UTILITY PLAN STORM FACILITY PER GRADING AND UTILITY PLANS

SITE LIGHT PER ELECTRICAL PLANS TRANSFORMER WITH PROTECTIVE BOLLARD PER PGE PLANS AND SPECIFICATIONS

SITE DATA

SHEDAIA			
	AREA (SF)	AREA (AC)	COVERAGE
GROSS PROPERTY AREA	89,235	2.05	
UNDEVELOPABLE AREA	37,091	0.85	42%
NET BUILDABLE AREA	52,144	1.20	58%
AREA OF DISTURBANCE	62,604	1.44	70.2%
IMPERVIOUS AREA			
BUILDING AREA	15,744	0.36	17.6%
PAVED AREA	26,898	0.62	30.1%
TOTAL IMPERVIOUS AREA	42,642	0.98	47.8%
LANDSCAPE AREA*	19,962	0.46	31.9%
PARKING AREA	23,073	0.53	
PARKING AREA LANDSCAPE	5,213	0.12	22.6%
*INCLUDES NON-BUILDABLE AREA			
PARKING DATA			
	REQUIRE	D STALLS	PROVIDED STALLS
PARKING TYPE	MINIMUM	MAXIMUM	
STANDARD	0	NONE	38

PARKING TYPE	MINIMUM	MAXIMUM	
STANDARD	0	NONE	38
COMPACT	0	26	24
ACCESSIBLE	0	3	3
TOTAL PARKING	0	NONE	65
PARKING RATIO (SPACES/1,000 SF)	0	4.1	4.1
BICYCLE PARKING	REQUIRE	D SPACES	PROVIDED SPA

SHORT TERM (1/5,000 SF, 2 MIN.)

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SITE PLAN

C1.10



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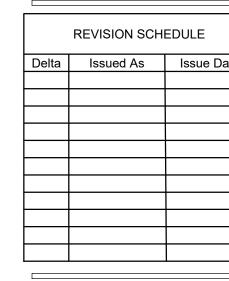
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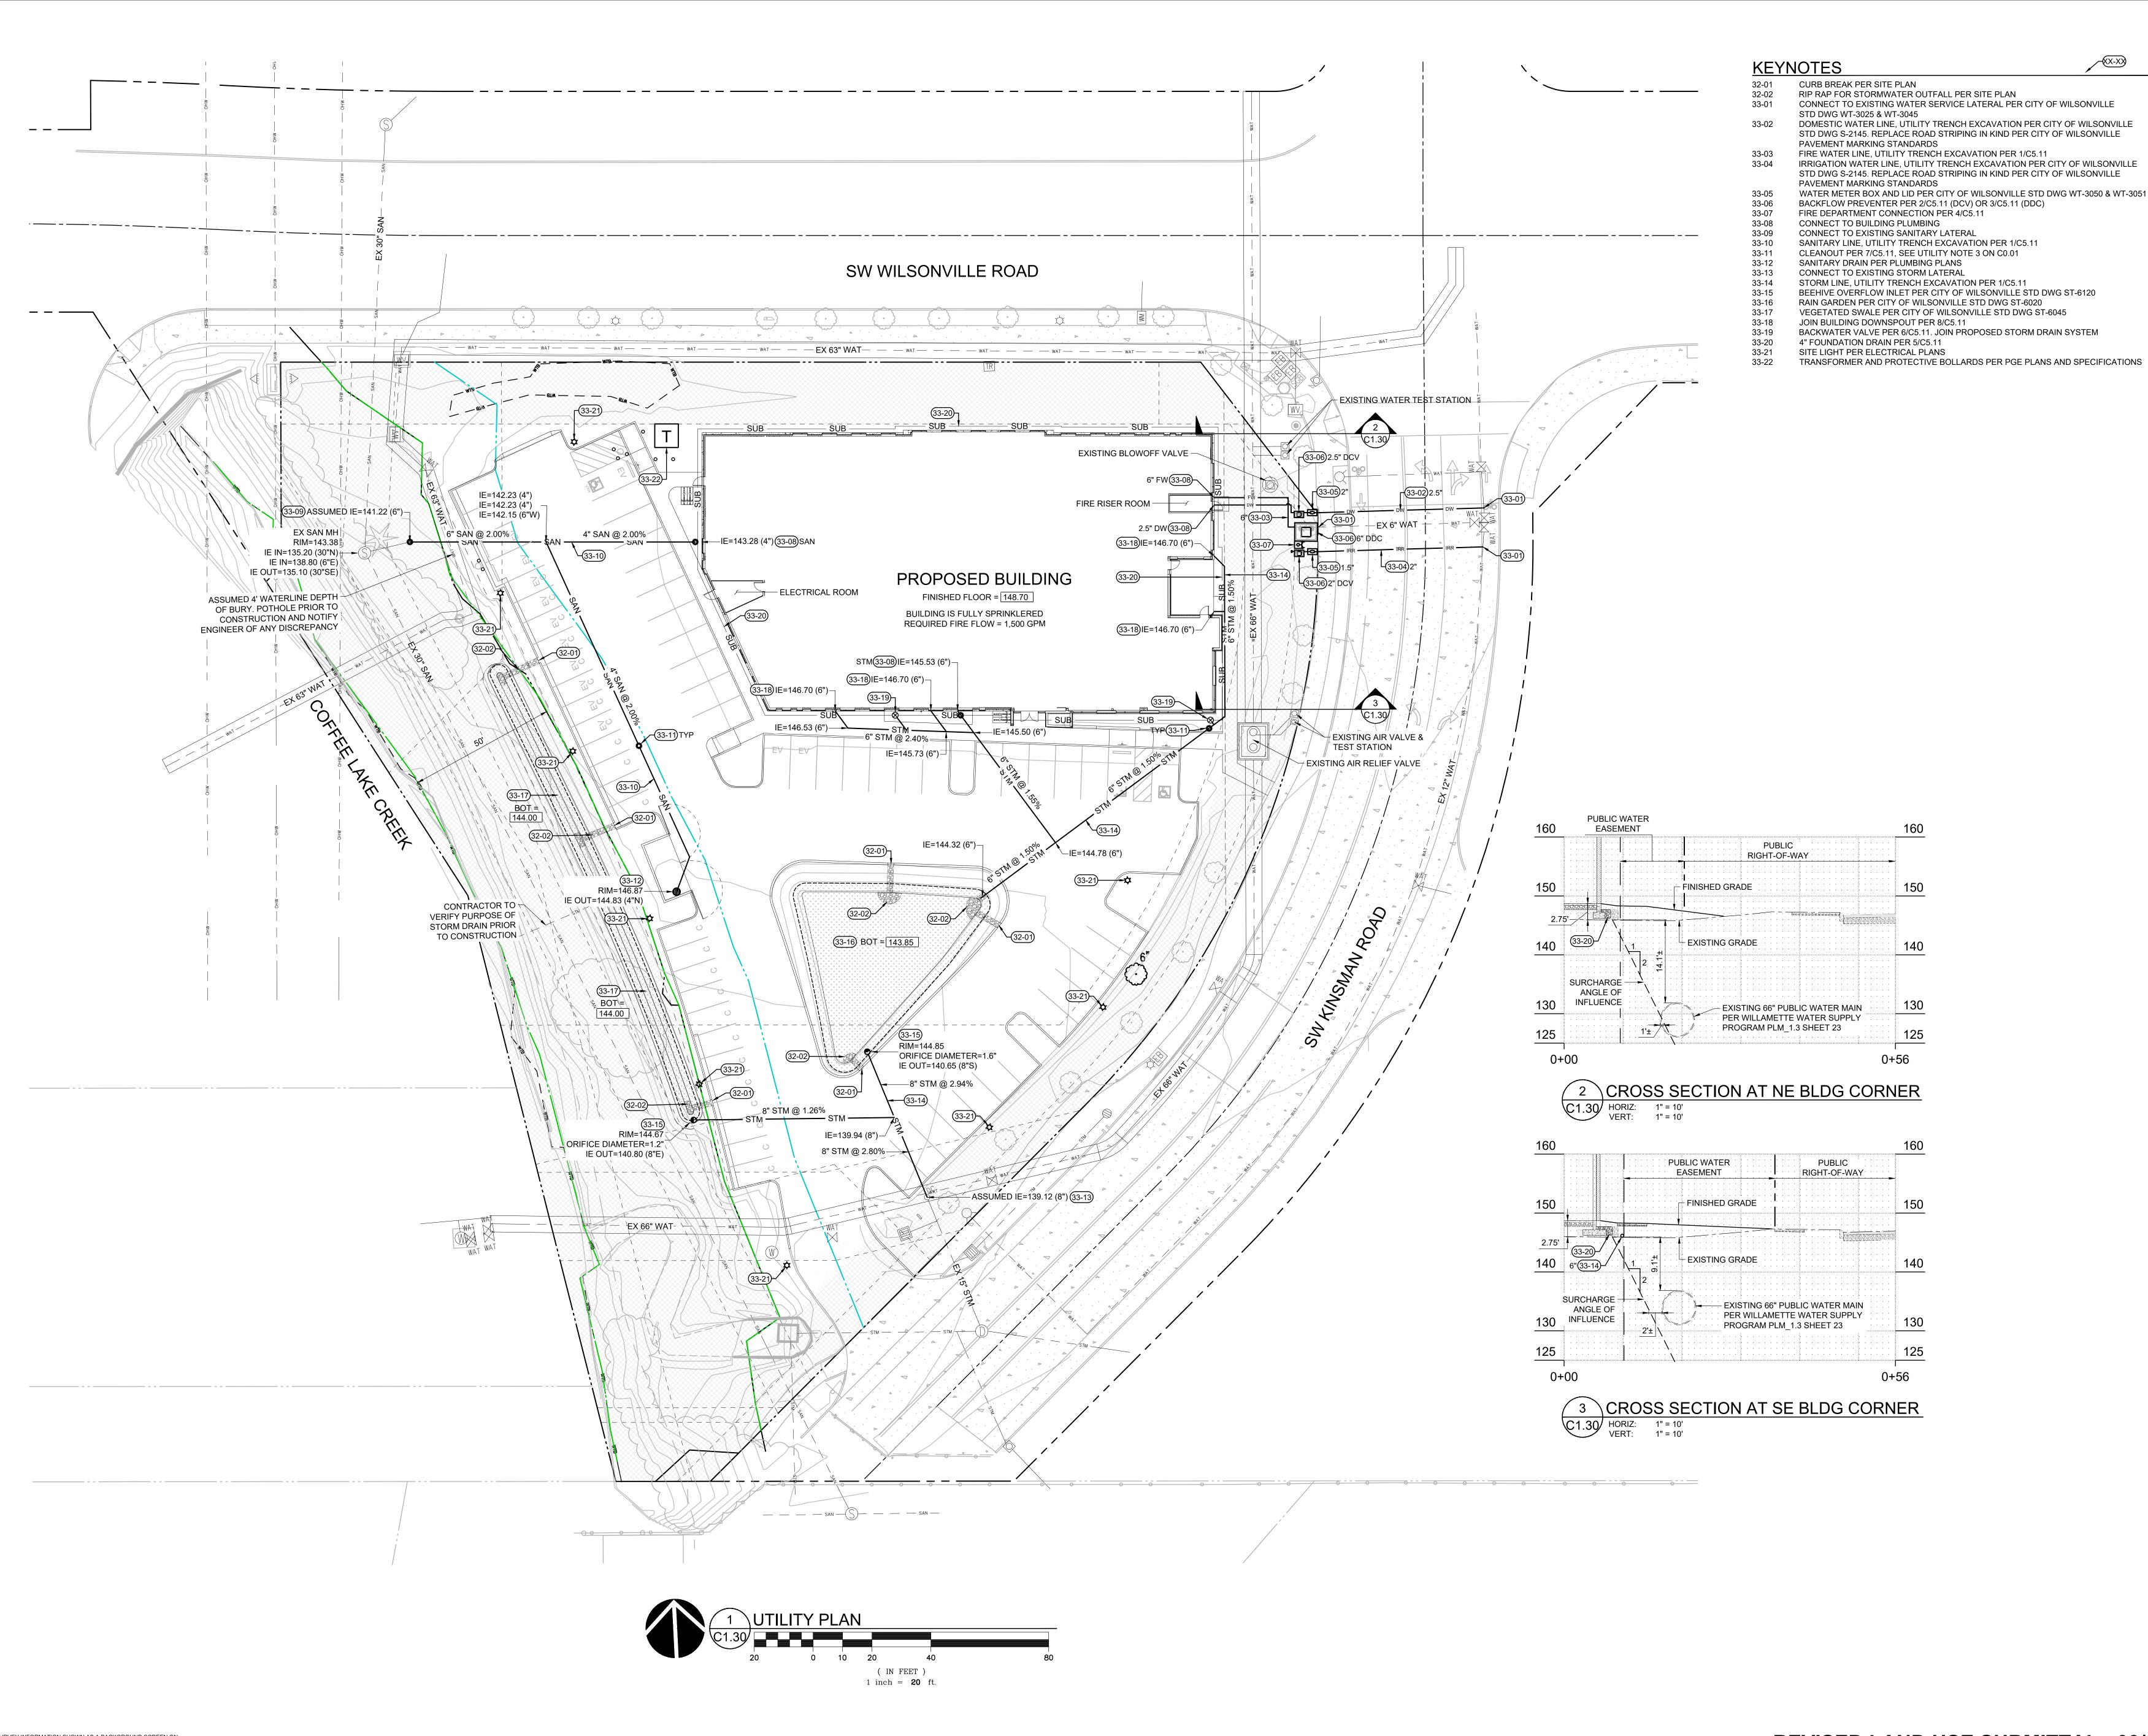


SHEET TITLE:

GRADING PLAN

SHEE

C1.20



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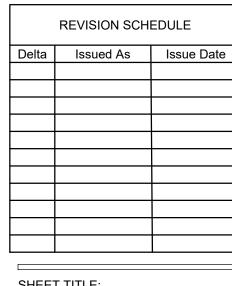
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UTILITY PLAN

SHEE

C1.30

STORMWATER PLANT SCHEDULE

PER CITY OF WILSONVILLE STORMWATER AND SURFACE WATER DESIGN & CONSTRUCTION STANDARDS - SECTION 3 - PUBLIC WORKS STANDARDS (2015)

LANDSCAPE PLAN FACILITY AREA CALCULATIONS INCLUDE TOP OF FREEBOARD. CIVIL PLAN FACILITY AREA CALCULATIONS REPORT TO TOP OF OVERFLOW INLET, EXCLUDING THE FREEBOARD.

PROVIDE AT LEAST 50% EVERGREEN PLANTS AND AT LEAST 2 SPECIES OF HERBACEOUS AND SMALL SHRUBS/GROUNDCOVER PLANT COMMUNITIES.

MOIST (ZONE A) VEGETATION TYPE	QUANTITY	SIZE
GROUNDCOVER PLANTS	115/100 SF	#1 CONTAINER
SMALL SHRUBS	4/100 SF	#1 CONTAINER
LARGE SHRUBS / SMALL TREES	3/100 SF	30" HEIGHT
DRY (ZONE B) VEGETATION TYPE	QUANTITY	SIZE
GROUNDCOVER PLANTS	115/100 SF	#1 CONTAINER
SMALL SHRUBS	4/100 SF	#1 CONTAINER
LARGE SHRUBS / SMALL TREES	3/100 SF	30" HEIGHT
TREE (DECIDUOUS) OR	1/100 SF	1" CALIPER
TREE (EVERGREEN)	1/100 SF	6' HEIGHT

PLANT LIS	Т				
FACILITY A / RAIN	GARDE	N			
PLANT NAME	SIZE	SPACING	EVER- GREEN	ZONE A 1,928 SF	ZONE B 571 SF
REQUIRED HERBACEOUS / GROUND COVER PLANTS (115	5 PER 100 SF)			2217	657
ARCTOSTAPHYLOS UVA-URSI / KINNIKINNICK	#1	12" OC	YES		357
CAREX OBNUPTA / SLOUGH SEDGE	#1	12" OC	YES	740	
FRAGARIA CHILOENSIS / BEACH STRAWBERRY	#1	12" OC	YES		150
JUNCUS PATENS / SPREADING RUSH	#1	12" OC	YES	740	
POLYSTICHUM MUNITUM / WESTERN SWORD FERN	#1	12" OC	YES	737	150
REQUIRED SMALL SHRUBS (4 PER 100 SF)				77	23
CORNUS SERCIA 'KELSEYI' / KELSEY DOGWOOD	#2	36"	NO	37	10
MAHONIA AQUIFOLIUM / OREGON GRAPE	#2	36"	YES	40	
SYMPHORICARPOS ALBUS / SNOWBERRY	#1	36"	NO		13
REQUIRED LARGE SHRUBS / SMALL TREES (3 PER 100 SF	=)			58	17
HOLODISCUS DISCOLOR / OCEANSPRAY	30" HT	48"	NO	18	
RIBES SANGUINEUM / RED FLOWERING CURRANT	30" HT	48"	NO	20	9
SPIREA DOUGLASII / WESTERN SPIREA	30" HT	48"	NO	20	8
REQUIRED TREES (1 PER 100 SF)				0	6
CORNUS NUTTALII / PACIFIC DOGWOOD	1" CAL	AS SHOWN	NO		3
ACER CIRCINATUM / VINE MAPLE	1" CAL	AS SHOWN	NO		3
	тот	AL PLANTS IN	FACILITY	3,	055
	тоти	AL EVERGREEN	N PLANTS	2,9	914
	% E	VERGREEN IN	FACILITY	95	.4%

PLANT LIST					
FACILITY B / SW	ALE				
PLANT NAME	SIZE	SPACING	EVER-	ZONE A	ZONE B
			GREEN	294 SF	989 SF
REQUIRED HERBACEOUS / GROUND COVER PLANTS (115 P	ER 100 SF)			338	1,137
ARCTOSTAPHYLOS UVA-URSI / KINNIKINNICK	#1	12" OC	YES		617
CAREX OBNUPTA / SLOUGH SEDGE	#1	12" OC	YES	114	
FRAGARIA CHILOENSIS / BEACH STRAWBERRY	#1	12" OC	YES		260
JUNCUS PATENS / SPREADING RUSH	#1	12" OC	YES	114	
POLYSTICHUM MUNITUM / WESTERN SWORD FERN	#1	12" OC	YES	110	260
REQUIRED SMALL SHRUBS (4 PER 100 SF)	•			12	40
CORNUS SERCIA 'KELSEYI' / KELSEY DOGWOOD	#2	36"	NO	6	20
MAHONIA AQUIFOLIUM / OREGON GRAPE	#2	36"	YES	6	
SYMPHORICARPOS ALBUS / SNOWBERRY	#1	36"	NO		20
REQUIRED LARGE SHRUBS / SMALL TREES (3 PER 100 SF)				9	30
HOLODISCUS DISCOLOR / OCEANSPRAY	30" HT	48"	NO	3	
RIBES SANGUINEUM / RED FLOWERING CURRANT	30" HT	48"	NO	3	15
SPIREA DOUGLASII / WESTERN SPIREA	30" HT	48"	NO	3	15
REQUIRED TREES (1 PER 100 SF)				0	10
CORNUS NUTTALII / PACIFIC DOGWOOD	1" CAL	AS SHOWN	NO		5
ACER CIRCINATUM / VINE MAPLE	1" CAL	AS SHOWN	NO		5
	тот	AL PLANTS IN	FACILITY	1,	576
	тот	AL EVERGREEN	PLANTS	1,	481
	% E	VERGREEN IN	FACILITY	93	.9%


STORMWATER NOTES

- PLANTING SCHEDULE: CONTAINERIZED STOCK SHALL BE INSTALLED ONLY FROM FEBRUARY 1 THROUGH MAY 1 AND OCTOBER 1 THROUGH NOVEMBER 15. BARE ROOT STOCK SHALL BE INSTALLED ONLY FROM DECEMBER 15 THROUGH APRIL 15. SEEDING SHALL OCCUR ONLY BETWEEN MARCH 1 THROUGH MAY 15 AND SEPTEMBER 1 THROUGH OCTOBER 15.
- EROSION CONTROL: GRADING, SOIL PREPARATION, AND SEEDING SHALL BE PERFORMED DURING OPTIMAL WEATHER CONDITIONS AND AT LOW FLOW LEVELS TO MINIMIZE SEDIMENT IMPACTS. BIODEGRADABLE FABRICS SUCH AS BURLAP MAY BE USED TO SECURE PLANT PLUGS IN PLACE AND TO DISCOURAGE FLOATING UPON INUNDATION. NO PLASTIC MESH THAT CAN ENTANGLE WILDLIFE IS PERMITTED.
- 3. GROWING MEDIUM INSTALLATION:
- PROTECT GROWING MEDIUM FROM ALL SOURCES OF CONTAMINATION, INCLUDING WEED SEEDS, WHILE AT THE SUPPLIER, IN CONVEYANCE, AND AT THE PROJECT SITE.
- 3.2. PLACE MEDIUM IN LOOSE LIFTS, NOT TO EXCEED 8-INCHES AND EACH LIFT SHALL BE COMPACTED WITH A WATER-FILLED LANDSCAPE ROLLER. THE MATERIAL SHALL NOT OTHERWISE BE MECHANICALLY COMPACTED.
- WEATHER PERMITTING, PLANTS SHALL BE INSTALLED AS SOON AS POSSIBLE AFTER PLACING AND GRADING THE GROWING MEDIUM IN ORDER TO MINIMIZE EROSION AND FURTHER
- COMPACTION. TEMPORARY EROSION CONTROL MEASURES ARE REQUIRED UNTIL PERMANENT STABILIZATION

MEASURES ARE FUNCTIONAL, INCLUDING PROTECTION OF OVERFLOW STRUCTURES.

- 3.5. IN ALL CASES, THE FACILITY MUST BE PROTECTED FROM FOOT AND EQUIPMENT TRAFFIC THAT IS UNRELATED TO THE CONSTRUCTION OF THE FACILITY. TEMPORARY FENCING OR WALKWAYS SHOULD BE INSTALLED AS NEEDED TO KEEP WORKERS, PEDESTRIANS, AND EQUIPMENT OUT OF THE FACILITY. UNDER NO CIRCUMSTANCES SHOULD MATERIALS AND EQUIPMENT BE STORED IN THE FACILITY.
- STORMWATER MANAGEMENT FACILITIES SHALL BE KEPT CLEAN AND SHALL NOT BE USED AS EROSION AND SEDIMENT CONTROL STRUCTURES DURING CONSTRUCTION.
- PLACEMENT OF THE GROWING MEDIUM WILL NOT BE ALLOWED WHEN THE GROUND IS FROZEN OR SATURATED OR WHEN THE WEATHER IS DETERMINED TO BE TOO WET.
- 4. MULCHING FOR STORMWATER FACILITIES SHALL BE PER SECTION A.3.7. USE OF MULCH IN FREQUENTLY INUNDATED AREAS SHALL BE LIMITIED TO AVOID ANY POSSIBLE WATER QUALITY IMPACTS INCLUDING THE LEACHING OF TANNINS AND NUTRIENTS, ANFD THE MIGRATION OF MULCH INTO WATER WAYS. MULCHES SHALL BE STABLE AND INERT MATTER OF SUFFICIENT MASS AND DENSITY THAT IT WLL NOT FLOAT IN STANDARD FLOWS, MULCH COVER SHOULD BE MAINTAINED THROUGHOUT THE LIFE OF THE FACILITY WITH MINIMUM THICKNESS OF 2-INCHES IN DEPTH.
- PLANT PROTECTION FROM WILDLIFE: DEPENDING ON SITE CONDITIONS, APPROPRIATE MEASURES SHALL BE TAKEN TO LIMIT WILDLIFE-RELATED DAMAGE. IF BEAVERS OR NUTRIA ARE PRESENT, PROTECT THE MAIN STEM OF ALL TREES WITHIN 100' OF THE EDGE OF WATER WITH 36" OF WIRE
- FERTILIZER SHOULD GENERALLY BE AVOIDED IN STORMWATER FACILITIES. FERTILIZE ALL PLANTS DURING ESTABLISHMENT AS NEEDED WITH SLOW RELEASE, ORGANIC (LOW YIELD) MATERIAL.
- 7. IRRIGATION: A CITY APPROVED IRRIGATION SYSTEM MAY BE USED DURING THE 2-YEAR ESTABLISHMENT PERIOD. WATERING SHALL BE AT A RATE TO MAINTAIN ALL PLANTINGS IN A HEALTHY THRIVING CONDITION DURING ESTABLISHMENT. OTHER IRRIGATION TECHNIQUES, SUCH AS DEEP WATERING, MAY BE ALLOWED WITH PRIOR APPROVAL BY THE CITY'S AUTHORIZED REPRESENTATIVE.
- MAINTENANCE: CHECK FOR WEEDS REGULARLY. CHECK MULCH REGULARLY AND MAINTAIN EVEN COVERAGE. REPLANT BARE PATCHES AS NECESSARY TO COMPLY WITH THE FACILITY'S COVERAGE REQUIREMENTS AND MAINTENANCE PLAN. IMPLEMENT ALL OF THE REQUIRED MAINTENANCE ACTIVITIES LISTED IN THE CITY OF WILSONVILLE VEGETATED STORMWATER MANAGEMENT FACILITY DETAILS.


STREAM BUFFER PLANT SCHEDULE

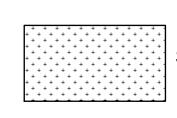

STREAM BUFFER (4,704 SF)

PLANT SPECIES	PERCENTAGE	QTY.	SIZE	SPACI
TREES:				
ACER CIRCINATUM / VINE MAPLE		5	1" CAL.	AS SHO
RHAMNUS PURSHIANA / CASCARA		4	1" CAL.	AS SH
LARGE SHRUBS:				
HOLODISCUS DISCOLOR / OCEANSPRAY	5% (236 SF)	13	#2	48" OC
OEMLERIA CERASIFORMIS / INDIAN PLUM	5% (236 SF)	13	#2	48" OC
PHYSOCARPUS CAPITATUS / PACIFIC NINBARK	5% (236 SF)	13	#2	48" OC
RIBES SANGUINEUM / RED FLOWERING CURRANT	5% (236 SF)	13	#2	48" OC
SPIRAEA DOUGLASII / WESTERN SPIREA	5% (235 SF)	13	#2	48" OC
	,			
SMALL SHRUBS:				
GAULTHERIA SHALLON / SALAL	15% (705 SF)	72	#1	36" OC
MAHONIA AQUIFOLIUM / OREGON GRAPE	15% (705 SF)	72	#1	36" OC
MAHONIA REPENS / CREEPING OREGON GRAPE	15% (705 SF)	72	#1	36" OC
POLYSTICHUM MUNITUM / WESTERN SWORD FERN	15% (705 SF)	72	#1	36" OC
SYMPHORICARPOS ALBUS / SNOWBERRY	15% (705 SF)	72	#1	36" OC
	. 5 / 5 (. 6 6 6 .)	• -		

IMPACT AREA PLANT SCHEDULE

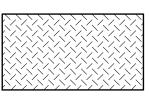

IMPACT AREA MITIGATION PLANTING (280 SF)

PLANT SPECIES	PERCENTAGE	QTY.	SIZE	SPACIN
LARGE SHRUBS: RIBES SANGUINEUM / RED FLOWERING CURRANT	5% (14 SF)	1	#2	48" OC
SMALL SHRUBS: GAULTHERIA SHALLON / SALAL MAHONIA REPENS / LOW OREGON GRAPE POLYSTICHUM MUNITUM / WESTERN SWORD FERN SYMPHORICARPOS ALBUS / SNOWBERRY	30% (84 SF) 20% (56 SF) 25% (70 SF) 20% (56 SF)	9 6 8 6	#1 #1 #1 #1	36" OC 36" OC 36" OC 36" OC

PLANT SCHEDULE

0)44504				
<u>SYMBOL</u>	BOTANICAL / COMMON NAME	SIZE		MATURE H x
TREES				
\bigcirc	ACER CIRCINATUM VINE MAPLE	5' HT. MIN.		15' x 15'
Sold Sold Sold Sold Sold Sold Sold Sold	ACER RUBRUM 'OCTOBER GLORY' BOWHALL RED MAPLE	12' HT. MIN.		50' x 50'
	CONIFEROUS TREE TO REMAIN			
E	CORNUS NUTTALLII X FLORIDA 'EDDIE'S WHITE WONDER' EDDIE'S WHITE WONDER DOGWOOD	1" CAL. B&B		25' x 20'
•	DECIDUOUS TREE TO REMAIN			
Section 1	RHAMNUS PURSHIANA CASCARA	1" CAL. B&B		30' x 25'
$\overline{(\cdot)}$	STREET TREE TO REMAIN			
\bigcirc	TILIA TOMENTOSA 'STERLING' STERLING SILVER LINDEN	12' HT. MIN.		45' x 30'
00000000000000000000000000000000000000	ZELKOVA SERRATA 'GREEN VASE' GREEN VASE JAPANESE ZELKOVA	2" CAL. B&B		60' x 40'
SYMBOL _	BOTANICAL / COMMON NAME	SIZE	SPACING	MATURE H x
<u>SHRUBS </u>	BOUTELOUA GRACILIS 'BLONDE AMBITION'	2 GAL.	36" o.c.	3' x 3'
\(\)	BLONDE AMBITION BLUE GRAMA GRASS CALAMAGROSTIS X ACUTIFLORA 'KARL FOERSTER'	2 GAL.	24" o.c.	5' x 2'
	FEATHER REED GRASS CLEMATIS X 'ARABELLA'	1 GAL.	12" o.c.	1' x 4'
	ARABELLA CLEMATIS CORNUS SERICEA 'FARROW'			
Now May 1	ARCTIC FIRE RED TWIG DOGWOOD CORNUS SERICEA 'KELSEYI'	2 GAL.	48" o.c.	4' x 4'
	KELSEY DOGWOOD FRAGRANT SWEET BOX	2 GAL.	36" o.c.	2' x 3'
	SARCOCOCCA RUSCIFOLIA	2 GAL.	48" o.c.	4' x 4'
3 . 5	MAHONIA AQUIFOLIUM OREGON GRAPE	2 GAL.	48" o.c.	6' x 4'
	MAHONIA AQUIFOLIUM 'COMPACTA' COMPACT OREGON GRAPE	2 GAL.	36" o.c.	3' x 4'
	NANDINA DOMESTICA 'LEMON-LIME' LEMON LIME NANDINA	2 GAL.	36" o.c.	3' x 3'
A STATE OF THE STA	PINUS MUGO 'SLOWMOUND' SLOWMOUND MUGO PINE	2 GAL.	48" o.c.	3' x 4'
•	RIBES SANGUINEUM RED FLOWERING CURRANT	2 GAL.	60" o.c.	5' x 5'
JUDULIU OUE	ROSA X 'NOA97400A'	2 GAL.	36" o.c.	2' x 3'
+)	FLOWER CARPET AMBER ROSE ROSA X 'RADSUNNY'	2 GAL.	36" o.c.	3' x 3'
344	SUNNY KNOCK OUT SHRUB ROSE SALVIA NEMOROSA 'CARADONNA'	1 GAL.		
2. 2. 2. 2. 2. 2. 2. 2. 2. 2. 2. 2. 2. 2	MEADOW SAGE SPIRAEA BETULIFOLIA 'TOR GOLD'		18" o.c.	2' x 1.5'
الريخي المناسبة	GLOW GIRL BIRCHLEAF SPIREA SYMPHORICARPOS ALBUS	2 GAL.	48" o.c.	4' x 4'
	COMMON SNOWBERRY	2 GAL.	48" o.c.	3' x 4'
GROUND	COVERS ARCTOSTAPHYLOS UVA-URSI		1	
	KINNIKINNICK CRUSHED ROCK SURFACING	1 GAL.	24" o.c.	
	1/4", CLEAN, NO FINES, COMPACTED			
	FRAGARIA CHILOENSIS BEACH STRAWBERRY	1 GAL.	24" o.c.	
	IMPACT AREA MITIGATION PLANTING SEE PLANT SCHEDULE LO.01			
n n	PLANTING BY OTHERS PRESERVE AND PROTECT			
	1000/ 1111 011			
	ROCK MULCH 1-2" WASHED DRAIN ROCK		<u> </u>	
	1-2" WASHED DRAIN ROCK RUBUS CALYCINOIDES 'EMERALD CARPET'	1 GAL.	24" o.c.	
	1-2" WASHED DRAIN ROCK RUBUS CALYCINOIDES 'EMERALD CARPET' EMERALD CARPET CREEPING BRAMBLE STORMWATER ZONE A	1 GAL.	24" o.c.	
	1-2" WASHED DRAIN ROCK RUBUS CALYCINOIDES 'EMERALD CARPET' EMERALD CARPET CREEPING BRAMBLE	1 GAL.	24" o.c.	

SHEET INDEX

- L0.01 LANDSCAPE GENERAL INFORMATION
- L0.02 LANDSCAPE CODE PLAN L0.03 TREE AND VEGETATION PROTECTION PLAN
- L1.10 PLANTING PLAN NORTH
- L1.11 PLANTING PLAN SOUTH L5.10 DETAILS

LANDSCAPE NOTES

COMMENCEMENT OF WORK.

- 1. CONTRACTOR SHALL CONFIRM ALL EXISTING CONDITIONS PRIOR TO COMMENCING WORK.
- 2. CALL BEFORE YOU DIG. CONTRACTOR SHALL VERIFY INVERT ELEVATIONS OF ALL UNDERGROUND UTILITIES AND NOTIFY LANDSCAPE ARCHITECT IF THERE ARE ANY DISCREPANCIES WITH PLANTING ROOT ZONES. TO REQUEST LOCATES FOR PROPOSED EXCAVATION CALL 1-800-332-2344 (OR 811) IN OREGON.
- 3. NOTIFY THE OWNER OR OWNER'S REPRESENTATIVE OF ANY DISCREPANCIES OR CONFLICTS WITH EXISTING CONDITIONS PRIOR TO COMMENCEMENT OF ANY WORK.
 - LOCATION OF EXISTING TREES SHALL BE VERIFIED IN THE FIELD BY THE CONTRACTOR PRIOR TO
- 5. DAMAGE TO EXISTING CONCRETE CURB, ASPHALT PAVING, OR OTHER STRUCTURE SHALL BE REPAIRED OR REPLACED TO PRE CONSTRUCTION CONDITIONS.
- 6. CONTRACTOR SHALL COORDINATE WITH THE OWNER ANY DISRUPTION TO VEHICULAR CIRCULATION PRIOR TO COMMENCEMENT OF ANY WORK.
- 1. ALL EXISTING TREES, PLANTS, AND ROOTS SHALL BE PROTECTED FROM DAMAGE FROM ANY CONSTRUCTION
- PREPARATION, REMOVAL OR INSTALLATION ACTIVITIES WITHIN AND ADJACENT TO PROJECT LIMITS. 2. SHRUBS ADJACENT TO PARKING AREAS SHALL BE PLANTED 2 FT MINIMUM AWAY FROM THE BACK OF CURB.
- SHRUBS AND GROUNDCOVER ALONG OTHER PAVEMENT EDGES SHALL BE PLANTED A MINIMUM OF ONE HALF THEIR ON CENTER SPACING AWAY FROM PAVEMENT EDGE. 3. ALL PLANT MATERIAL SHALL BE HEALTHY NURSERY STOCK, WELL BRANCHED AND ROOTED, FULL FOLIAGE,
- FREE FROM INSECTS, DISEASES, WEEDS, WEED ROT, INJURIES AND DEFECTS WITH NO LESS THAN MINIMUMS SPECIFIED IN AMERICAN STANDARDS FOR NURSERY STOCK, ANSI Z60.1-2004.
- 4. TREES IN THE RIGHT OF WAY SHALL BE TALL ENOUGH TO BE LIMBED UP TO AT LEAST 8 FT ABOVE DRIVE SURFACE GRADE WHILE MAINTAINING ENOUGH BRANCHES TO SUPPORT HEALTHY GROWTH.
- 5. DO NOT PLANT TREES ABOVE WATERLINES, UTILITIES, OR OTHER UNDERGROUND PIPING.
- IF DISTURBANCE IS NECESSARY AROUND EXISTING TREES, CONTRACTOR SHALL PROTECT THE CROWN AND ALL WORK WITHIN THE TREE DRIPZONE SHALL BE LIMITED TO THE USE OF HAND TOOLS AND MANUAL EQUIPMENT ONLY.
- REPLACE, REPAIR AND RESTORE DISTURBED LANDSCAPE AREAS DUE TO GRADING, TRENCHING OR OTHER REASONS TO PRE-CONSTRUCTION CONDITION AND PROVIDE MATERIAL APPROVED BY THE OWNER AND OWNER'S REPRESENTATIVE.
- EXISTING AREAS PROPOSED FOR NEW PLANT MATERIAL SHALL BE CLEARED AND LEGALLY DISPOSED UNLESS
- 9. A SOILS ANALYSIS, BY AN INDEPENDENT SOILS TESTING LABORATORY RECOGNIZED BY THE STATE DEPARTMENT OF AGRICULTURE, SHALL BE USED TO RECOMMEND AN APPROPRIATE PLANTING SOIL AND/OR SPECIFIED SOIL AMENDMENTS.
- 10. TOPSOIL SHALL BE AMENDED AS RECOMMENDED BY AN INDEPENDENT SOILS TESTING LABORATORY AND AS
- OUTLINED IN THE SPECIFICATION. 11. ALL LANDSCAPED AREAS SHALL BE COVERED BY A LAYER OF ORGANIC MULCH TO A MINIMUM DEPTH OF

2-INCHES.

- UNLESS OTHERWISE INDICATED, ALL NEW LANDSCAPE AREAS TO BE IRRIGATED WITH A FULLY AUTOMATIC UNDERGROUND IRRIGATION SYSTEM. PROVIDE LOOP SYSTEM FOR OPTIMUM EFFICIENCY.
- CONTRACTOR SHALL SUBMIT SHOP DRAWINGS (IRRIGATION PLANS) TO LANDSCAPE ARCHITECT PRIOR TO CONSTRUCTION. DRAWINGS TO INDICATE HEAD TYPE, GALLONS PER MINUTE, LATERAL LINES, AND BE AT
- MINIMUM SCALE OF 1"=20" CONTRACTOR TO DETERMINE STATIC WATER PRESSURE AT THE P.O.C. PRIOR TO PREPARING SHOP
- CONTRACTOR SHALL ESTABLISH MINIMUM PRESSURE AND MAXIMUM DEMAND REQUIREMENTS FOR
- IRRIGATION SYSTEM DESIGN, AND PROVIDE INFORMATION IN AN IRRIGATION SCHEDULE. IRRIGATION SYSTEM AS DESIGNED AND INSTALLED SHALL PERFORM WITHIN THE TOLERANCES AND
- SPECIFICATIONS OF THE SPECIFIED MANUFACTURERS. SYSTEM SHALL BE DESIGNED TO SUPPLY MANUFACTURER'S SPECIFIED MINIMUM OPERATING PRESSURE TO
- FARTHEST EMITTER FROM WATER METER. 7. SYSTEM SHALL PROVIDE HEAD TO HEAD COVERAGE WITHOUT OVERSPRAY ONTO BUILDING, FENCES, SIDEWALKS, PARKING AREAS, OR OTHER NON-VEGETATED SURFACES.
- 8. ALL IRRIGATION PIPE MATERIAL AND INSTALLATION SHALL CONFORM TO APPLICABLE CODE FOR PIPING AND
- 9. PROVIDE SLEEVING AT ALL AREAS WHERE PIPE TRAVELS UNDER CONCRETE OR HARD SURFACING.
- 10. VALVES SHALL BE WIRED AND INSTALLED PER MANUFACTURER'S RECOMMENDED INSTALLATION PROCEDURES AND CONNECTED TO THE IRRIGATION CONTROLLER.

BUILDING, IN PLANTERS, AND WITHIN PARKING AREA.

- 11. ZONE THE FOLLOWING AREAS SEPARATELY: STORMWATER AREAS, STREAM BUFFER AREAS, PERMANENT LANDSCAPE AREAS, AND TREES.
- 12. QUICK COUPLERS TO BE PLACED EVERY 150 LINEAR FEET MAX.INCLUDE QUICK COUPLER ADJACENT TO TRASH
- 13. IRRIGATION SHALL BE WINTERIZED THROUGH LOW PRESSURE, HIGH VOLUME AIR BLOWOUT CONNECTION THROUGH QUICK COUPLER.
- 14. PROVIDE SPRAY IRRIGATION WITHIN STREAM BUFFER, STORMWATER FACILITIES, AND AT NORTH END OF PARKING LOT WITHIN GROUNDCOVER AT WATER UTILITY ACCESS. PROVIDE DRIP IRRIGATION AROUND

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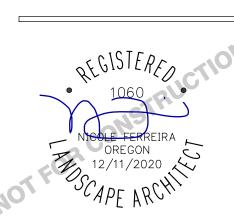
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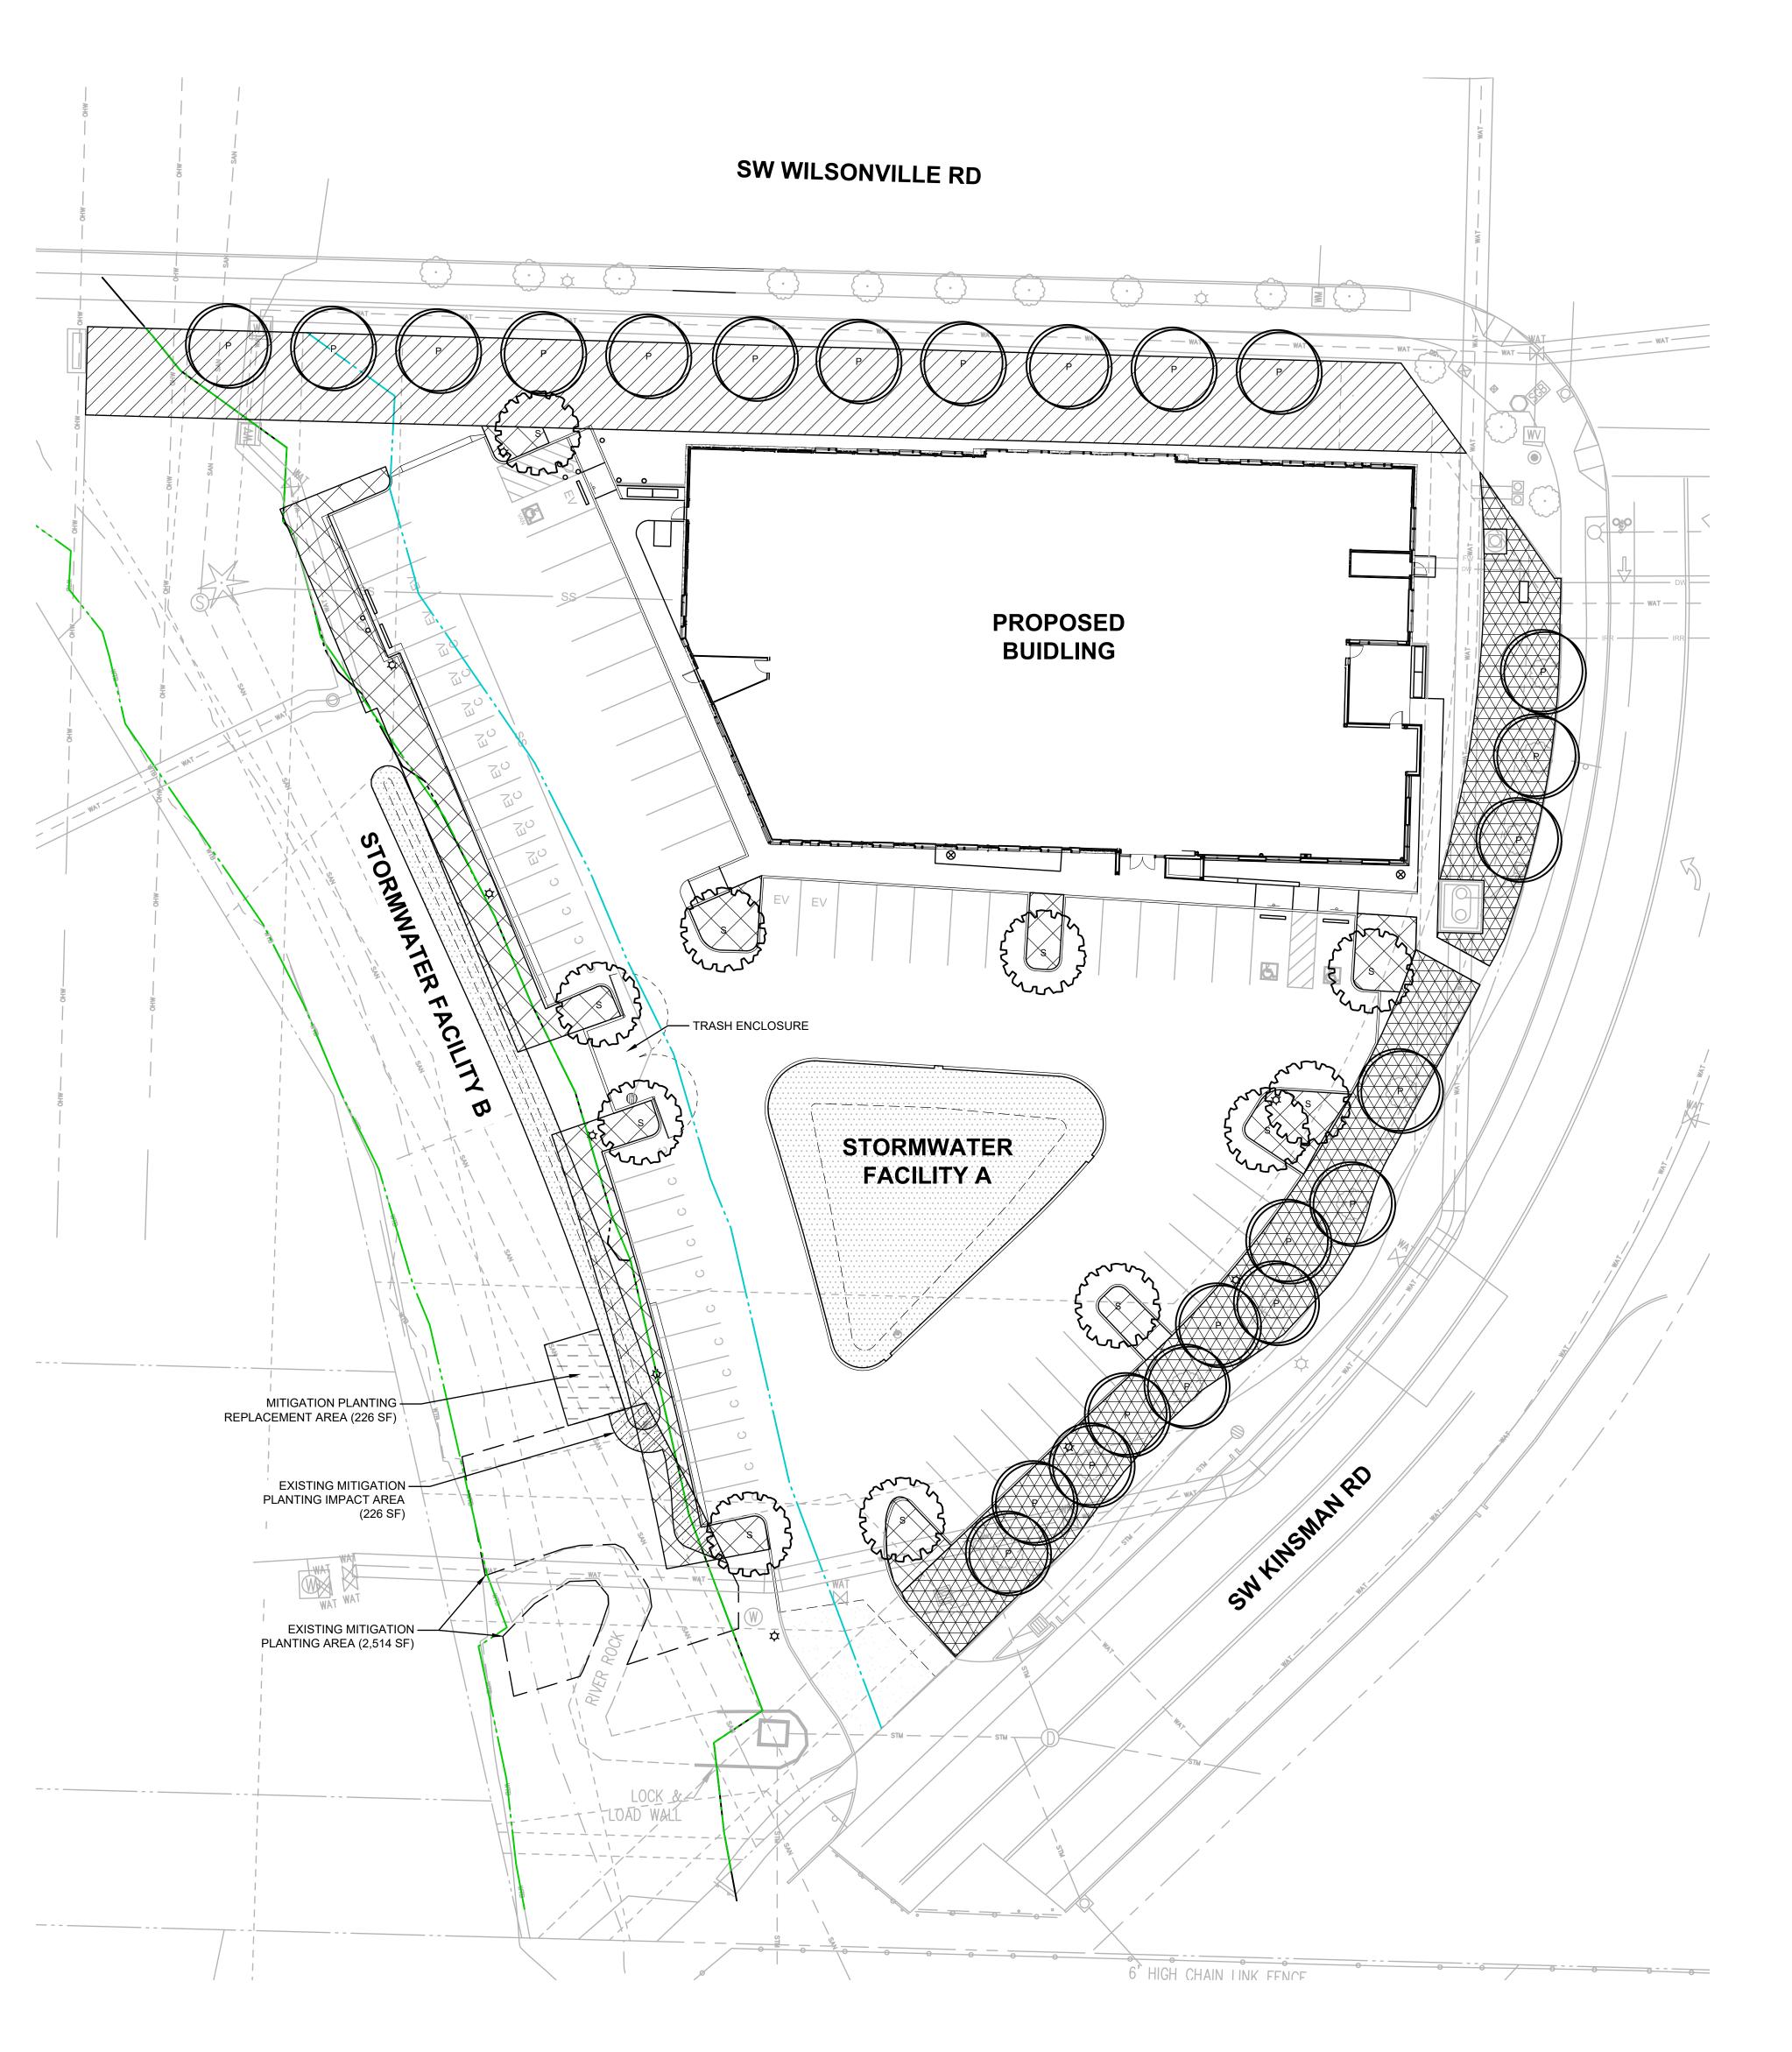
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GENERAL INFORMATION

LANDSCAPE

L0.01






CODE LEGEND

LOW SCREEN LANDSCAPING ALONG SW WILSONVILLE RD LOW SCREEN LANDSCAPING ALONG SW KINSMAN RD

PARKING LOT LANDSCAPE

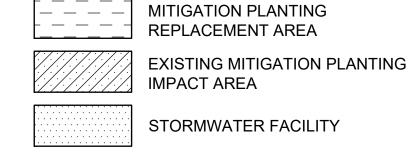

ZONING COMPLIANCE

SECTION 4.176(.02)

D. LOW SCREEN LANDSCAPING STANDARD
ONE TREE PER 30 LF, 3-FT HT EVERGREEN HEDGE, AND GROUNDCOVER TO FULL COVERAGE.

APPLIES ALONG SW WILSONVILLE ROAD FRONTAGE

FRONTAGE 312 LF TREES REQUIRED (1 PER 30 LF) 11 TREES **EXISTING** 0 TREES ADDTL. PROVIDED 11 TREES 11 TREES

APPLIES ALONG SW KINSMAN ROAD FRONTAGE

FRONTAGE TREES REQUIRED (1 PER 30 LF) 13 TREES 9 TREES **EXISTING** ADDTL. PROVIDED 4 TREES TOTAL 13 TREES

SECTION 4.176(.03) LANDSCAPING AREA


NOT LESS THAN 15% OF TOTAL LOT AREA INCLUDING 10% OF PARKING AREA, IS LOCATED IN THREE SEPARATE AND DISTINCT AREAS OF THE LOT. LANDSCAPING IS PROVIDED ALONG THE FRONTAGE, THE FULL PERIMETER, WITHIN THE PARKING LOT, AND ADJACENT THE BUILDING.

SECTION 4.176(.06)

A. SHRUBS AND GROUNDCOVER SHRUBS ARE 2-GAL OR BETTER. WHERE FEASIBLE NATIVE TOPSOIL WILL BE STOCKPILED OFFSITE, REUSED, AND AMENDED WITH COMPOST. GROUNDCOVER IS SIZED TO PROVIDE AT LEAST 80% COVERAGE WITHIN 3 YEARS. TURF OR LAWN COVERS LESS THAN 10% OF LANDSCAPE AREA AND IRRIGATION DRAINAGE SHALL BE RETAINED WITHIN LAWN AREA.

B. TREES
TREES SHOULD BE WELL BRANCHED AND TYPICAL OF THEIR TYPE AS DESCRIBED IN THE CURRENT AMERICAN
OF TANDARDO AND SHALL BE BALLED AND BLIRL APPED. TREES SHOULD BE ASSOCIATION OF NURSERYMEN (AAN) STANDARDS AND SHALL BE BALLED AND BURLAPPED. TREES SHOULD BE GROUPED AS FOLLOWS:

- 1. PRIMARY TREES, WHICH DEFINE, OUTLINE, OR ENCLOSE MAJOR SPACES, SHALL BE A MINIMUM OF 2"
- 2. SECONDARY TREES, WHICH DEFINE, OUTLINE, OR ENCLOSE INTERIOR AREAS, SHALL BE A MINIMUM OF
- ACCENT TREES, WHICH ARE USED TO ADD COLOR, VARIEGATION, AND ACCENT TO ARCHITECTURAL
- FEATURES, SHALL BE A MINIMUM OF 1-3/4" CALIPER. LARGE CONIFER TREES ARE 8-FOOT TALL OR BETTER.

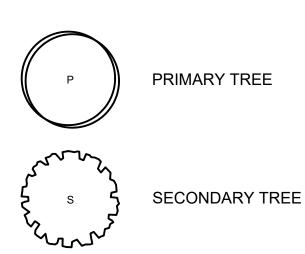

MEDIUM CONIFER TREES ARE 5-FOOT TALL OR BETTER.

PROPOSED DEVELOPMENT IS LARGER THAN 24-FEET IN HEIGHT. AT MATURITY TREES WILL BE AT LEAST 50% THE HEIGHT OF THE BUILDING. DECIDUOUS TREES SHALL BE AT LEAST 10-FEET TALL AND 2-INCH CALIPER. EVERGREEN TREES MUST BE AT LEAST 12-FEET IN HEIGHT. LARGER PLANT MATERIAL HAS BEEN PROVIDED ALONG THE FRONTAGE.

D. STREET TREES NO STREET TREES PROPOSED

E. PLANT SPECIES
THE LANDSCAPE CONSISTS OF EXISTING LANDSCAPING AND/OR NATIVE VEGETATION TO BE PROTECTED AND AND DROUGHT TO FRANT PLANT MATERIAL. PLANT MATERIAL MAINTAINED DURING CONSTRUCTION AND NATIVE AND DROUGHT TOLERANT PLANT MATERIAL. PLANT MATERIAL PROVIDED HAS BEEN CROSS-REFERENCED WITH THE CITY'S LIST OF PROHIBITED PLANT MATERIALS. F. TREE CREDITS
NO TREE CREDITS ARE REQUESTED

SECTION 4.176(.07)

INSTALLATION AND MAINTENANCE

SEE PLANTING NOTES L0.01. PLANT MATERIAL REQUIRED BY CODE SHALL BE CONTINUOUSLY MAINTAINED BY OWNER AND REPLACED IN KIND WITHIN ONE GROWN SEASON IF DEAD.

IRRIGATION SEE IRRIGATION NOTES L0.01. PERMANENT SYSTEM TO BE A DEFERRED SUBMITTAL PROVIDED BY LANDSCAPE CONTRACTOR.

SECTION 4.176(.09)

PLANT MATERIAL LIST SEE PLANT SCHEDULE L0.01.

CONDITION OF EXISTING PLANTINGS

ONLY TREES ARE PROPOSED FOR RETENTION. SEE TABLE FOR RETAINED TREES ON L0.03 FOR CONDITION.

WATER USAGE
THE LANDSCAPE CONSISTS OF NATIVE AND DROUGHT TOLERANT PLANT MATERIAL. THE FULL SITE FALLS WITHIN THE LOW WATER USAGE CATEGORY C REQUIRING LESS THAN ONE INCH PER WEEK.



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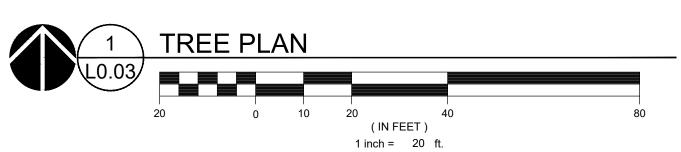
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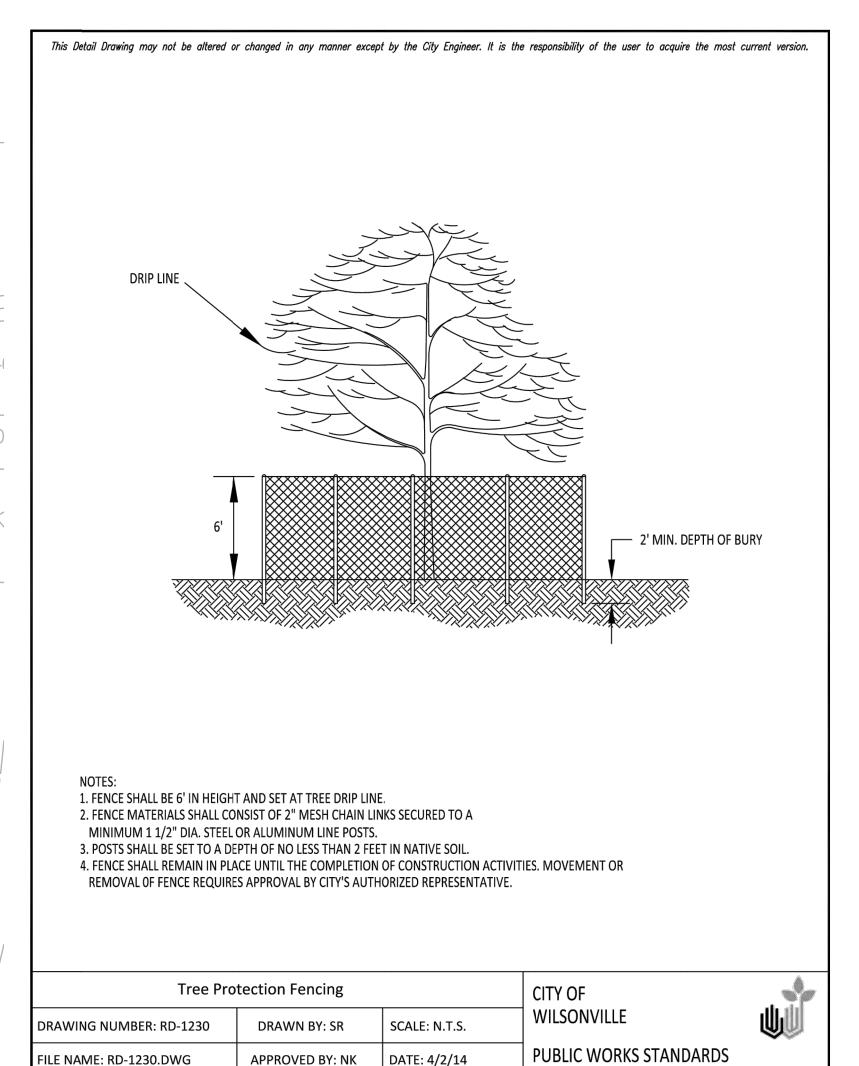
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LANDSCAPE **CODE PLAN**


L0.02







2 TREE PROTECTION FENCING
SCALE: NTS

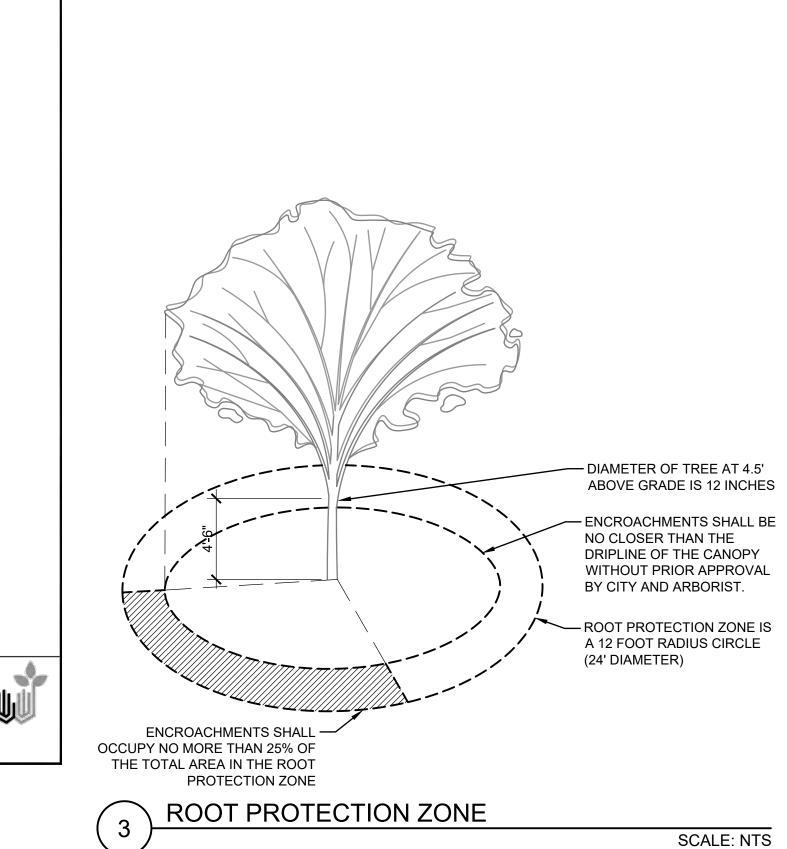

TREE SCHEDULE

DECIDUOUS TREE TO REMAIN

CONIFEROUS TREE TO REMAIN

ROOT PROTECTION ZONE

TREE TO REMOVE

TREE TO BE PROVIDED UNDER SEPARATE PERMIT

TREE BY OTHER PERMIT, TO BE RELOCATED

TREE PROTECTION FENCING

TREES

CONIFEROUS TREE TO REMAIN

CONIFEROUS TREE TO REMOVE

2

ON-SITE DECIDUOUS TREE TO REMAIN

5

ON-SITE DECIDUOUS TREE TO REMOVE

1

OFF-SITE DECIDUOUS TREE TO REMAIN

10

OFF-SITE DECIDUOUS TREE TO REMOVE

0

TREE BY OTHER PERMIT TO REMAIN

7

TREE BY OTHER PERMIT TO RELOCATE

1

NOTES

COMPACTION WORK.

- REFERENCE PLANTING PLAN FOR NEW TREE PLANTINGS.
 ALL EROSION CONTROL MEASURES AND TREE PROTECTION F
- ALL EROSION CONTROL MEASURES AND TREE PROTECTION FENCING ARE TO BE INSTALLED PRIOR TO ANY DEMOLITION ACTIVITIES.
- PROTECT EXISTING LANDSCAPING TO THE MAXIMUM EXTENT PRACTICABLE.
- NOTED OTHERWISE.

 5. CRITICAL ROOT ZONES AND TREE PROTECTION FENCING ONLY SHOWN

4. PROTECT ALL UNDERGROUND UTILITY SERVICES AND CONDUIT UNLESS

- FOR TREES AFFECTED BY DEVELOPMENT.

 6. ARBORIST MONITORING: ARBORIST SHALL BE ON SITE DURING
- EXCAVATION WITHIN CRITICAL ROOT ZONES OF EXISTING TREES.

 7. TREES REMOVED WITHIN THE SROZ WILL BE REPLANTED AT A 1:1 RATIO.
- 8. NO ACTIVITY MAY BE CONDUCTED WITHIN ANY DESIGNATED TREE PROTECTION AREA INCLUDING BUT NOT LIMITED TO PARKING EQUIPMENT, PLACING SOLVENTS, STORING MATERIALS AND SOIL DEPOSITS, DUMPING CONCRETE WASHOUT, OR OTHER DEBRIS, OR ANY EXCAVATION OR
- 9. DURING CONSTRUCTION NO OBJECTS SHALL BE ATTACHED TO ANY TREE DESIGNATED TO BE RETAINED AND PROTECTED.
- 10. PROPOSED TRENCHING AND EXCAVATION AROUND TREES SHALL BE COORDINATED WITH CONSULTING ARBORIST.
- 11. WHERE TRENCHING IS REQUIRED WITHIN CRITICAL ROOT ZONE, TUNNEL UNDER OR AROUND ROOTS BY HAND DIGGING OR BORING. DO NOT CUT MAIN LATERAL ROOTS OR TAP ROOTS. CLEANLY CUT/SEVER SMALLER ROOTS. RELOCATE ROOTS IN BACKFILL AREAS WHEREVER POSSIBLE.
- 12. DO NOT ALLOW EXPOSED ROOTS TO DRY OUT BEFORE PERMANENT BACKFILL IS PLACED, PROVIDE TEMPORARY EARTH COVER, OR PACK WITH PEAT MOSS AND WRAP WITH BURLAP. WATER AND MAINTAIN MOIST CONDITION UNTIL RELOCATED AND COVERED WITH BACKFILL.
- 13. FOR TREES TO BE PROVIDED UNDER SEPARATE PERMIT: IF TREES ARE INSTALLED PRIOR TO SITE WORK FOR THIS PROJECT, PROVIDE TREE AND VEGETATION PROTECTION AS SHOWN.

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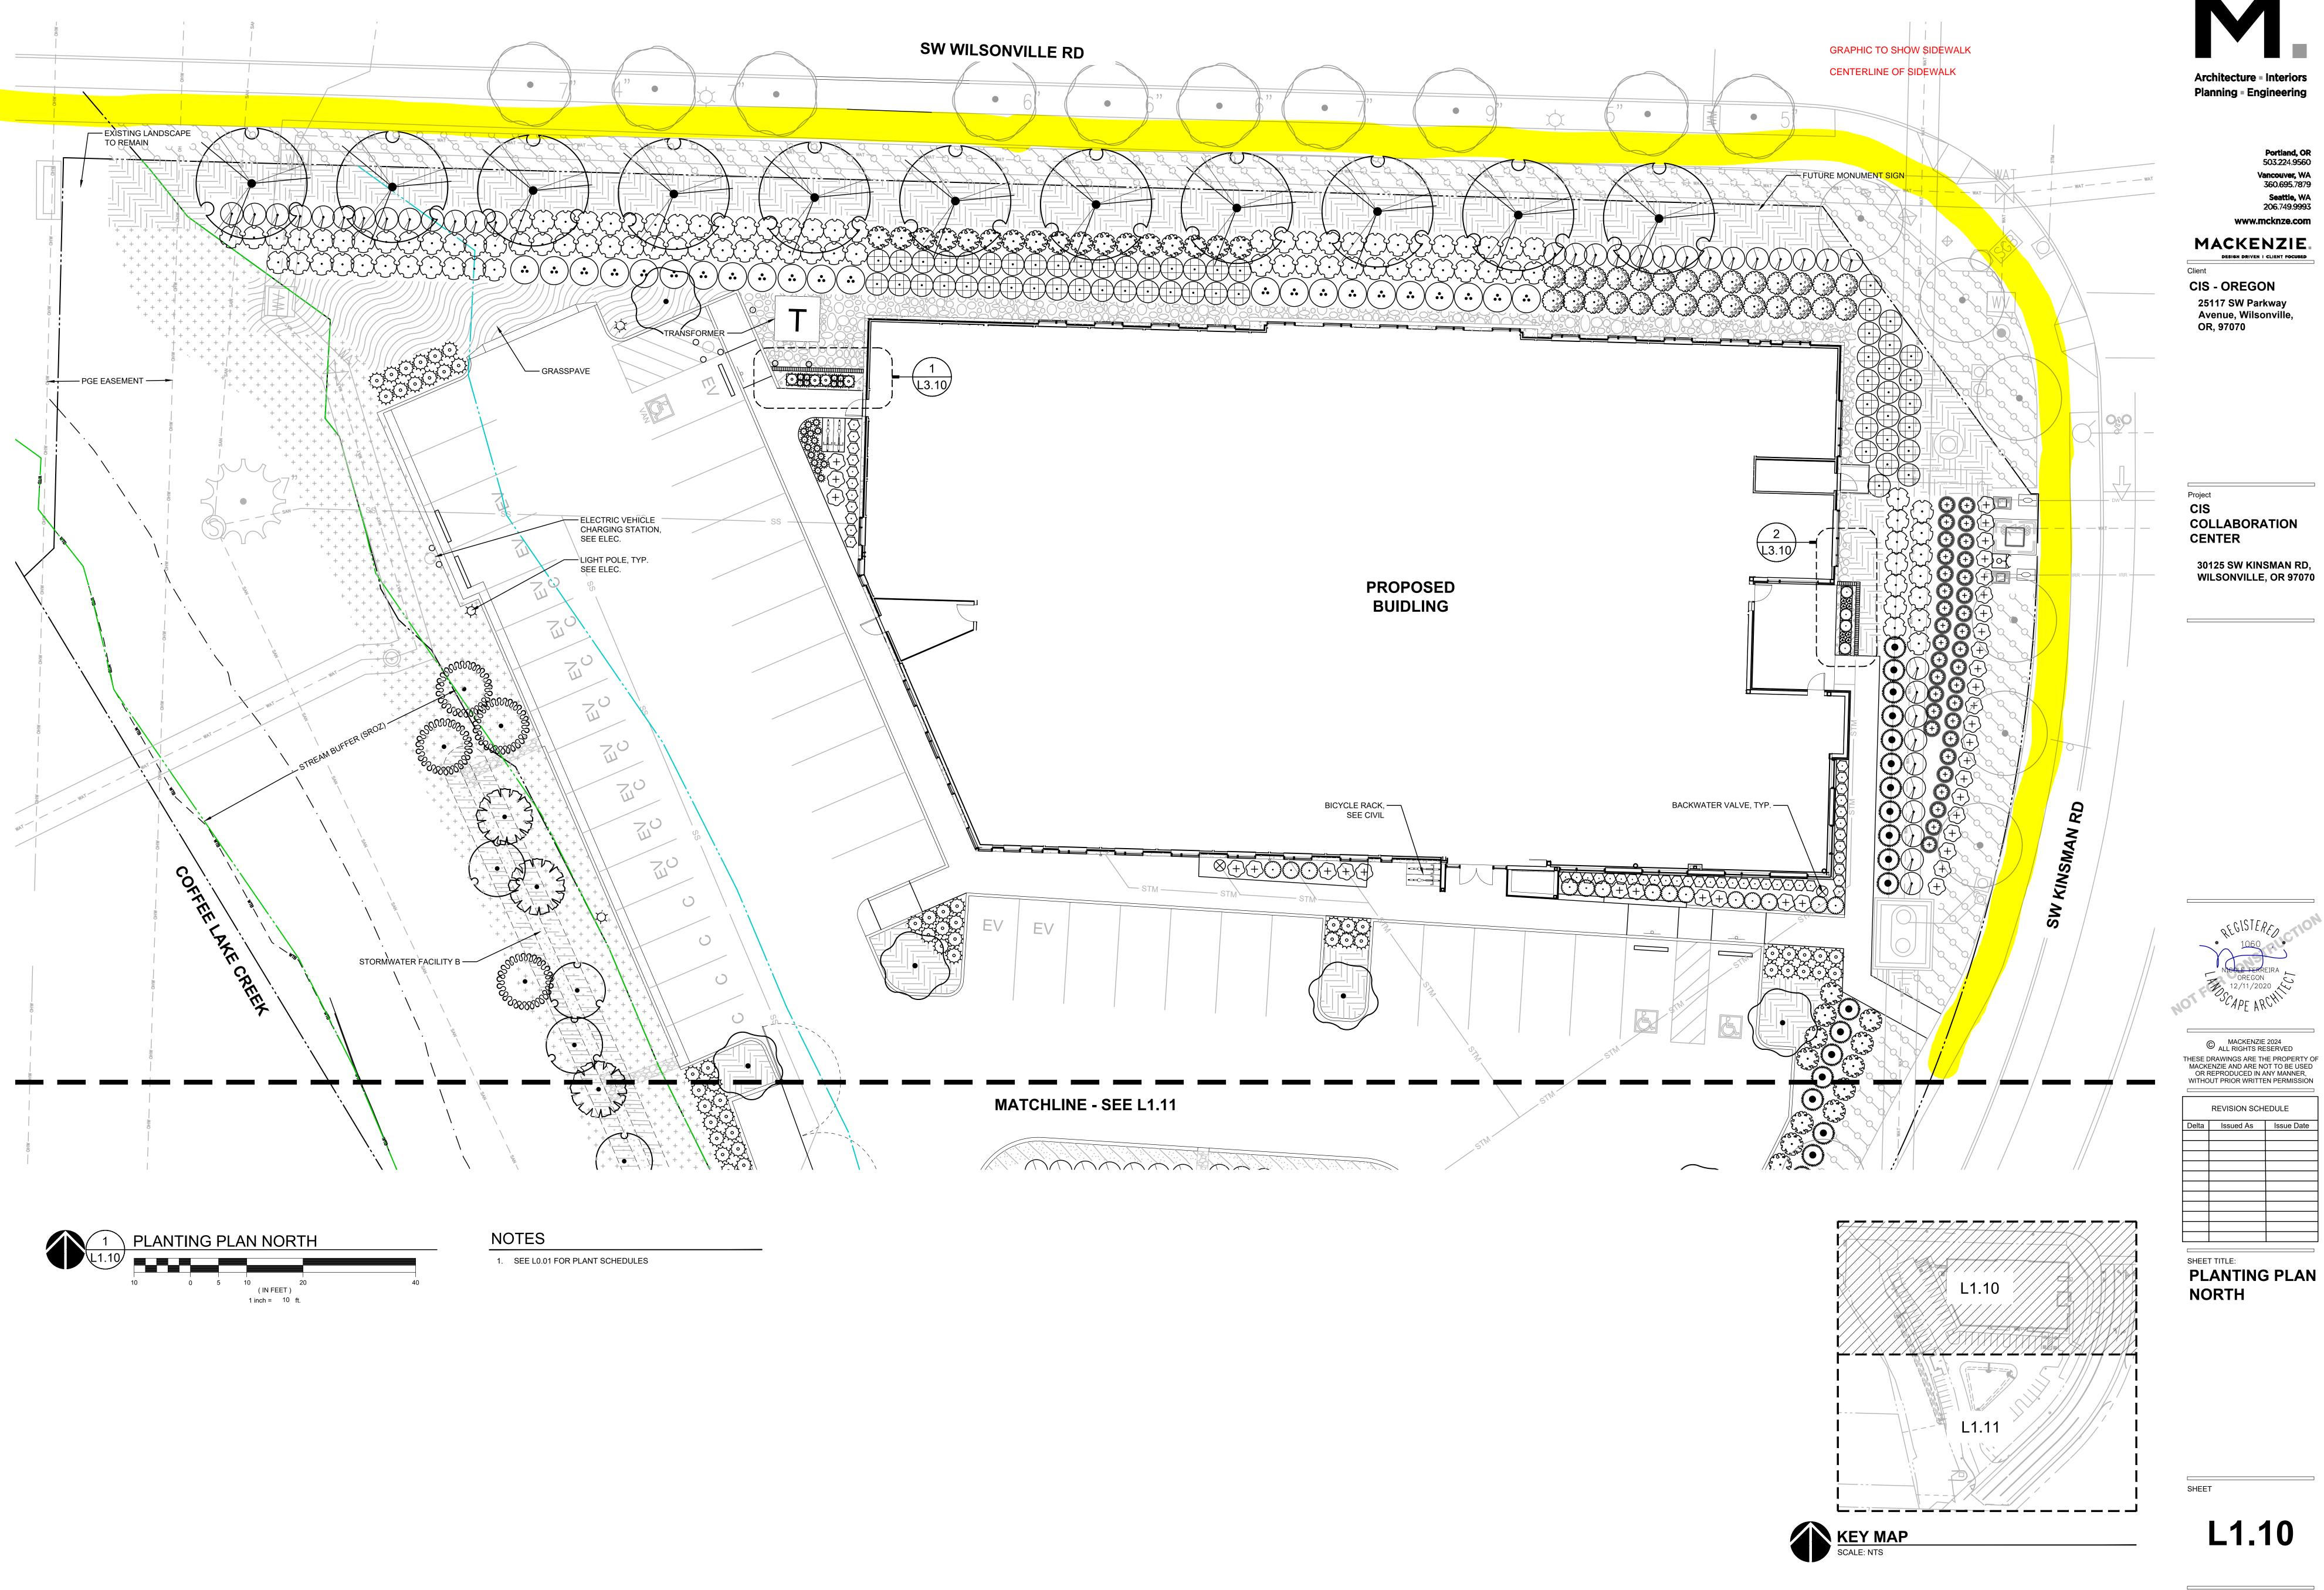
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TREE AND
VEGETATION
PROTECTION
PLAN

SHEE

L0.03





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Avenue, Wilsonville,
OR, 97070

Project
CIS
COLLABORATION
CENTER

30125 SW KINSMAN RD, WILSONVILLE, OR 97070

1060
NICOLE FERREIRA
OREGON
12/11/2020
SCAPE ARCHI

MACKENZIE 2024
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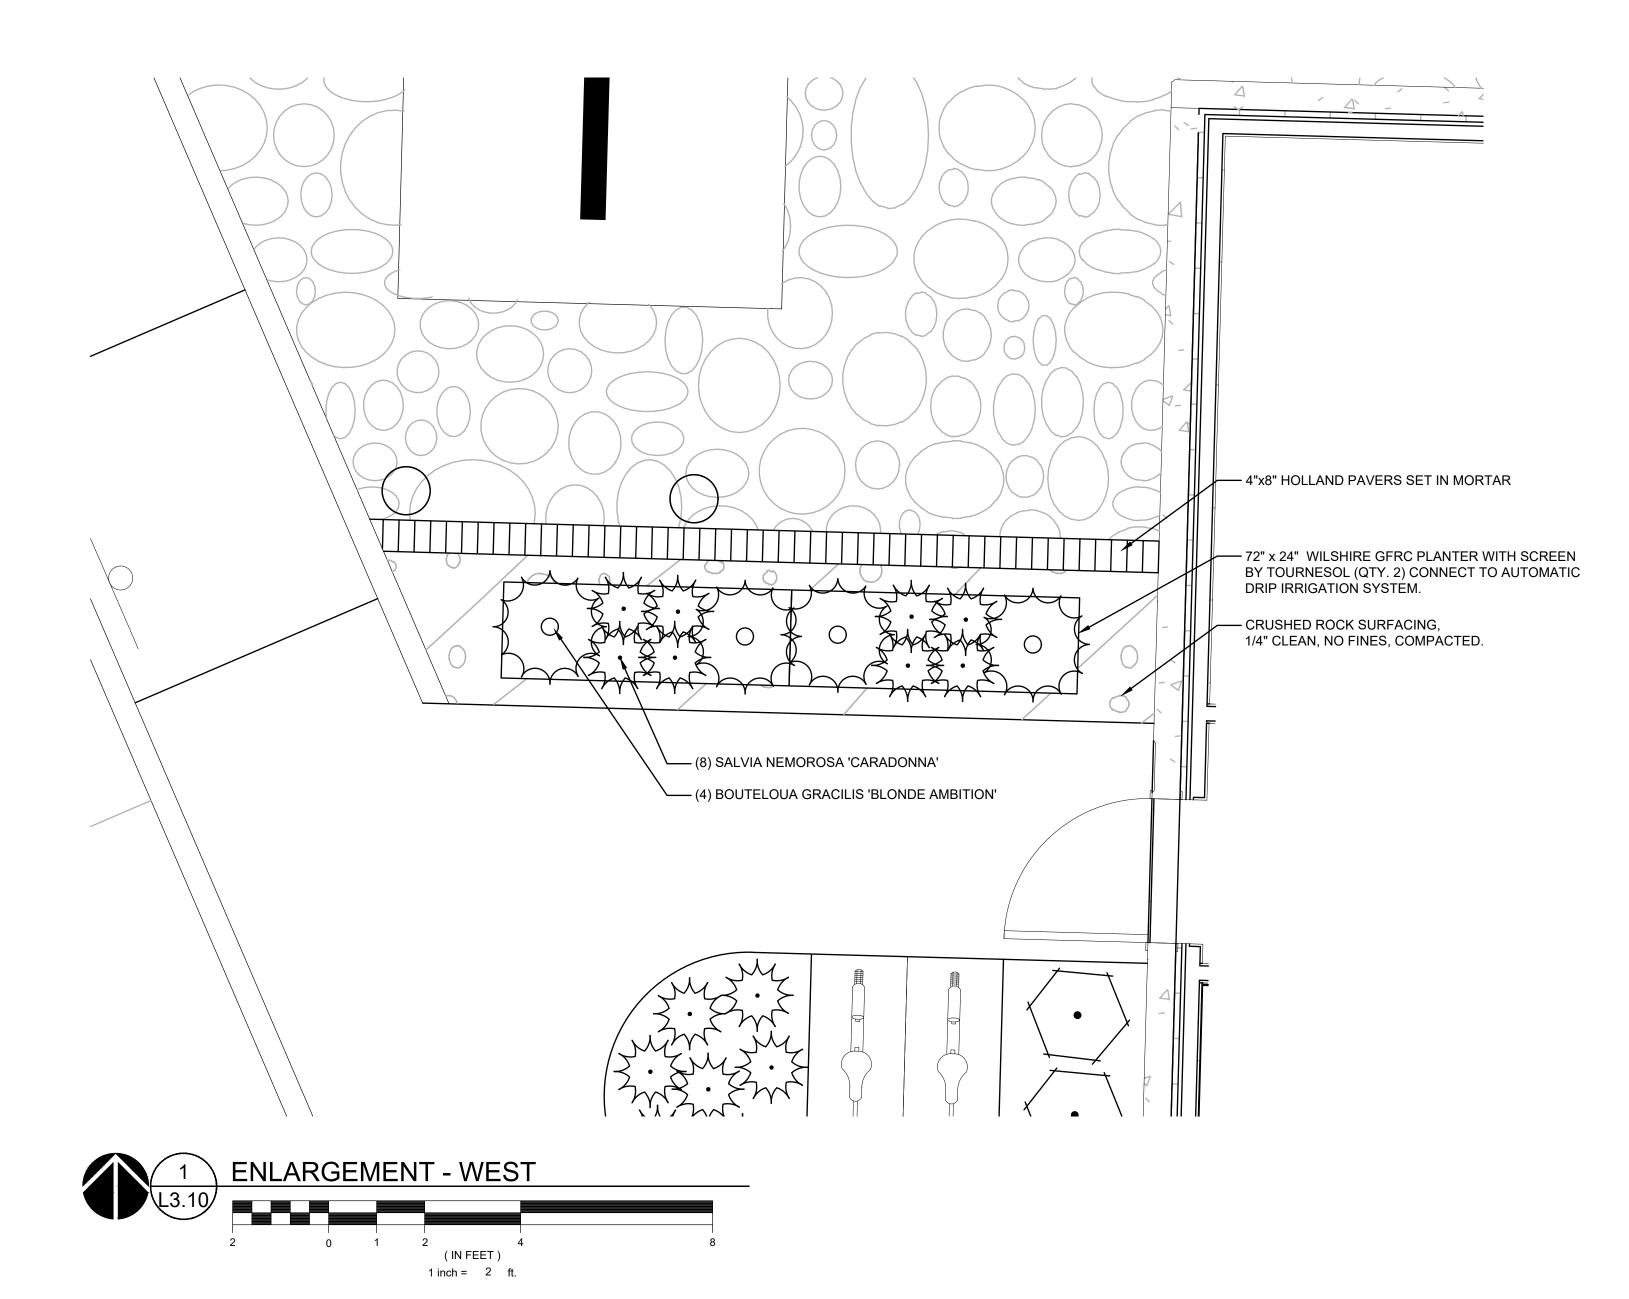
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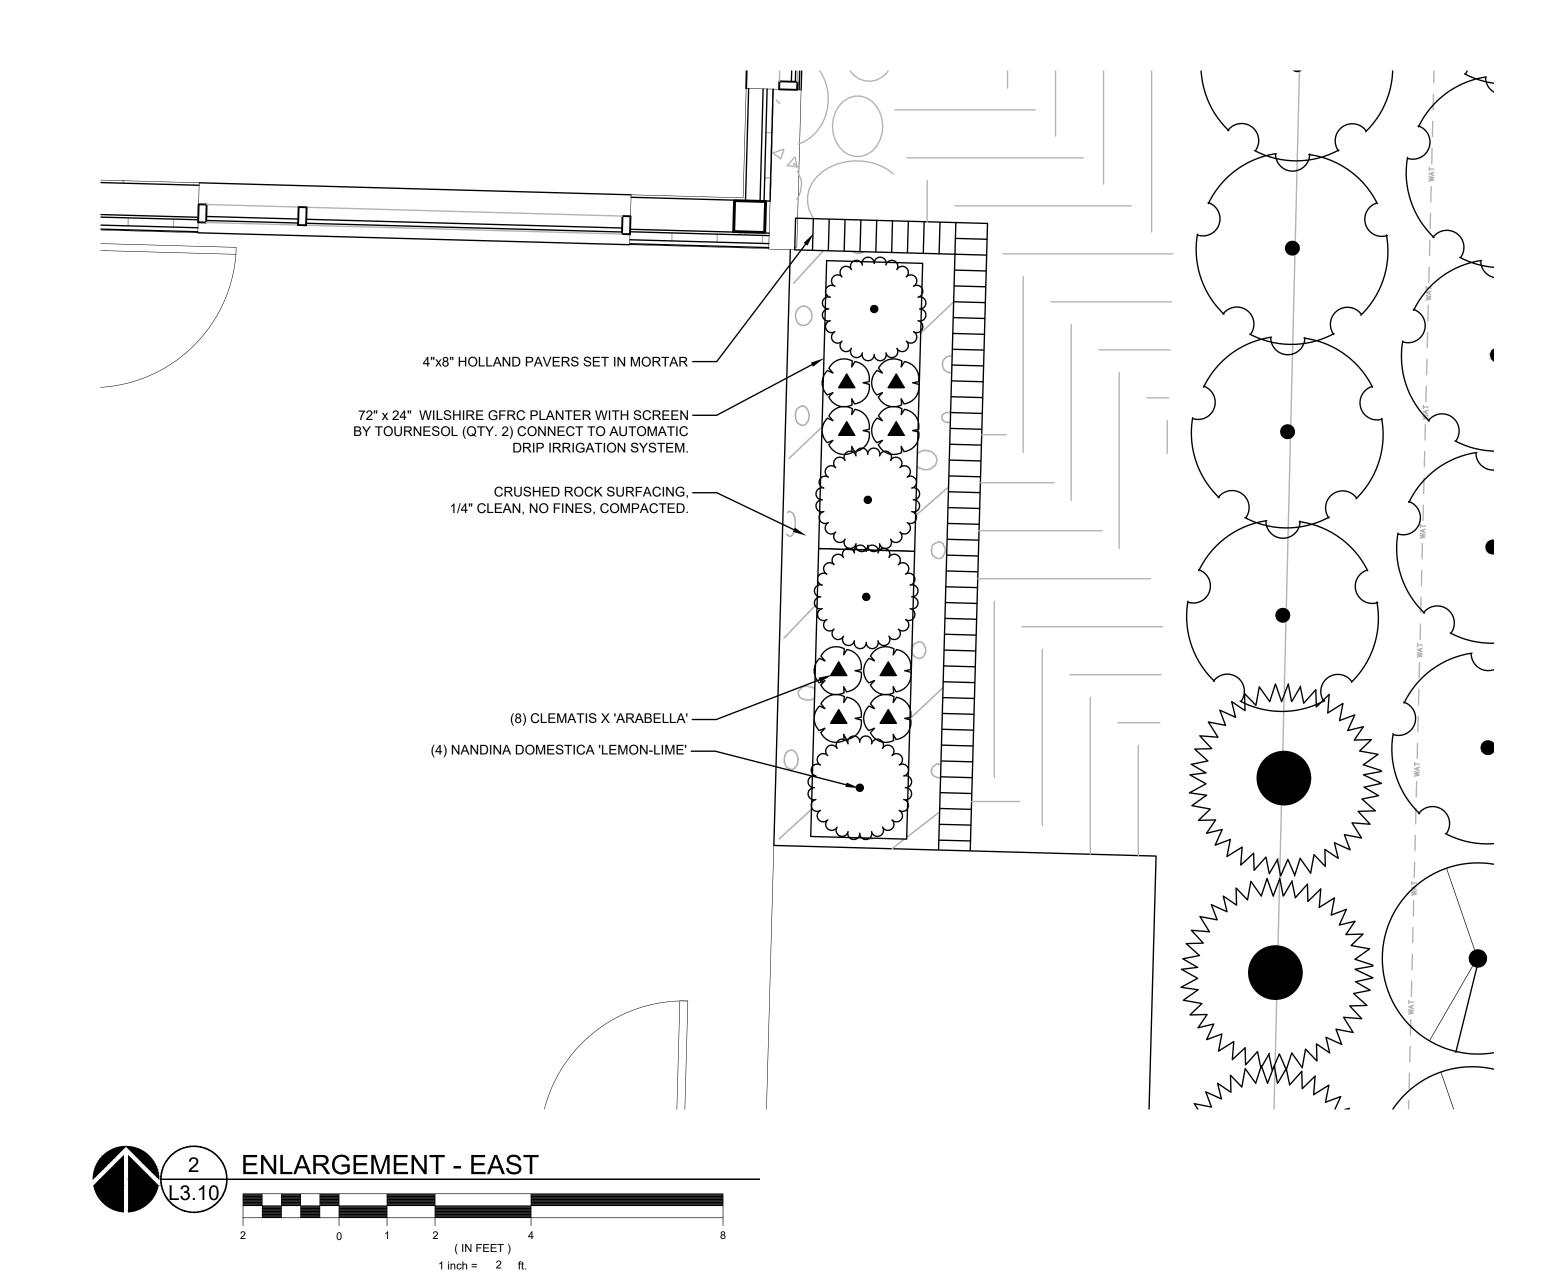
Delta Issued As Issue Date

PLANTING PLAN
SOUTH

SHEET

L1.11





Portland, OR 503.224.9560 Vancouver, WA 360.695.7879 Seattle, WA 206.749.9993 www.mcknze.com

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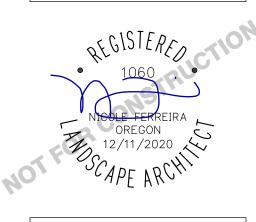
Client

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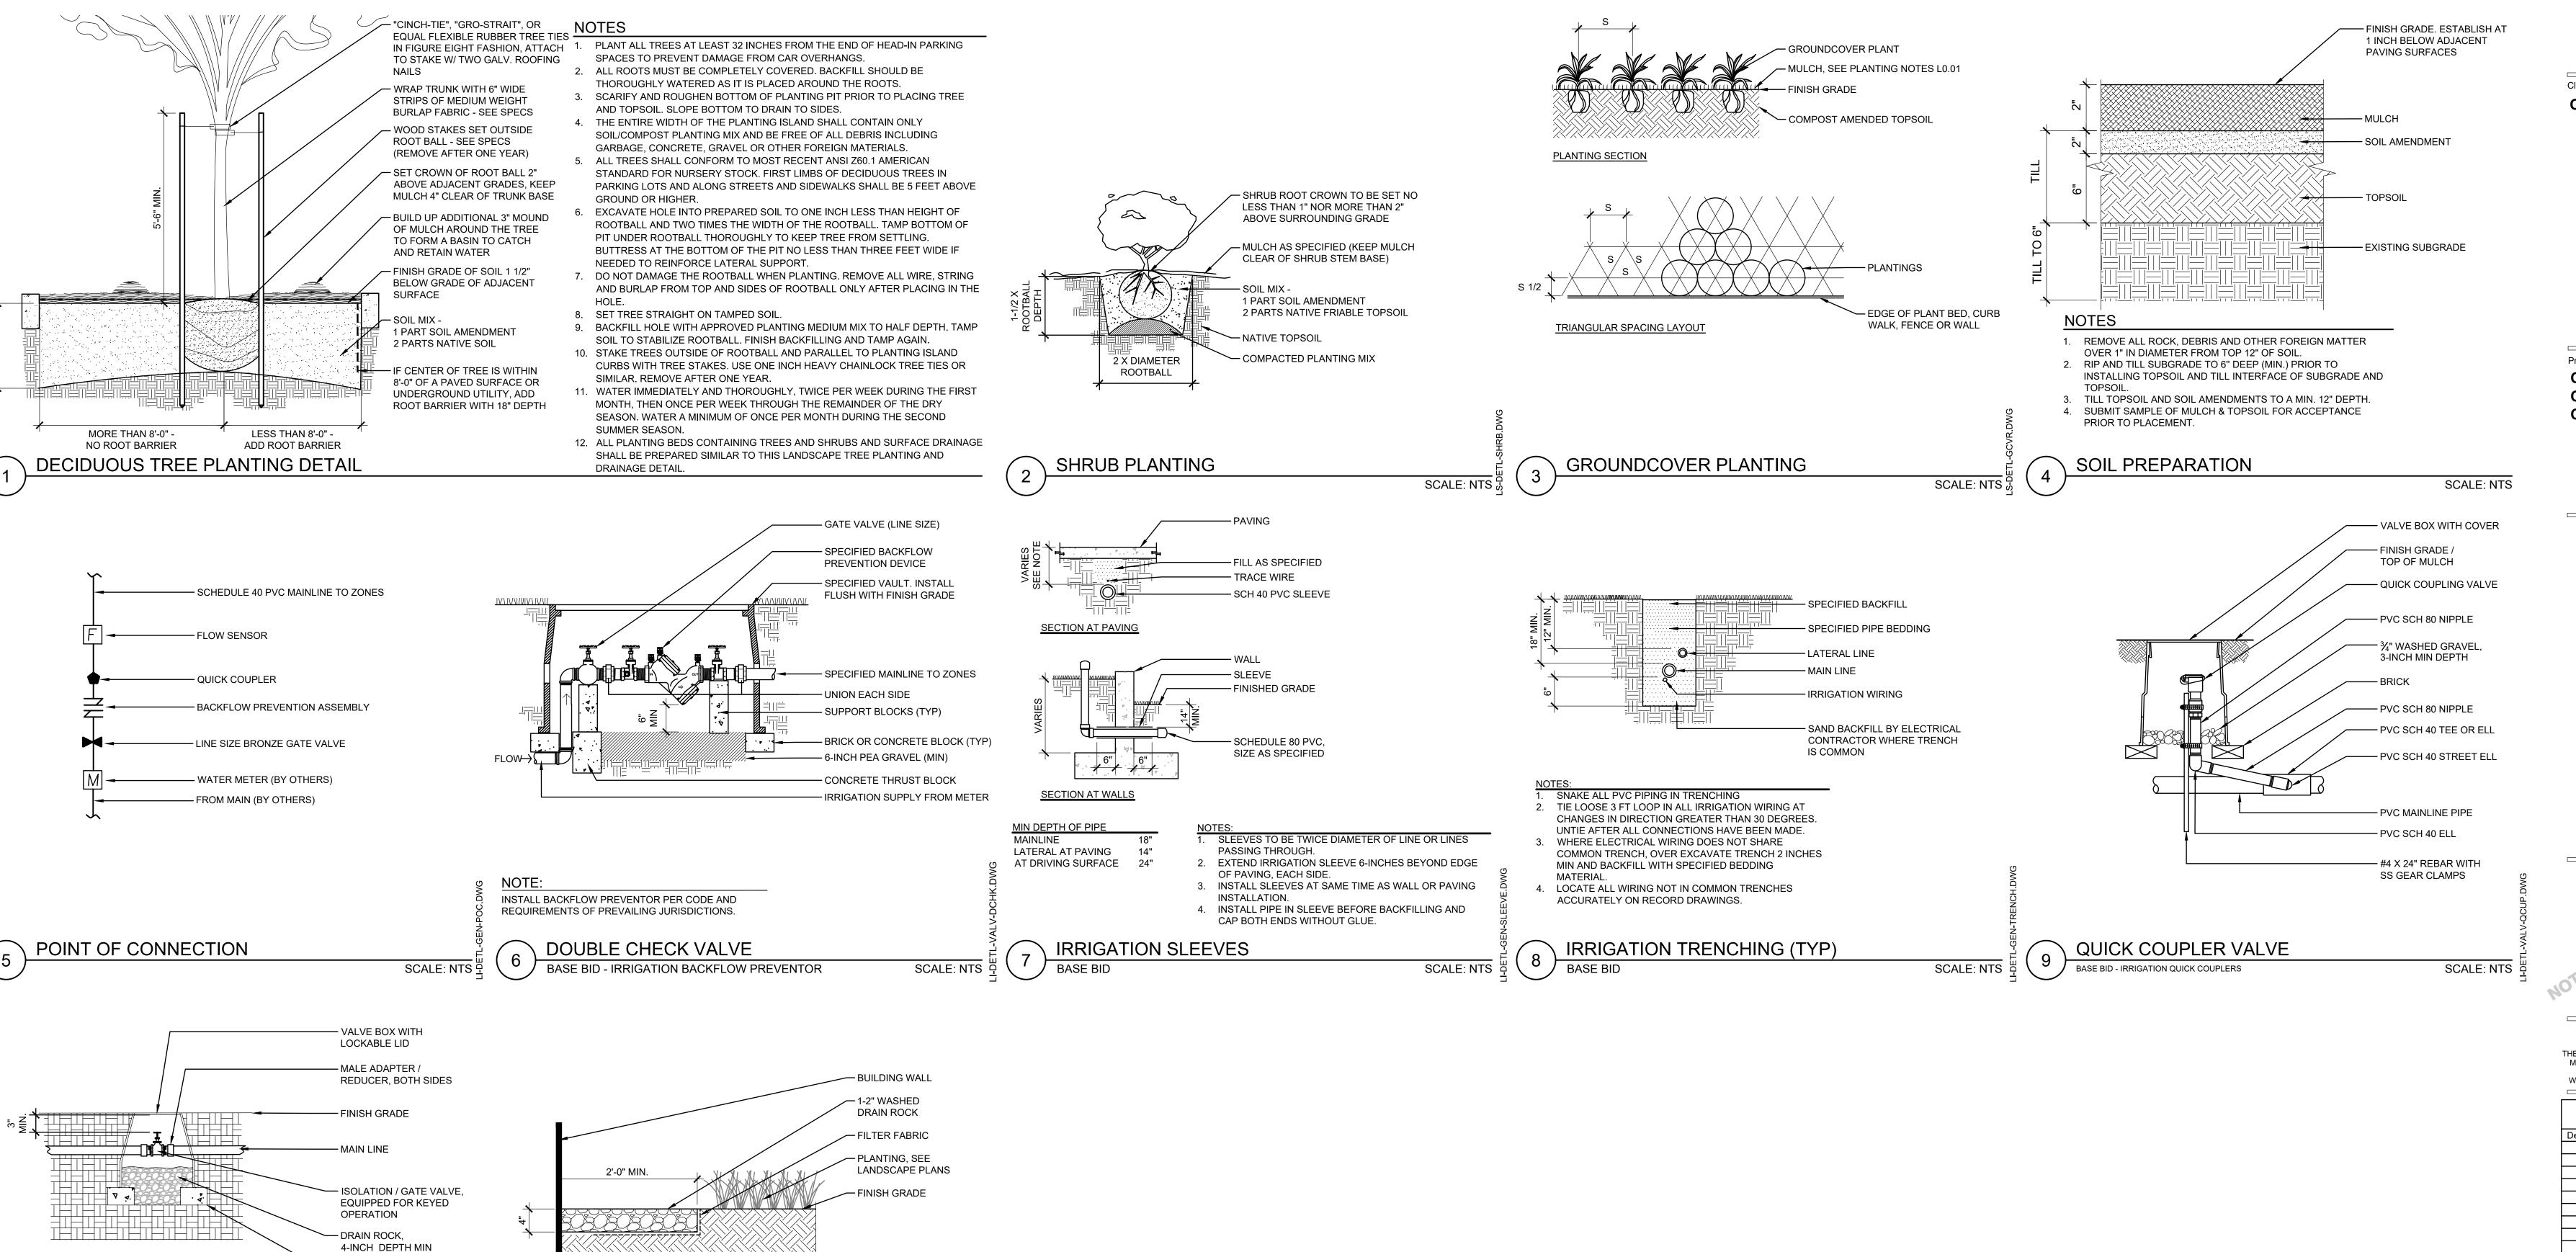
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REVISION SCHEDULE		
Delta	Issued As	Issue Date
		<u>ļ</u>

SHEET TITLE:
ENLARGEMENTS

SHEE

L3.10



BRICK OR CONC. BLOCK

ROCK MULCH MAINTENANCE BAND

SCALE: NTS

NOTES:

1. PVC ADAPTER AND FITTINGS TO BE SAME SIZE

AS ISOLATION VALVE

(10) ISOLATION / GATE VALVE

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Project COLLABORATION CENTER


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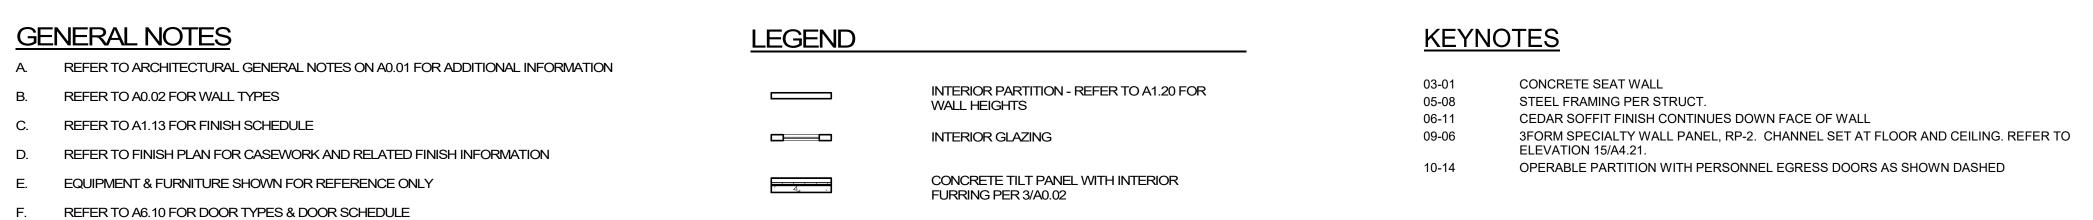
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SHEET TITLE:

DETAILS

L5.10



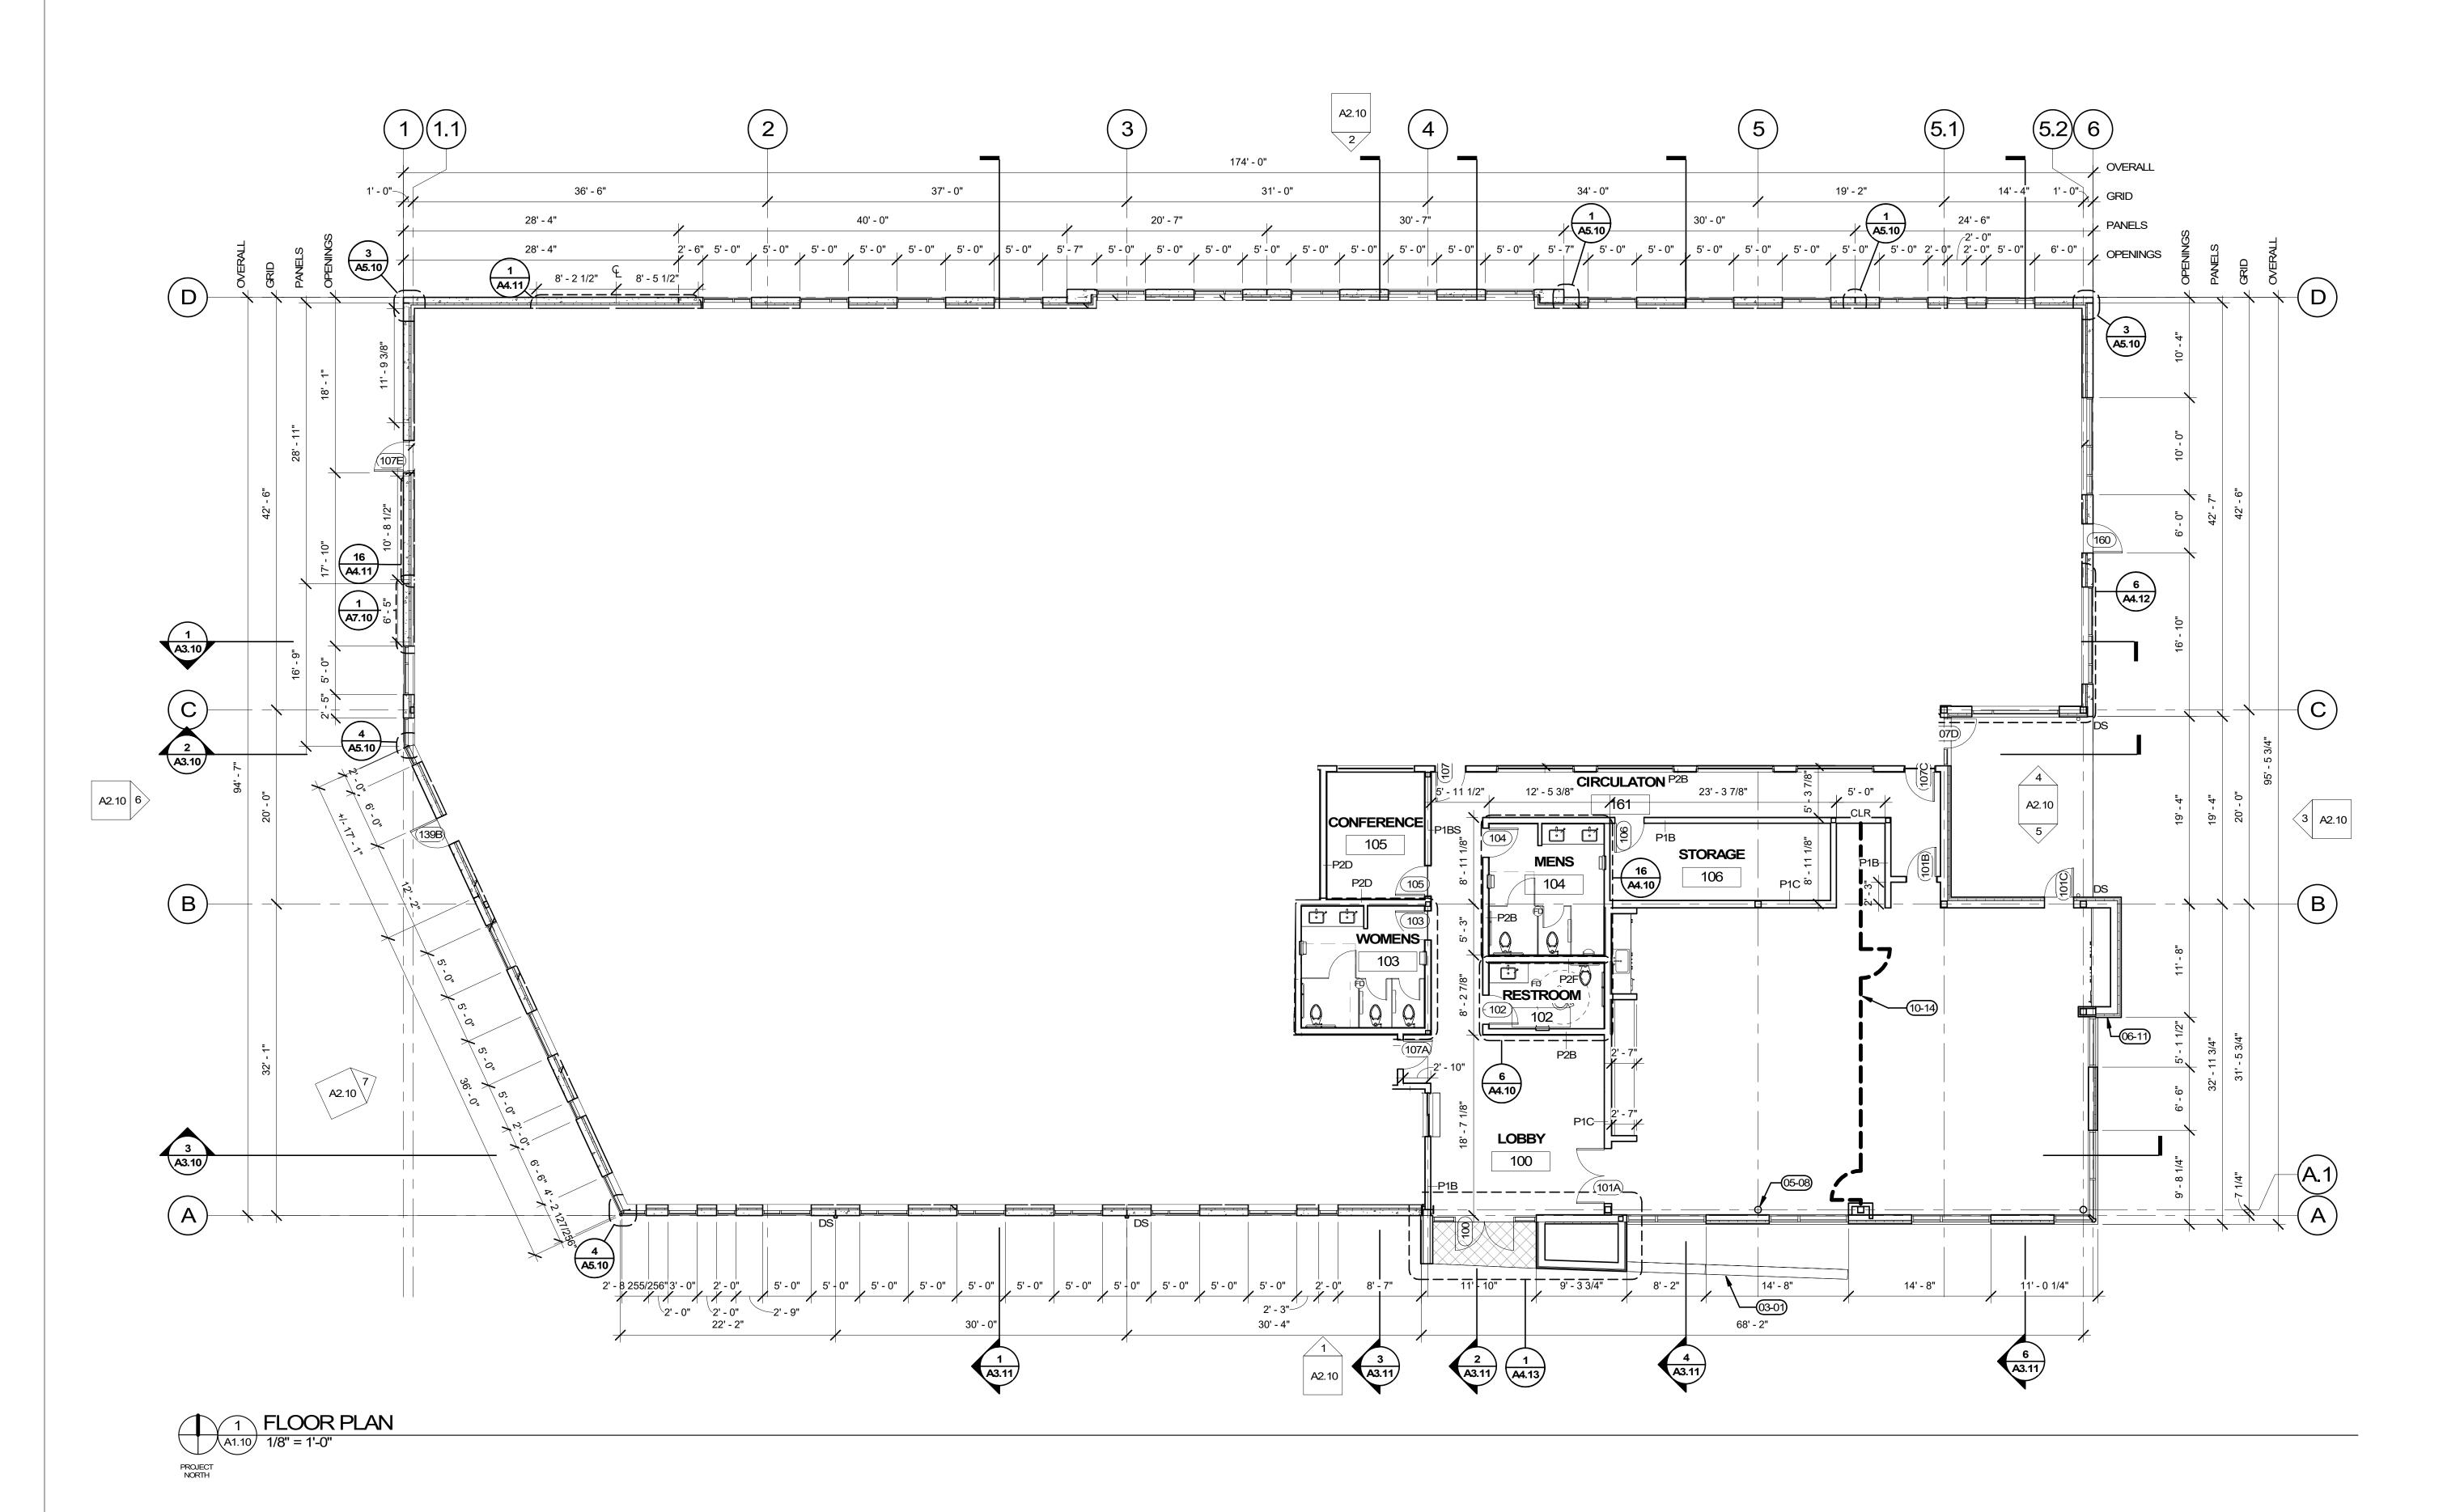

EXTERIOR FIBER CEMENT RAINSCREEN

WALL PER 1/A5.11

G. ALL PENETRATIONS IN THE WALL INCLUDING OUTLETS, DUCTS AND PIPING SHOULD BE CAULKED

AIRTIGHT WITH ACOUSTICAL SEALANT.

H. INTERIOR PARTITION CONTROL JOINTS PER DETAIL

I. ALL INTERIOR PARTITIONS TO BE P1A UNLESS OTHERWISE NOTED.

Planning - Engineering

Portland, OR 503.224.9560 **Vancouver, WA** 360.695.7879 **Seattle, WA** 206.749.9993


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DESIGN DRIVEN | CLIENT FOCUSED

CIS - OREGON 25117 SW Parkway Avenue, Wilsonville, OR 97070

CIS COLLABORATION CENTER 30125 SW KINSMAN ROAD, WILSONVILLE, OR 97070

Mechanical/Electrical INTERFACE ENGINEERING, INC.

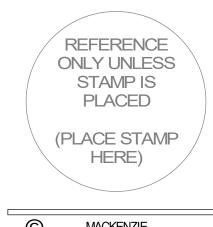


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> REVISION SCHEDULE Issued As Issue Date

FLOOR PLAN

A1.10

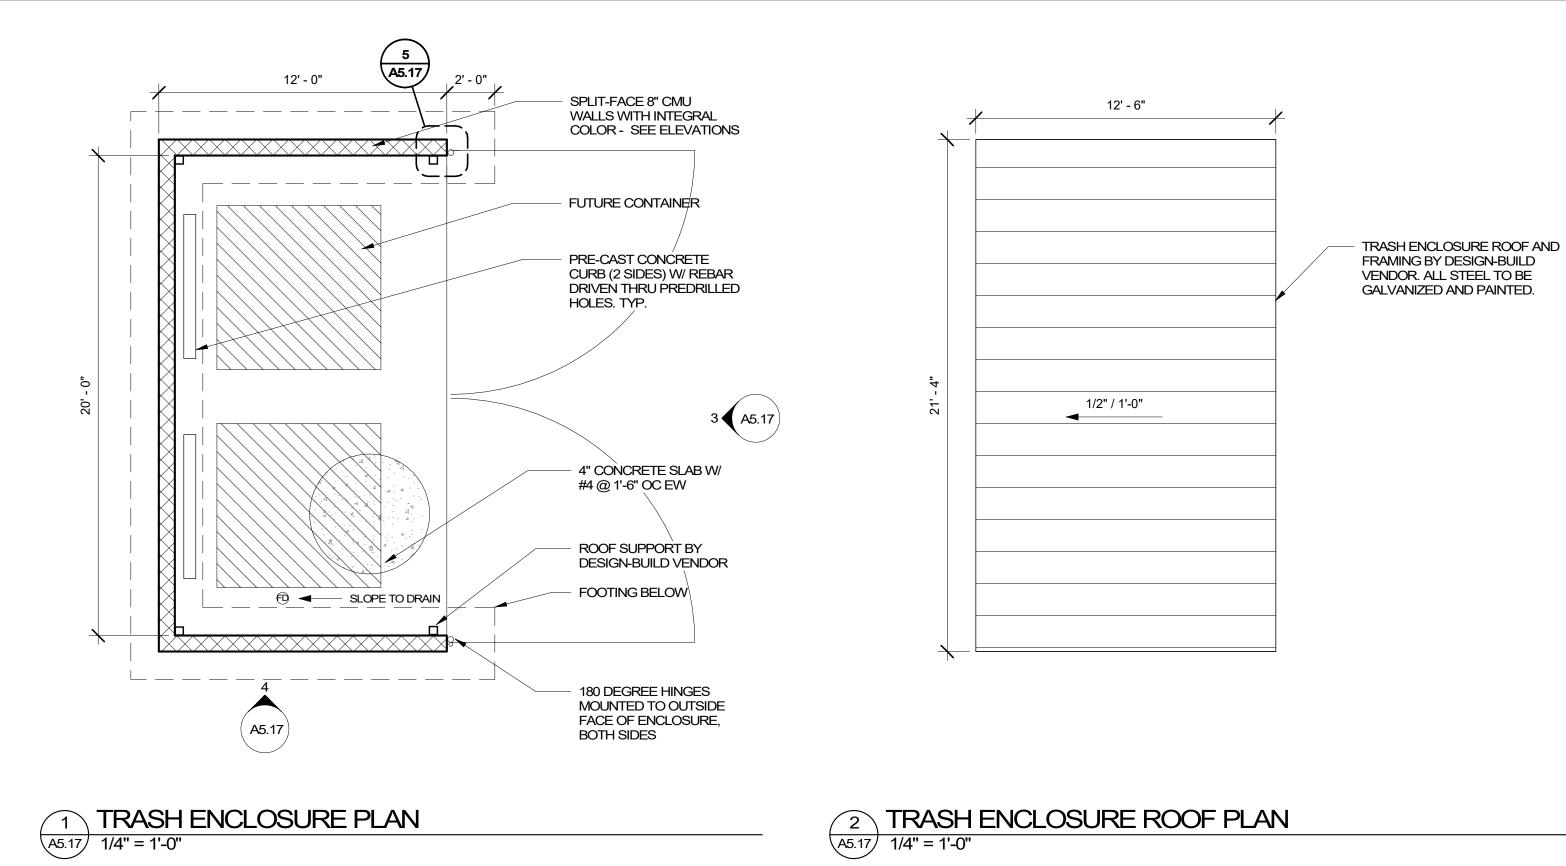

1/4" BENT PL X 6' - 2" W/

1/2"ØX24" DBA@TOP

@ 48" OC PAINT TO

MATCH GATE

- 1 1/2" PAIR 6x6

3/16

WELDING HINGES

EQUAL PAINT TO MATCH GATE

HAGAR 1850 LP OR


CHAMFER EDGETO ALLOW BENT

PLATE TO SIT


AND BOTTOM CELL AND


(2) #4 VERTICAL

@FIRST THREE

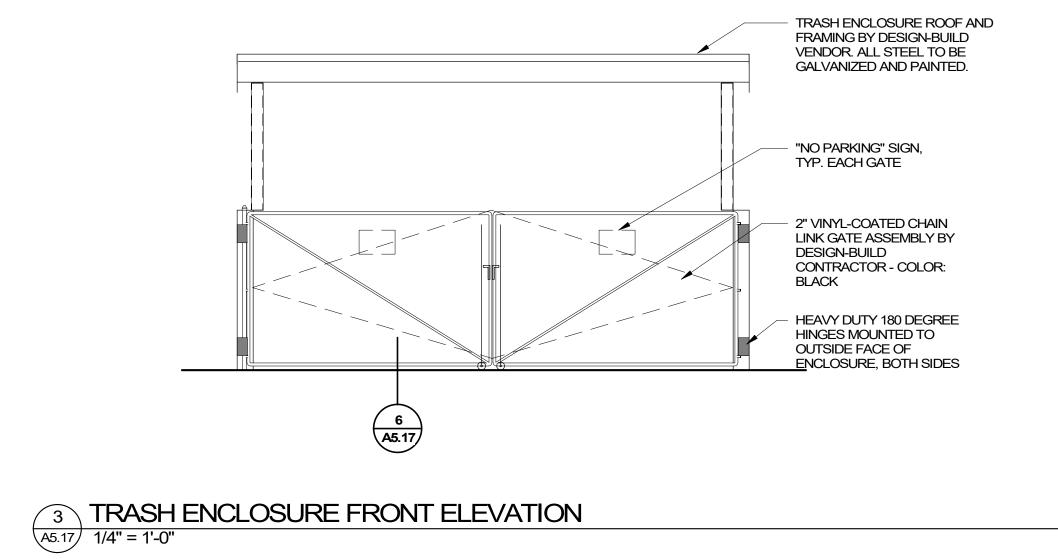

- CAST CAP PIECE, TYP.

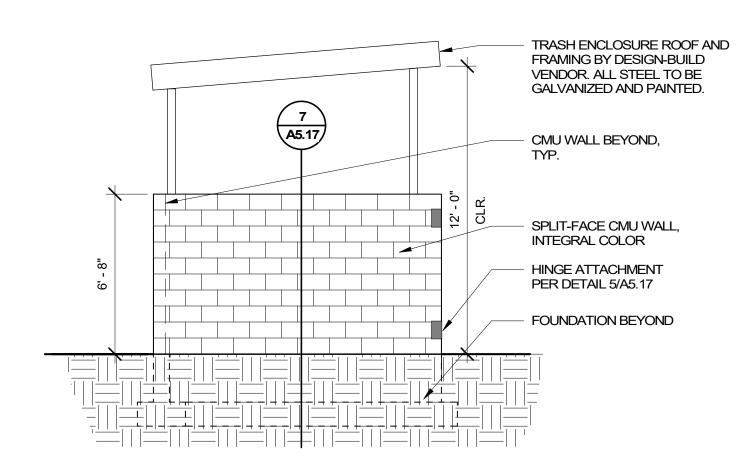

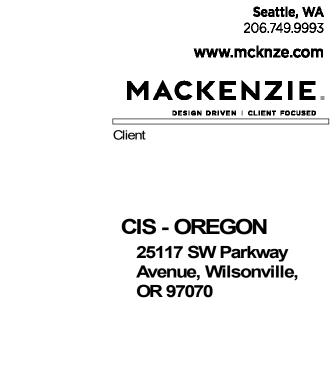

Planning - Engineering

COLLABORATION

30125 SW KINSMAN

INTERFACE ENGINEERING, INC.

ROAD, WILSONVILLE,

CENTER


OR 97070


Mechanical/Electrical


Portland, OR 503.224.9560


Vancouver, WA 360.695.7879

TRASH ENCLOSURE SIDE ELEVATION A5.17 1/4" = 1'-0"

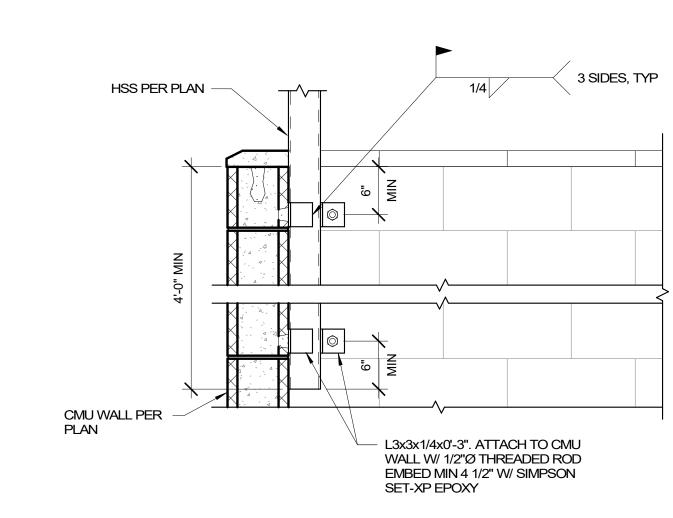

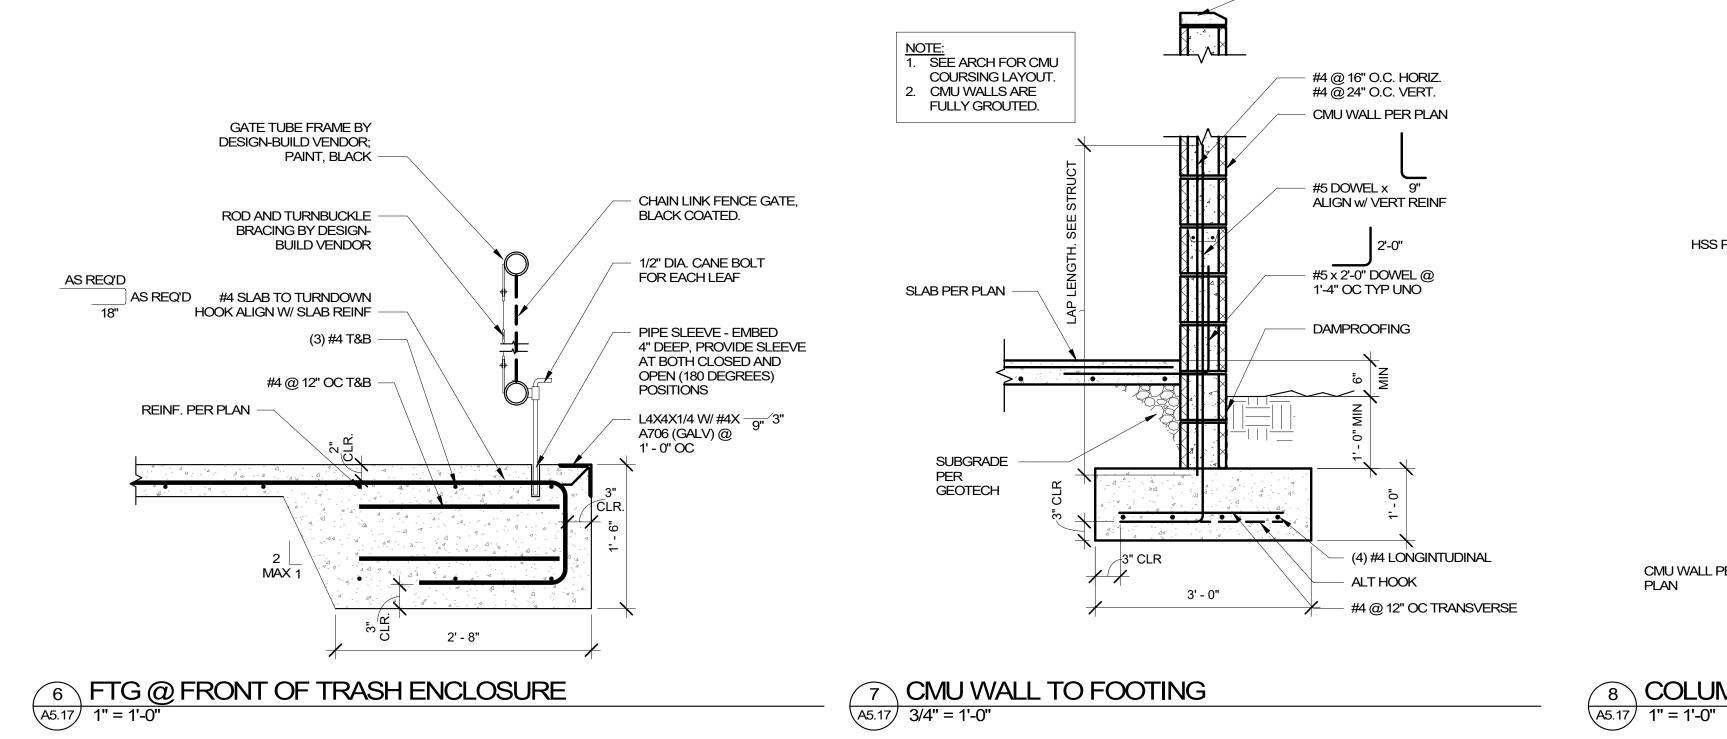

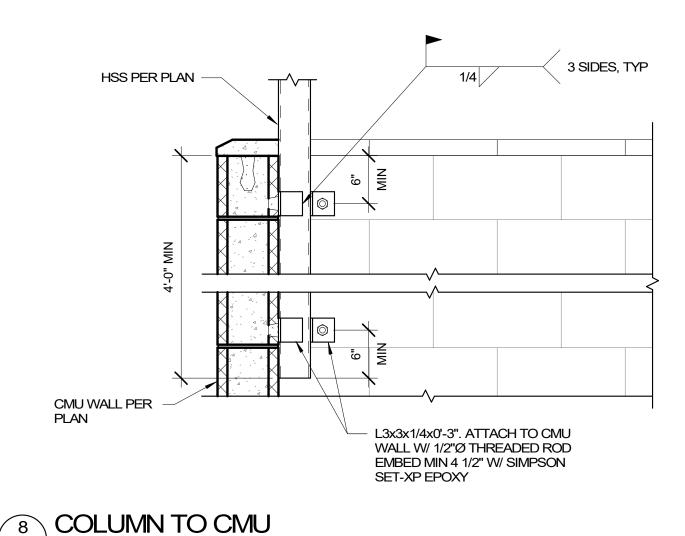

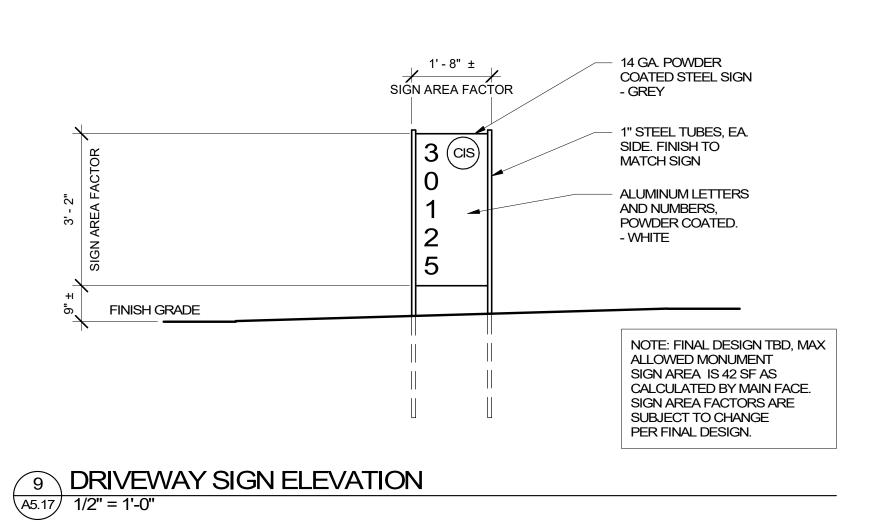

5 GATE HINGE A5.17 1 1/2" = 1'-0"




(PLACE

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SHEET TITLE: SITE DETAILS

A5.17




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CIS COLLABORATION CENTER

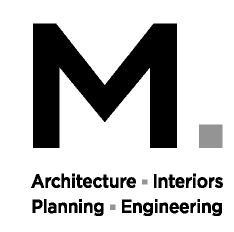Mechanical/Electrical



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REVISION SCHEDULE

SITE PLAN -**ELECTRICAL**

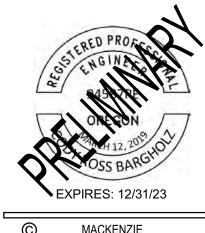INTERFACE ENGINEERING PROJECT 2022-0367 CONTACT Jason Matheis

> Portland, OR 97204 TEL 503.382.2266 www.interfaceengineering.com

100 SW Main Street, Suite 1600

E1.10



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Finding A59:

A59. Adjacent streets are fully developed to City standards and no additional street improvements are warranted.

Condition PF4:

Prior to Issuance of the Public Works Permit: Submit site plans to Engineering showing street improvements including pavement restoration, curb, planter strip, street tree along Wilsonville Road; and pavement, sidewalk and driveway restoration, curb, planter strip, and water service connections along SW Kinsman Road. All street improvements shall be constructed, inspected and approved by the City.

Condition PF6:

PF 6. With the Public Works Permit application: Submit construction plans to Engineering showing the closure of the existing driveway onto SW Wilsonville Road. Restore concrete curb and gutter and install new street tree in planter strip. The development shall take access via an existing driveway approach on SW Kinsman Road.

Condition PF2:

PF 2. The Traffic Impact Study for the project (DKS, December 2023) found that all intersections impacted with the proposed development would operate above the City's acceptable the level of service (LOS) D. The driveway aisle length is less than the required 100 feet, however, there are no on-site circulation or safety concerns with the proposed 60-foot driveway aisle length.

"The applicant shall provide a technical memo supporting a Public Works Standards Variance request for a driveway less than 100 feet. The technical memo shall provide evidence that the requested driveway length can accommodate the vehicle queuing length."